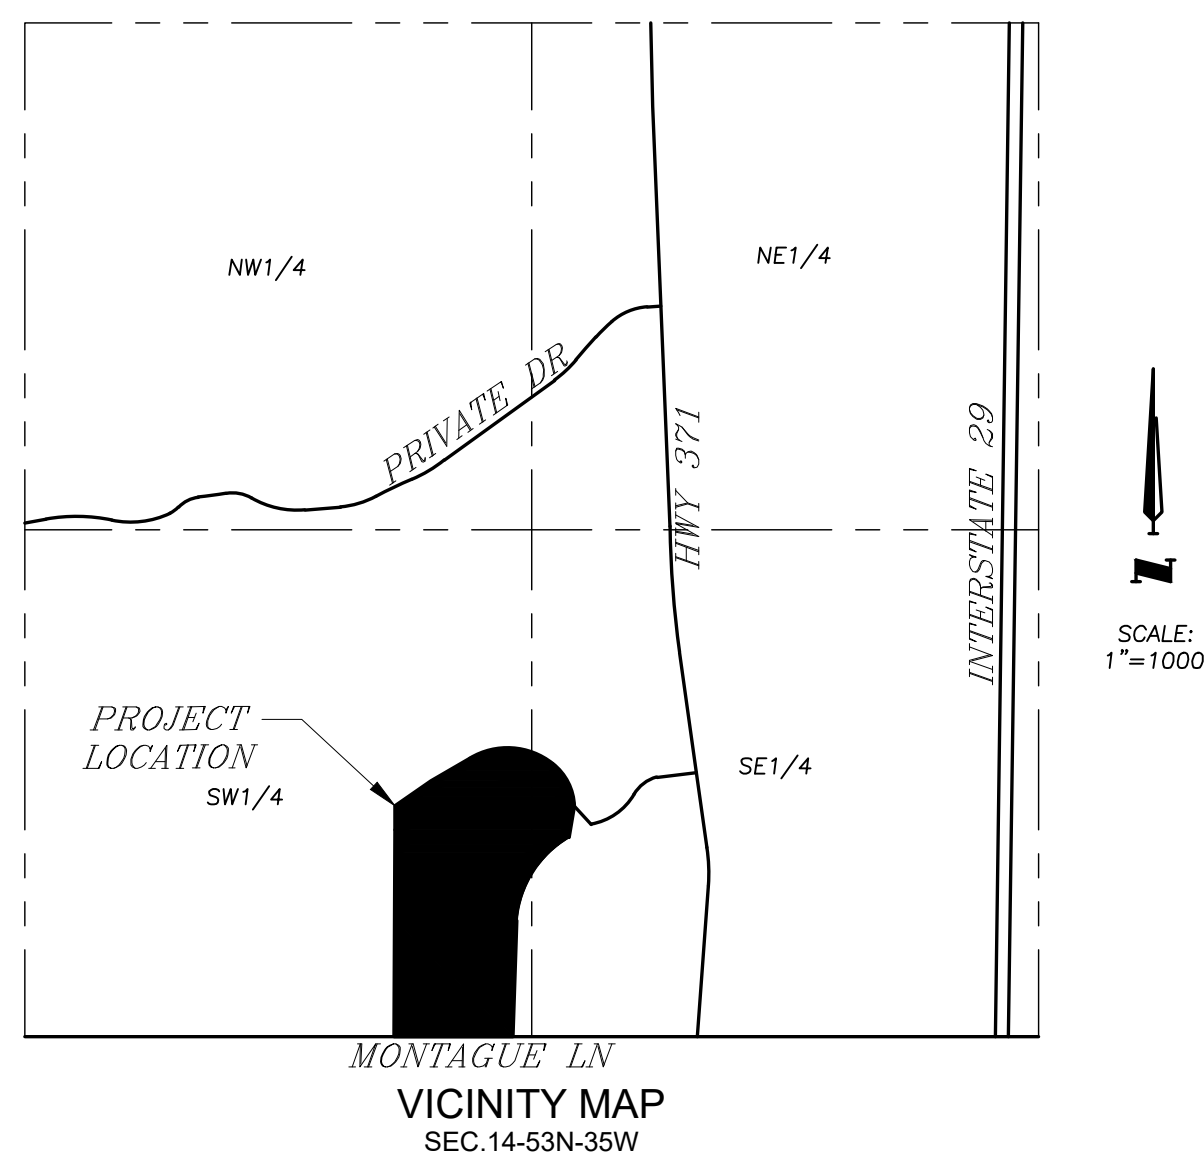


PLATTE RIDGE PARK - FOOTBALL COMPLEX IMPROVEMENTS SITE PLANS

**LOCATED IN
SECTION 14 TOWNSHIP 53N, RANGE 35W
PLATTE CITY, PLATTE COUNTY, MISSOURI**



LEGAL DESCRIPTION

FLOODPLAIN NOTE

WE HAVE REVIEWED THE "FLOOD INSURANCE RATE MAP", COMMUNITY PANEL NO. 2916SC0193D, EFFECTIVE APRIL 2, 2015, AS PUBLISHED BY FEDERAL EMERGENCY MANAGEMENT AGENCY. OUR REVIEW OF THIS MAP INDICATES THAT THIS PARCEL OF LAND DOES NOT LIE WITHIN A FLOODWAY.

NOTE:
SEE SHEET C001 FOR GENERAL NOTES.

UTILITY CONTACT INFORMATION

PLATTE COUNTY PARKS
PHONE: 816-858-3419

PLATTE WATER AND SEWER DISTRICT #9
PHONE: 1-844-992-8710

PLATTE-CLAY ELECTRIC COOPERATIVE
CONTACT: MIKE RICHEY - ENGINEER
EMAIL: MIKER@PCEC.COOP
PHONE: 816-903-7377




UTILITY STATEMENT:

THE UNDERGROUND UTILITIES SHOWN HAVE BEEN LOCATED FROM UTILITY INFORMATION AND EXISTING DRAWINGS. THE SURVEYOR MAKES NO GUARANTEE THAT THE UNDERGROUND UTILITIES SHOWN COMPRISE ALL SUCH UTILITIES IN THE AREA, EITHER IN SERVICE OR ABANDONED. THE SURVEYOR FURTHER DOES NOT WARRANT THAT THE UNDERGROUND UTILITIES SHOWN ARE IN THE EXACT LOCATION INDICATED ALTHOUGH HE DOES CERTIFY THAT THEY ARE LOCATED AS ACCURATELY AS POSSIBLE FROM INFORMATION AVAILABLE. THE SURVEYOR HAS NOT PHYSICALLY LOCATED THE UNDERGROUND UTILITIES. BEFORE YOU DIG

CONTACT MISSOURI ONE-CALL: 811 OR 1-800-344-7483.

CLIENT:	PLATTE COUNTY PARKS AND RECREATION
CONTACT NAME:	CHRIS ORYSHYN
ADDRESS:	415 THIRD STREET PLATTE CITY, MO 64079
PHONE:	816.858.3419
EMAIL:	CORYSHYN@CO.PLATTE.MO.US
<u>PLANNER & CIVIL ENGINEER</u>	
MCCLURE ENGINEERING	
CONTACT NAME:	BRIAN KEMP
ADDRESS:	1700 SWIFT ST STE 100 NORTH KANSAS CITY, MO 64116
PHONE:	816.756.0444 EXT. 2709
EMAIL:	BKEMP@MCCLUREVISION.COM
<u>SURVEYOR</u>	
MCCLURE ENGINEERING	
CONTACT NAME:	STEVE WHITAKER
ADDRESS:	1700 SWIFT ST STE 100 NORTH KANSAS CITY, MO 64116
PHONE:	816.756.0444 EXT. 2850
EMAIL:	SWHITAKER@MCCLUREVISION.COM
<u>ARCHITECT</u>	
WSKF ARCHITECTS	
CONTACT NAME:	DALYN NOVAK
ADDRESS:	110 ARMOUR ROAD NORTH KANSAS CITY, MO 64116
PHONE:	816.300.4101
EMAIL:	DNOVAK@WSKFARCH.COM
<u>M.E.P.</u>	
PKMR ENGINEERS	
CONTACT NAME:	MIKE RAAF
ADDRESS:	13300 WEST 98TH STREET LENEXA, KS 66215
PHONE:	913.492.2400
EMAIL:	MIKE.RAAF@PKMRENG.COM

SHEET LIST	
SHEET NUMBER	SHEET TITLE
C000	COVER SHEET
C001	GENERAL NOTES
C002	EXISTING CONDITIONS
C003	DEMOLITION PLAN
C100	EROSION CONTROL PLAN
C200	SITE PLAN
C201	DIMENSION PLAN
C202	DIMENSION PLAN
C203	DIMENSION PLAN
C204	DIMENSION PLAN
C300	GRADING PLAN
C301	ENLARGED GRADING PLAN
C302	ENLARGED GRADING PLAN
C303	ENLARGED GRADING PLAN
C304	ENLARGED GRADING PLAN
C400	UTILITY PLAN
C401	STORM PLAN & PROFILES
C402	STORM PLAN & PROFILES
C403	DRAINAGE PLAN
C500	SANITARY SEWER PLAN & PROFILE
C501	SEWER DETAILS
C600	DETAILS
C601	DETAILS
C602	DETAILS
C603	DETENTION DETAILS
C604	DETENTION DETAILS
G0.01	CODE REVIEW
A1.01	FIRST FLOOR PLAN
A2.01	ELEVATIONS / BUILDING SECTIONS
A3.01	WALL SECTIONS & DETAILS
A4.01	INTERIOR ELEVATIONS
A5.01	REFLECTED CEILING PLAN
A6.01	DOOR SCHEDULE
A7.01	FINISH SCHEDULE
MEP.0	COVER SHEET
MEP.1	SITE PLAN
M1.01	FLOOR PLAN - HVAC
M2.01	MECHANICAL - SCHEDULES & DETAILS
P1.01	FLOOR PLAN - PLUMBING
P2.01	PLUMBING - SCHEDULES
P3.01	PLUMBING - DETAILS
E1.01	FLOOR PLAN - LIGHTING
E1.02	FLOOR PLAN - POWER
E2.01	ELECTRICAL - SCHEDULES & DETAILS
S001	GENERAL NOTES
S100	FOUNDATION & ROOF FRAMING PLANS
S200	FOUNDATION SECTIONS & DETAILS
S201	SECTIONS & DETAILS

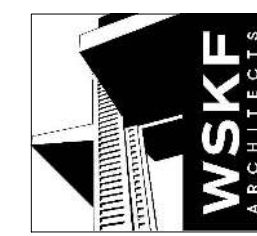

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MISSOURI CERTIFICATE OF
AUTHORITY NO. E-2006023253
EXPIRES: DECEMBER 31, 2022



REVISIONS

PROJECT INFO
210266-000

ENGINEER DRAWN BY CHECKED BY
 AVD AVD

PLATTE RIDGE PARK
FOOTBALL COMPLEX IMPROVEMENTS
17130 HIGHWAY 371, PLATTE CITY, MO 64079


COVER SHEET

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DRAWING NO.

C000

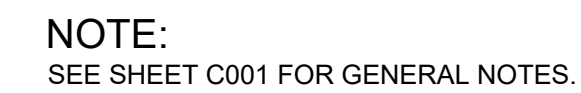- 1 EXISTING FOOTBALL FIELD
- 2 EXISTING BLEACHERS
- 3 EXISTING WATER METER
- 4 EXISTING SCORE BOARD
- 5 EXISTING CLEANOUT
- 6 EXISTING FENCE



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C002



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PROJECT INFO
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DEMOLITION PLAN

C003





- ① REMOVE EXISTING GRAVEL PARKING AREA
- ② REMOVE EXISTING FENCE
- ③ REMOVE EXISTING LANDSCAPING


DEMOLITION NOTES


1. REFER TO SHEET CXXX FOR DEMOLITION NOTES.
2. CONTRACTOR TO PROVIDE FENCING AND/OR BARRICADES TO KEEP THE PUBLIC OUT OF CONSTRUCTION AREA.

LEGEND


- | | |
|---|--|
|  | REMOVE PAVEMENT, CURB, AND SIDEWALK |
|  | STRUCTURE AND PAVING REMOVED BY OTHERS |
| X · X · | REMOVE EXISTING UNDERGROUND UTILITY |

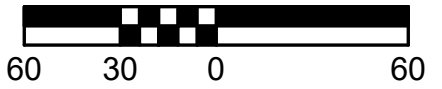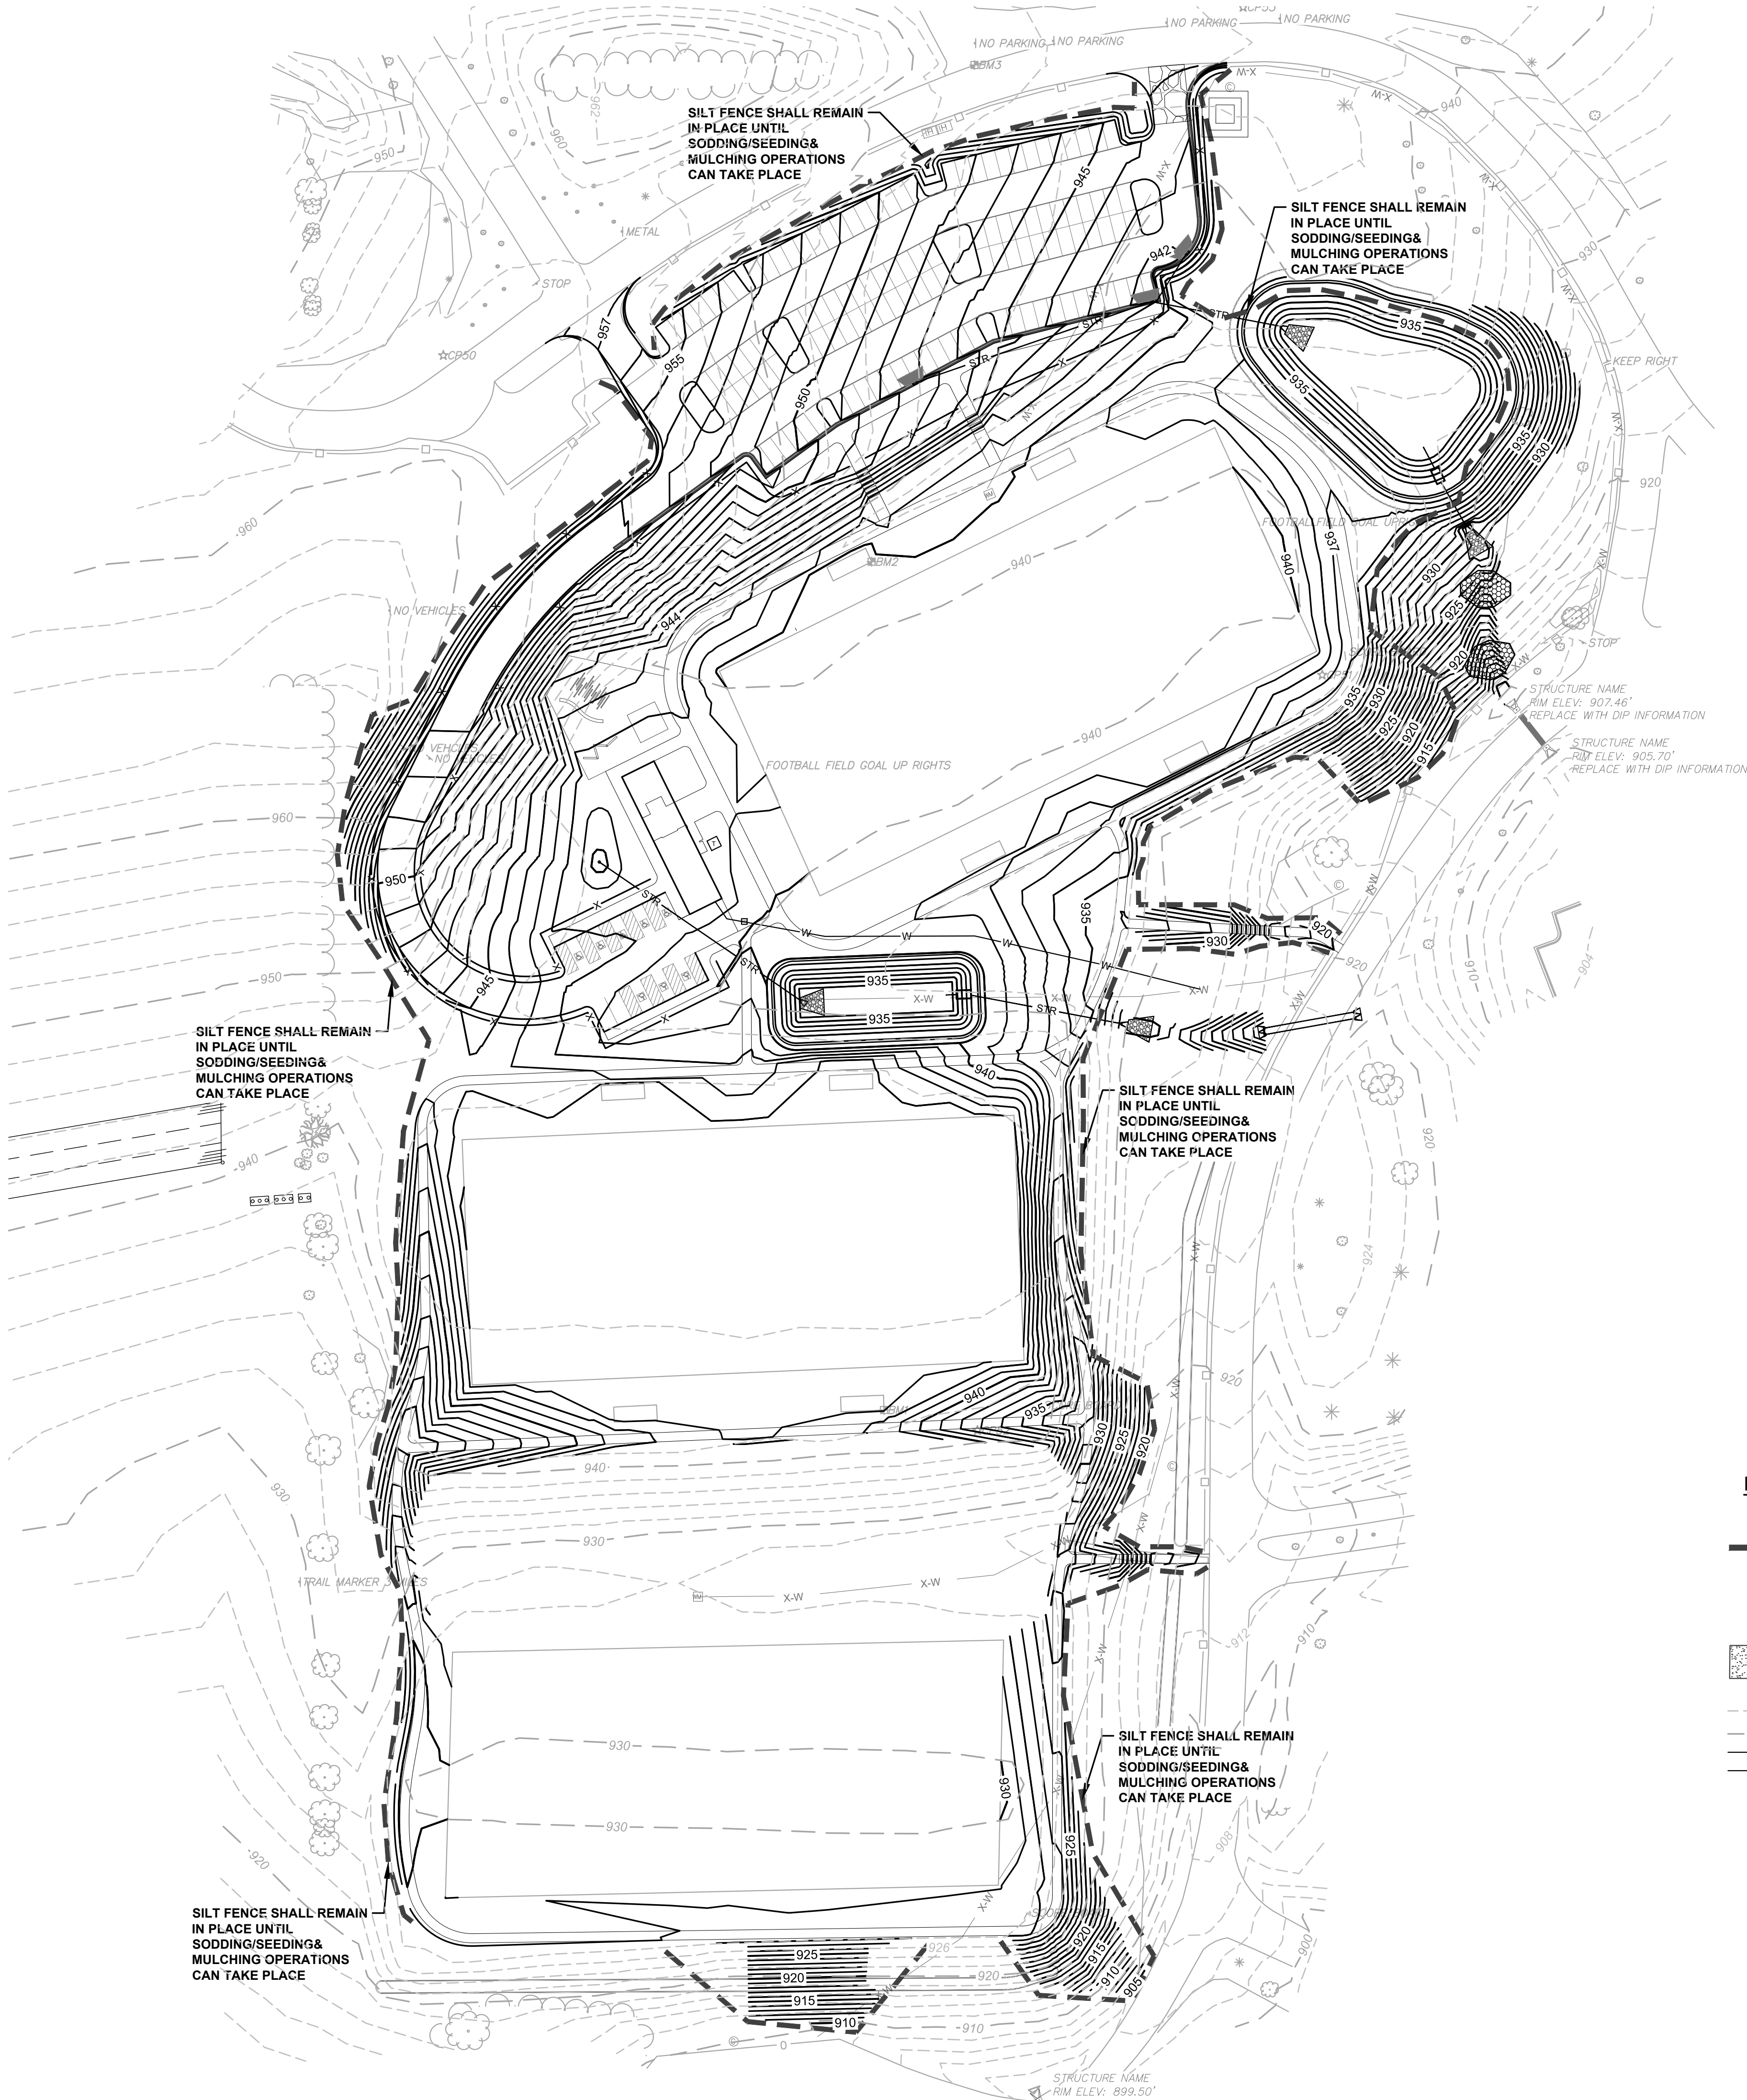NOTE:
SEE SHEET C001 FOR GENERAL NOTES






NOTE:
SEE SHEET C001 FOR GENERAL NOTES.

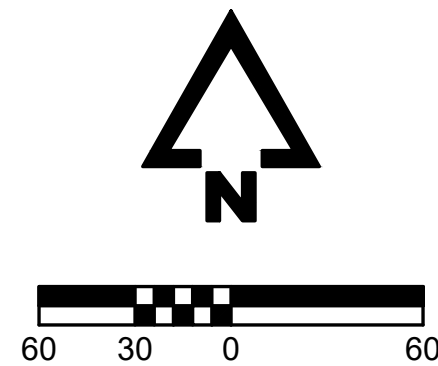

EROSION CONTROL LEGEND

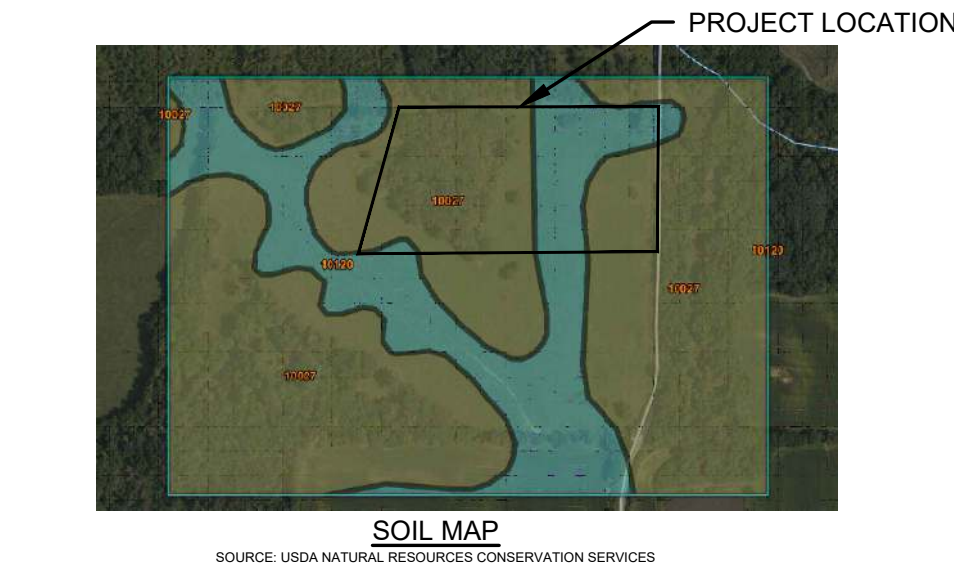- SILT FENCE
SEE APWA DETAIL ESC-03
- CURB INLET PROTECTION
SEE APWA DETAIL ESC-06
- CONSTRUCTION ENTRANCE
SEE APWA DETAIL ESC-01
- EXISTING 1' CONTOUR
- EXISTING 5' CONTOUR
- PROPOSED 1' CONTOUR
- PROPOSED 5' CONTOUR
- ROCK DITCH CHECK DAM.
SEE DETAIL SHEET C601.
- GRAVEL CONSTRUCTION SITE
ENTRANCE. SEE DETAIL SHEET C601.
- CONCRETE WASHOUT AREA.
SEE DETAIL SHEET C601.



EROSION CONTROL NOTES:

- PHASE 1 EROSION CONTROL SHALL CONSIST OF PERIMETER CONTROLS AND SHALL BE INSTALLED PRIOR TO SITE DISTURBANCE.
- THE CONTRACTOR SHALL BE RESPONSIBLE FOR IMPLEMENTING THE STORM WATER POLLUTION PREVENTION PLAN (SWPPP). A COPY OF THE SWPPP SHALL BE AVAILABLE ON SITE AT ALL TIMES.
- THE EROSION CONTROL FEATURES, NOTES AND SPECIFICATIONS IN THE SWPPP REPRESENT THE MINIMUM REQUIREMENTS ACCEPTABLE. LOCATIONS ARE TYPICAL AND MAY VARY ACCORDING TO CONTRACTORS STAGING AND LIMITS OF CONSTRUCTION. THE CONTRACTOR SHALL ADJUST, MODIFY AND ADD TO THIS PLAN AS NECESSARY TO CONTROL EROSION, SILTATION AND POLLUTION.
- IT SHALL BE EACH CONTRACTOR'S RESPONSIBILITY TO CONTROL EROSION AND PREVENT POLLUTION FOR ALL WORK WHICH THEY ARE DIRECTLY INVOLVED.
- EROSION CONTROL DEVICES SHOWN ON THIS PLAN SHALL BE IN PLACE PRIOR TO THE COMMENCEMENT OF ANY DEMOLITION OR GRADING WORK.
- WHEN POSSIBLE, WITHOUT ADVERSELY AFFECTING CONSTRUCTION OPERATIONS, THE CONTRACTOR SHALL: MINIMIZE THE AMOUNT OF SURFACE AREA WHICH IS EXPOSED AT ONE TIME, LEAVE GRADED AREAS WITH A ROUGH TEXTURE, CONSTRUCT TEMPORARY TERRACES DURING GRADING OPERATIONS, AND LIMIT UNNECESSARY VEHICLE TRAFFIC IN GRADED AREAS.
- THE SPILLAGE OF DEBRIS, INCLUDING THE TRACKING OF SOIL, OUTSIDE OF THE CONSTRUCTION LIMITS SHALL BE AVOIDED. THEREFORE THE CONTRACTOR SHALL PROVIDE STABILIZED DRIVES AT ALL ACCESS LOCATIONS AS NECESSARY AND SHALL REMOVE PROMPTLY ANY MATERIAL WHICH FINDS ITS WAY INTO THE PUBLIC RIGHT-OF-WAY.
- SILT FENCES SHALL BE PLACED ON A CONTOUR ELEVATION ALONG THE DOWNHILL SIDE AND FOR THE FULL EXTENT OF THE DISTURBED AREAS WITHIN THE CONSTRUCTION LIMITS. THE LAST FIVE FEET ON EACH END OF RUN OF SILT FENCE/STRAW BALE DIKE SHALL BE PLACED FACING UPHILL AT 90 DEGREES TO THE CONTOUR LINE.
- THE CONTRACTOR SHALL INSPECT THEIR EROSION CONTROL DEVICES EVERY 7 DAYS AND WITHIN 24 HOURS OF A STORM OF 0.5 INCHES OR MORE IN DEPTH. THE CONTRACTOR SHALL REPAIR DAMAGE, CLEAN OUT SEDIMENT AND ADD ADDITIONAL CONTROL DEVICES AS NEEDED AS SOON AS PRACTICABLE AFTER INSPECTION. DEFICIENCIES MUST BE CORRECTED WITHIN 7 DAYS OF INSPECTION.
- ALL AREAS UPON REACHING FINAL GRADE SHALL BE BROUGHT TO FINAL TREATMENT, AS SOON AS POSSIBLE. EROSION CONTROL DEVICES SHALL REMAIN IN PLACE UNTIL ALL SOIL DISTURBING ACTIVITIES ARE COMPLETE AND A UNIFORM PERENNIAL COVER WITH A DENSITY OF 70 % (MINIMUM) IS ESTABLISHED.
- WHERE GRADED AREAS DRAIN ONTO PAVED AREAS, SILT FENCE SHALL BE PLACED AT THE BACK OF CURB TO PREVENT SILT FROM ENTERING THE PAVED AREAS. WHEN THESE EROSION CONTROL DEVICES ARE NOT PLACED ON THE CONTOUR, THEN THEY SHALL HAVE INSTALLED AT 50' INTERVALS A 5' LENGTH PLACED AT 90 DEGREES TO THE MAIN LENGTH.
- REMOVE CONCRETE WASH OUT AREA AFTER ALL CONCRETE WORK IS COMPLETE. AFTER REMOVAL OF THE CONCRETE WASHOUT AREA THE CONTRACTOR SHALL ESTABLISH PERMANENT GROUND COVER (SEED) IN THE AREA WHERE THE WASH OUT WAS LOCATED.
- ALL STORM SEWER INLETS SHALL HAVE INLET PROTECTION AFTER STORM SEWER CONSTRUCTION. SEE SHEET C401 AND C402 FOR NEW INLET LOCATIONS.

GENERAL NOTES

- THE CONSTRUCTION COVERED BY THESE PLANS SHALL CONFORM TO ALL APPLICABLE STANDARDS AND SPECIFICATIONS OF THE PUBLIC WORKS DEPARTMENT OF THE CITY OF KANSAS CITY, MISSOURI, IN CURRENT USAGE AND ALL SUPPLEMENTS THERE TO.
- CONTRACTOR IS RESPONSIBLE FOR ALL PERMITS, BONDS, AND INSURANCE REQUIRED BY THE CITY.
- THE IMPROVEMENTS SHOWN ON THIS PLAN ARE PUBLIC IMPROVEMENTS, COORDINATE WITH CITY FOR REQUIRED PERMITS, BONDS AND INSURANCE.
- ALL WORKMANSHIP AND MATERIALS SHALL BE SUBJECT TO THE INSPECTION AND APPROVAL OF THE ENGINEERING DEPARTMENT OF THE CITY OF KANSAS CITY, MISSOURI.
- THE UTILITY LOCATIONS SHOWN ON THESE PLANS ARE TAKEN FROM UTILITY COMPANY RECORDS AND ARE APPROXIMATE ONLY. THEY DO NOT CONSTITUTE ACTUAL FIELD LOCATIONS. THE CONTRACTOR SHALL VERIFY THE LOCATION AND DEPTH OF ALL UTILITIES PRIOR TO CONSTRUCTION.
- THE CONTRACTOR SHALL ADHERE TO THE PROVISIONS OF THE SENATE BILL NUMBER 583, 78TH GENERAL ASSEMBLY OF THE STATE OF MISSOURI. THE BILL REQUIRES THAT ANY PERSON OF FIRM DOING EXCAVATION ON PUBLIC RIGHT-OF-WAY DO SO ONLY AFTER GIVING NOTICE TO, AND OBTAINING INFORMATION FROM, UTILITY COMPANIES, STATE LAW REQUIRES 48 HOURS ADVANCE NOTICE. PRIOR TO COMMENCEMENT OF WORK, THE CONTRACTOR SHALL NOTIFY ALL THOSE COMPANIES WHICH HAVE FACILITIES IN THE NEAR VICINITY OF THE CONSTRUCTION TO BE PERFORMED. THE CONTRACTOR MAY ALSO UTILIZE THE FOLLOWING TOLL FREE PHONE NUMBER IS APPLICABLE ANYWHERE WITHIN THE STATE OF MISSOURI.
- THE DEVELOPER/OWNER SHALL CONTROL EROSION AND SILTATION DURING ALL PHASES OF CONSTRUCTION, AND SHALL KEEP THE STREETS CLEAN OF MUD AND DEBRIS.
- ALL EXCESS MATERIAL SHALL BE REMOVED LEGALLY FROM SITE AND DISPOSED OF OFF SITE.
- TRAFFIC CONTROL AND MAINTENANCE OF TRAFFIC DURING CONSTRUCTION SHALL BE THE RESPONSIBILITY OF THE CONTRACTOR AND SHALL BE IN ACCORDANCE WITH THE REQUIREMENTS OF THE PUBLIC WORKS DEPARTMENT.
- EROSION CONTROL MEASURES SHALL BE PROVIDED AT ALL LOCATIONS WHERE DRAINAGE IS LEAVING THE PROJECT SITE. THE EROSION CONTROL PLAN SHOWS MINIMUM EROSION CONTROL MEASURES TO BE PROVIDED. ADDITIONAL SITE SPECIFIC MEASURES MAY BE NECESSARY AND SHALL BE PROVIDED BY THE DEVELOPER / OWNER, AT THE CONTRACTOR'S EXPENSE.
- ANY EXISTING OR NEW STORM SEWER INLETS IN USE DURING DEMOLITION, GRADING OR CONSTRUCTION SHALL HAVE INLET PROTECTION AS SPECIFIED.



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MISSOURI CERTIFICATE OF
AUTHORITY NO. E-2006023253
EXPIRES: DECEMBER 31, 2022



REVISIONS

PROJECT INFO
210266-000

ENGINEER DRAWN BY CHECKED BY
AVD AVD

PLATTE RIDGE PARK
FOOTBALL COMPLEX IMPROVEMENTS
17130 HIGHWAY 371, PLATTE CITY, MO 64079

EROSION CONTROL PLAN

DRAWING NO.

C100


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LEGEND


- SIDEWALK/ STANDARD DUTY CONCRETE PAVEMENT
- ASPHALT PAVEMENT
- NATIVE GRASSES/PLANTINGS
- PROPOSED BUILDING

KEY NOTES

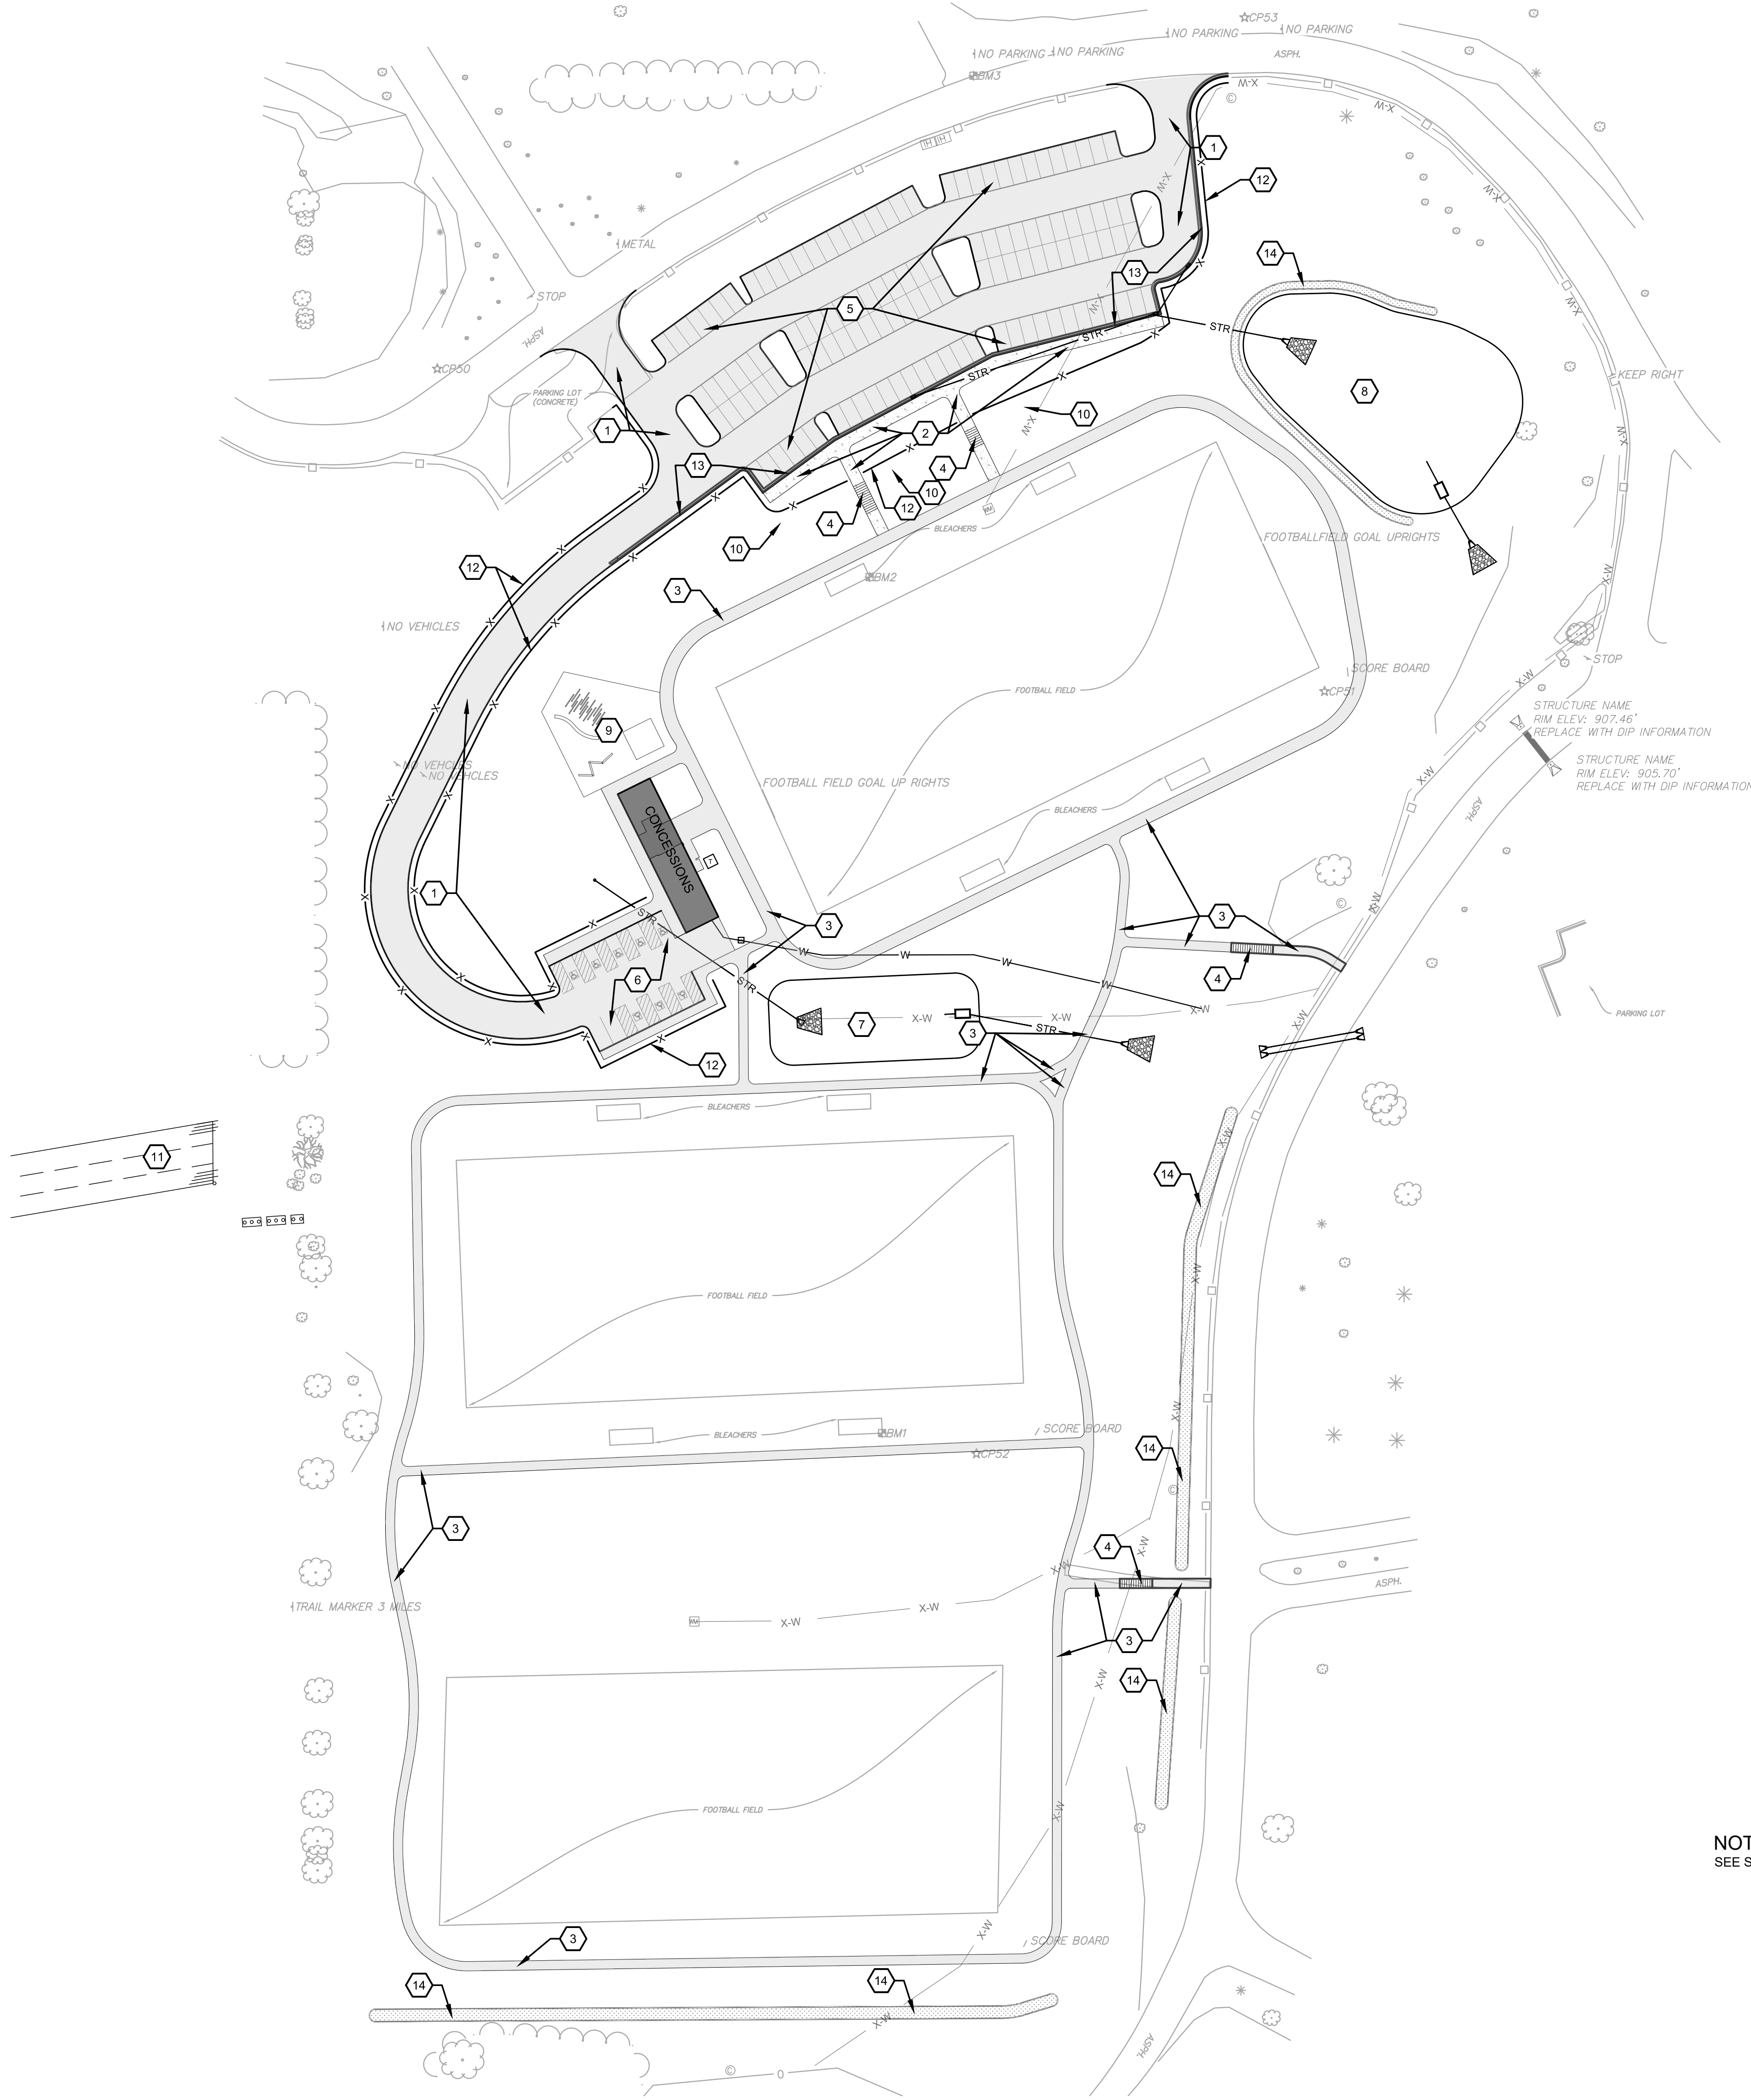- 1 PROPOSED ASPHALT PAVEMENT
- 2 PROPOSED CONCRETE SIDEWALK
- 3 PROPOSED 6" ASPHALT TRAIL
- 4 PROPOSED STAIRS
- 5 PROPOSED PARKING AREA
- 6 PROPOSED ADA PARKING
- 7 PROPOSED DETENTION BASIN A-1
- 8 PROPOSED DETENTION BASIN A-2
- 9 FUTURE PLAYGROUND AREA (TO BE INSTALLED BY OTHERS)
- 10 PROPOSED RETAINING WALL
- 11 PROPOSED SEPTIC FIELD (SEE SHEET C500)
- 12 PROPOSED FENCE - TO MATCH EXISTING, POSTS 8' O.C., 3 ROUND RAIL FENCE
- 13 PROPOSED CURB AND GUTTER (CG-1)
- 14 PROPOSED NATIVE PLANTING AREA



NOTE:
SEE SHEET C001 FOR GENERAL NOTES.

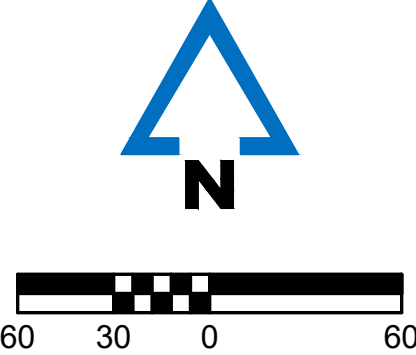

WSKF
ARCHITECTS

pkmr
ENGINEERS

PEARSON KENT MCKINLEY RAAF ENGINEERS LLC
13300 W 88TH STREET
913.492.2400
MO State Certificate of Authority #E-2002020886

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WWW.PKMRENG.COM

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MISSOURI CERTIFICATE OF AUTHORITY NO. E-2006023253
EXPIRES: DECEMBER 31, 2022



REVISIONS
ISSUE DATE: 4/18/2022

PROJECT INFO
210266-000


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AVD	AVD	AVD

PLATTE RIDGE PARK
FOOTBALL COMPLEX IMPROVEMENTS
17130 HIGHWAY 371, PLATTE CITY, MO 64079

SITE PLAN

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DRAWING NO.
C200

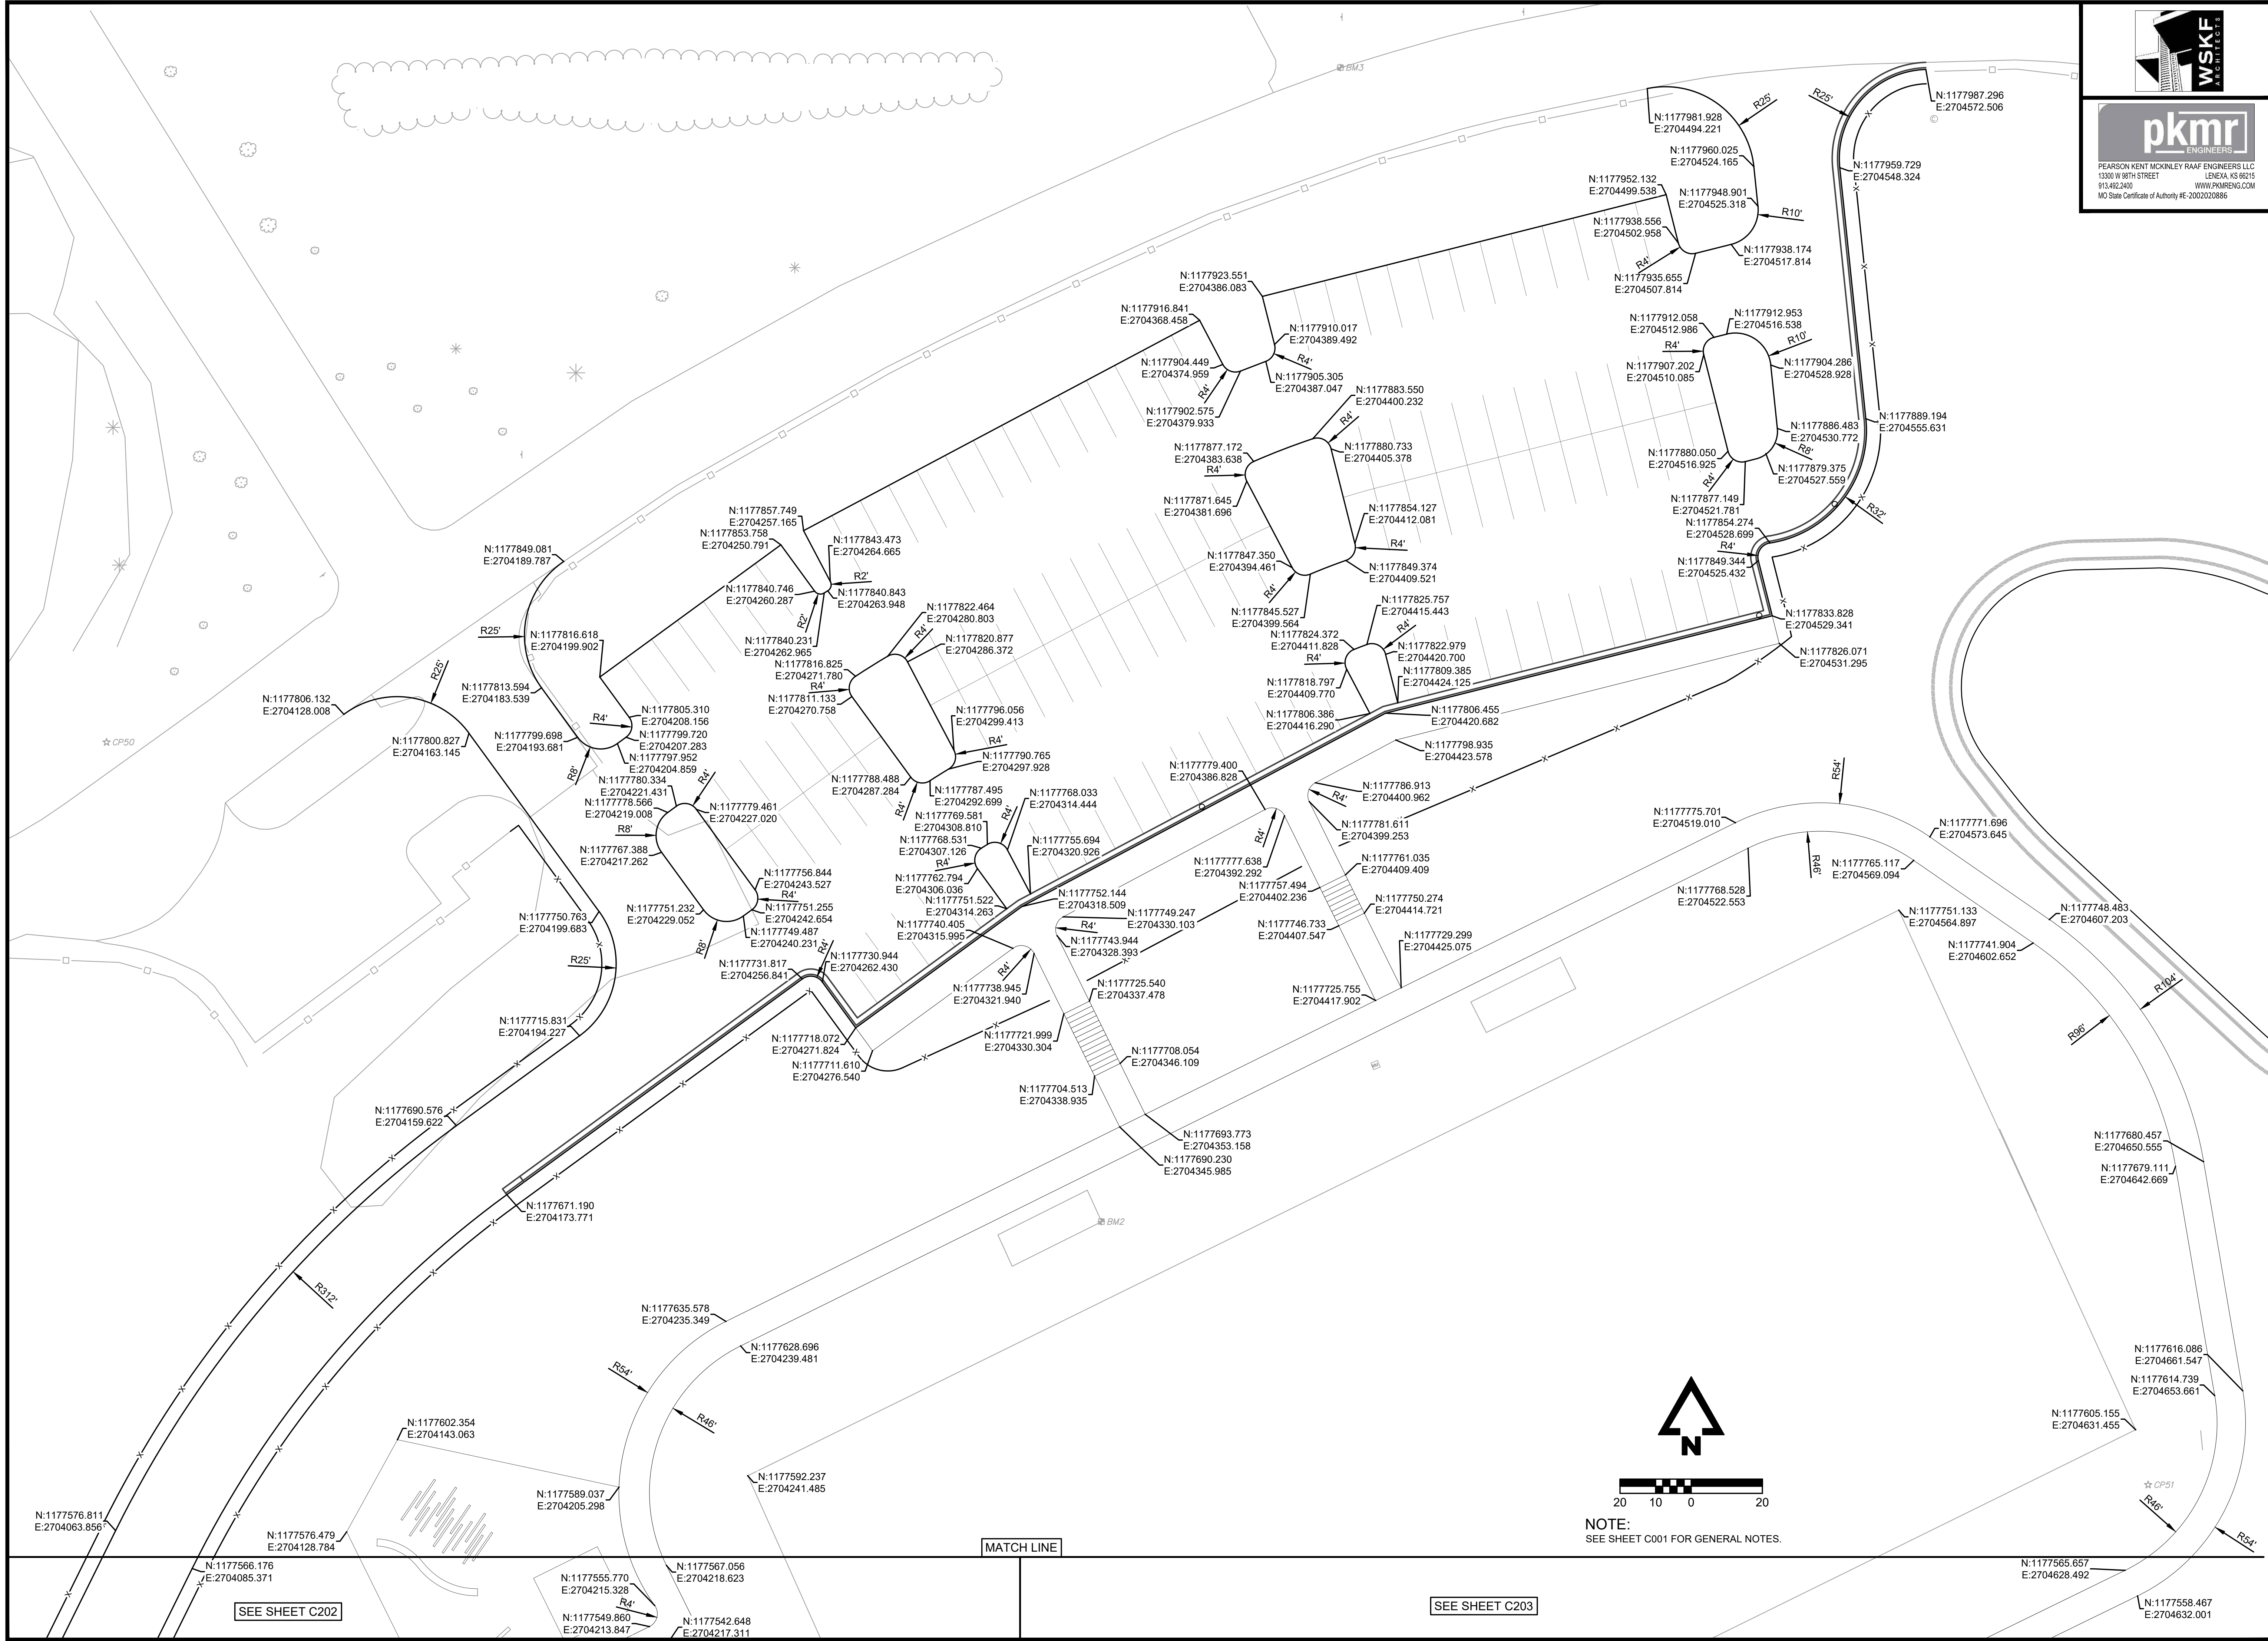

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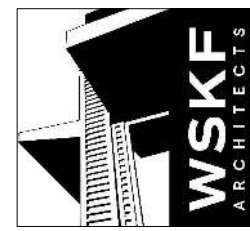
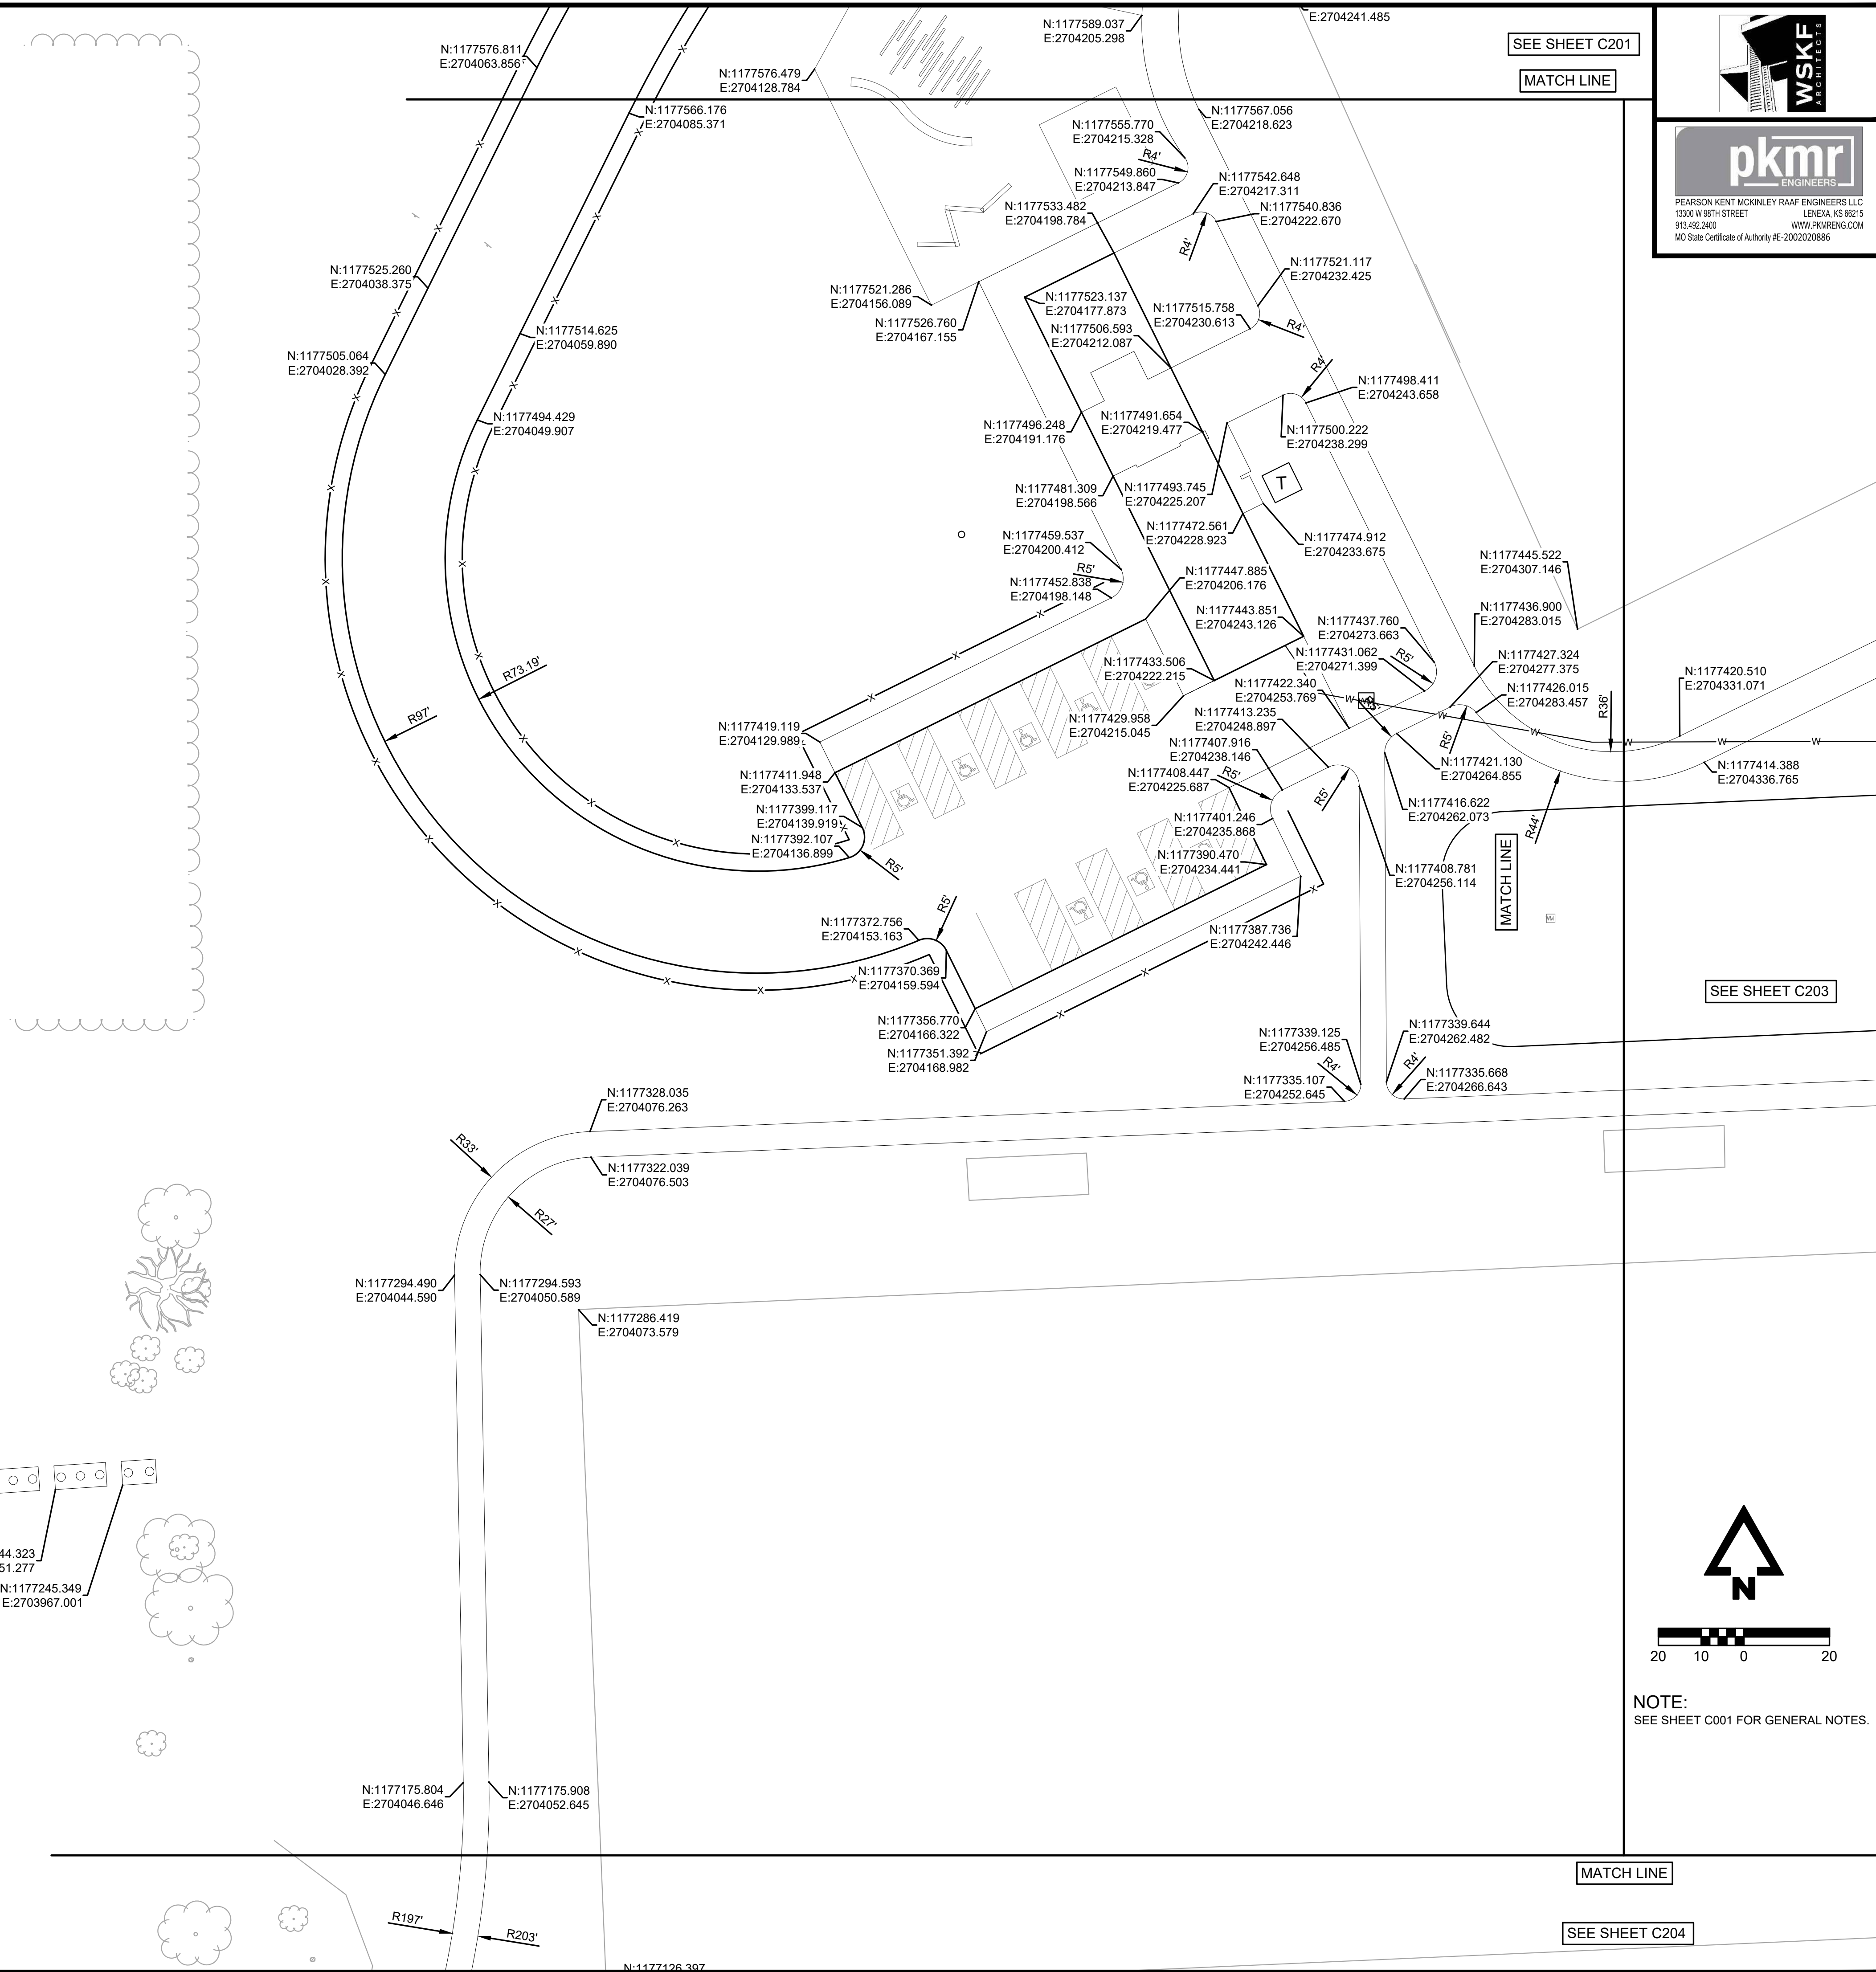


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PLATTE RIDGE PARK
FOOTBALL COMPLEX IMPROVEMENTS
17130 HIGHWAY 371, PLATTE CITY, MO 64079
DIMENSION PLAN

DRAWING NO.
C201

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AUTHORITY NO. E-2006023253
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REVISIONS

PROJECT INFO
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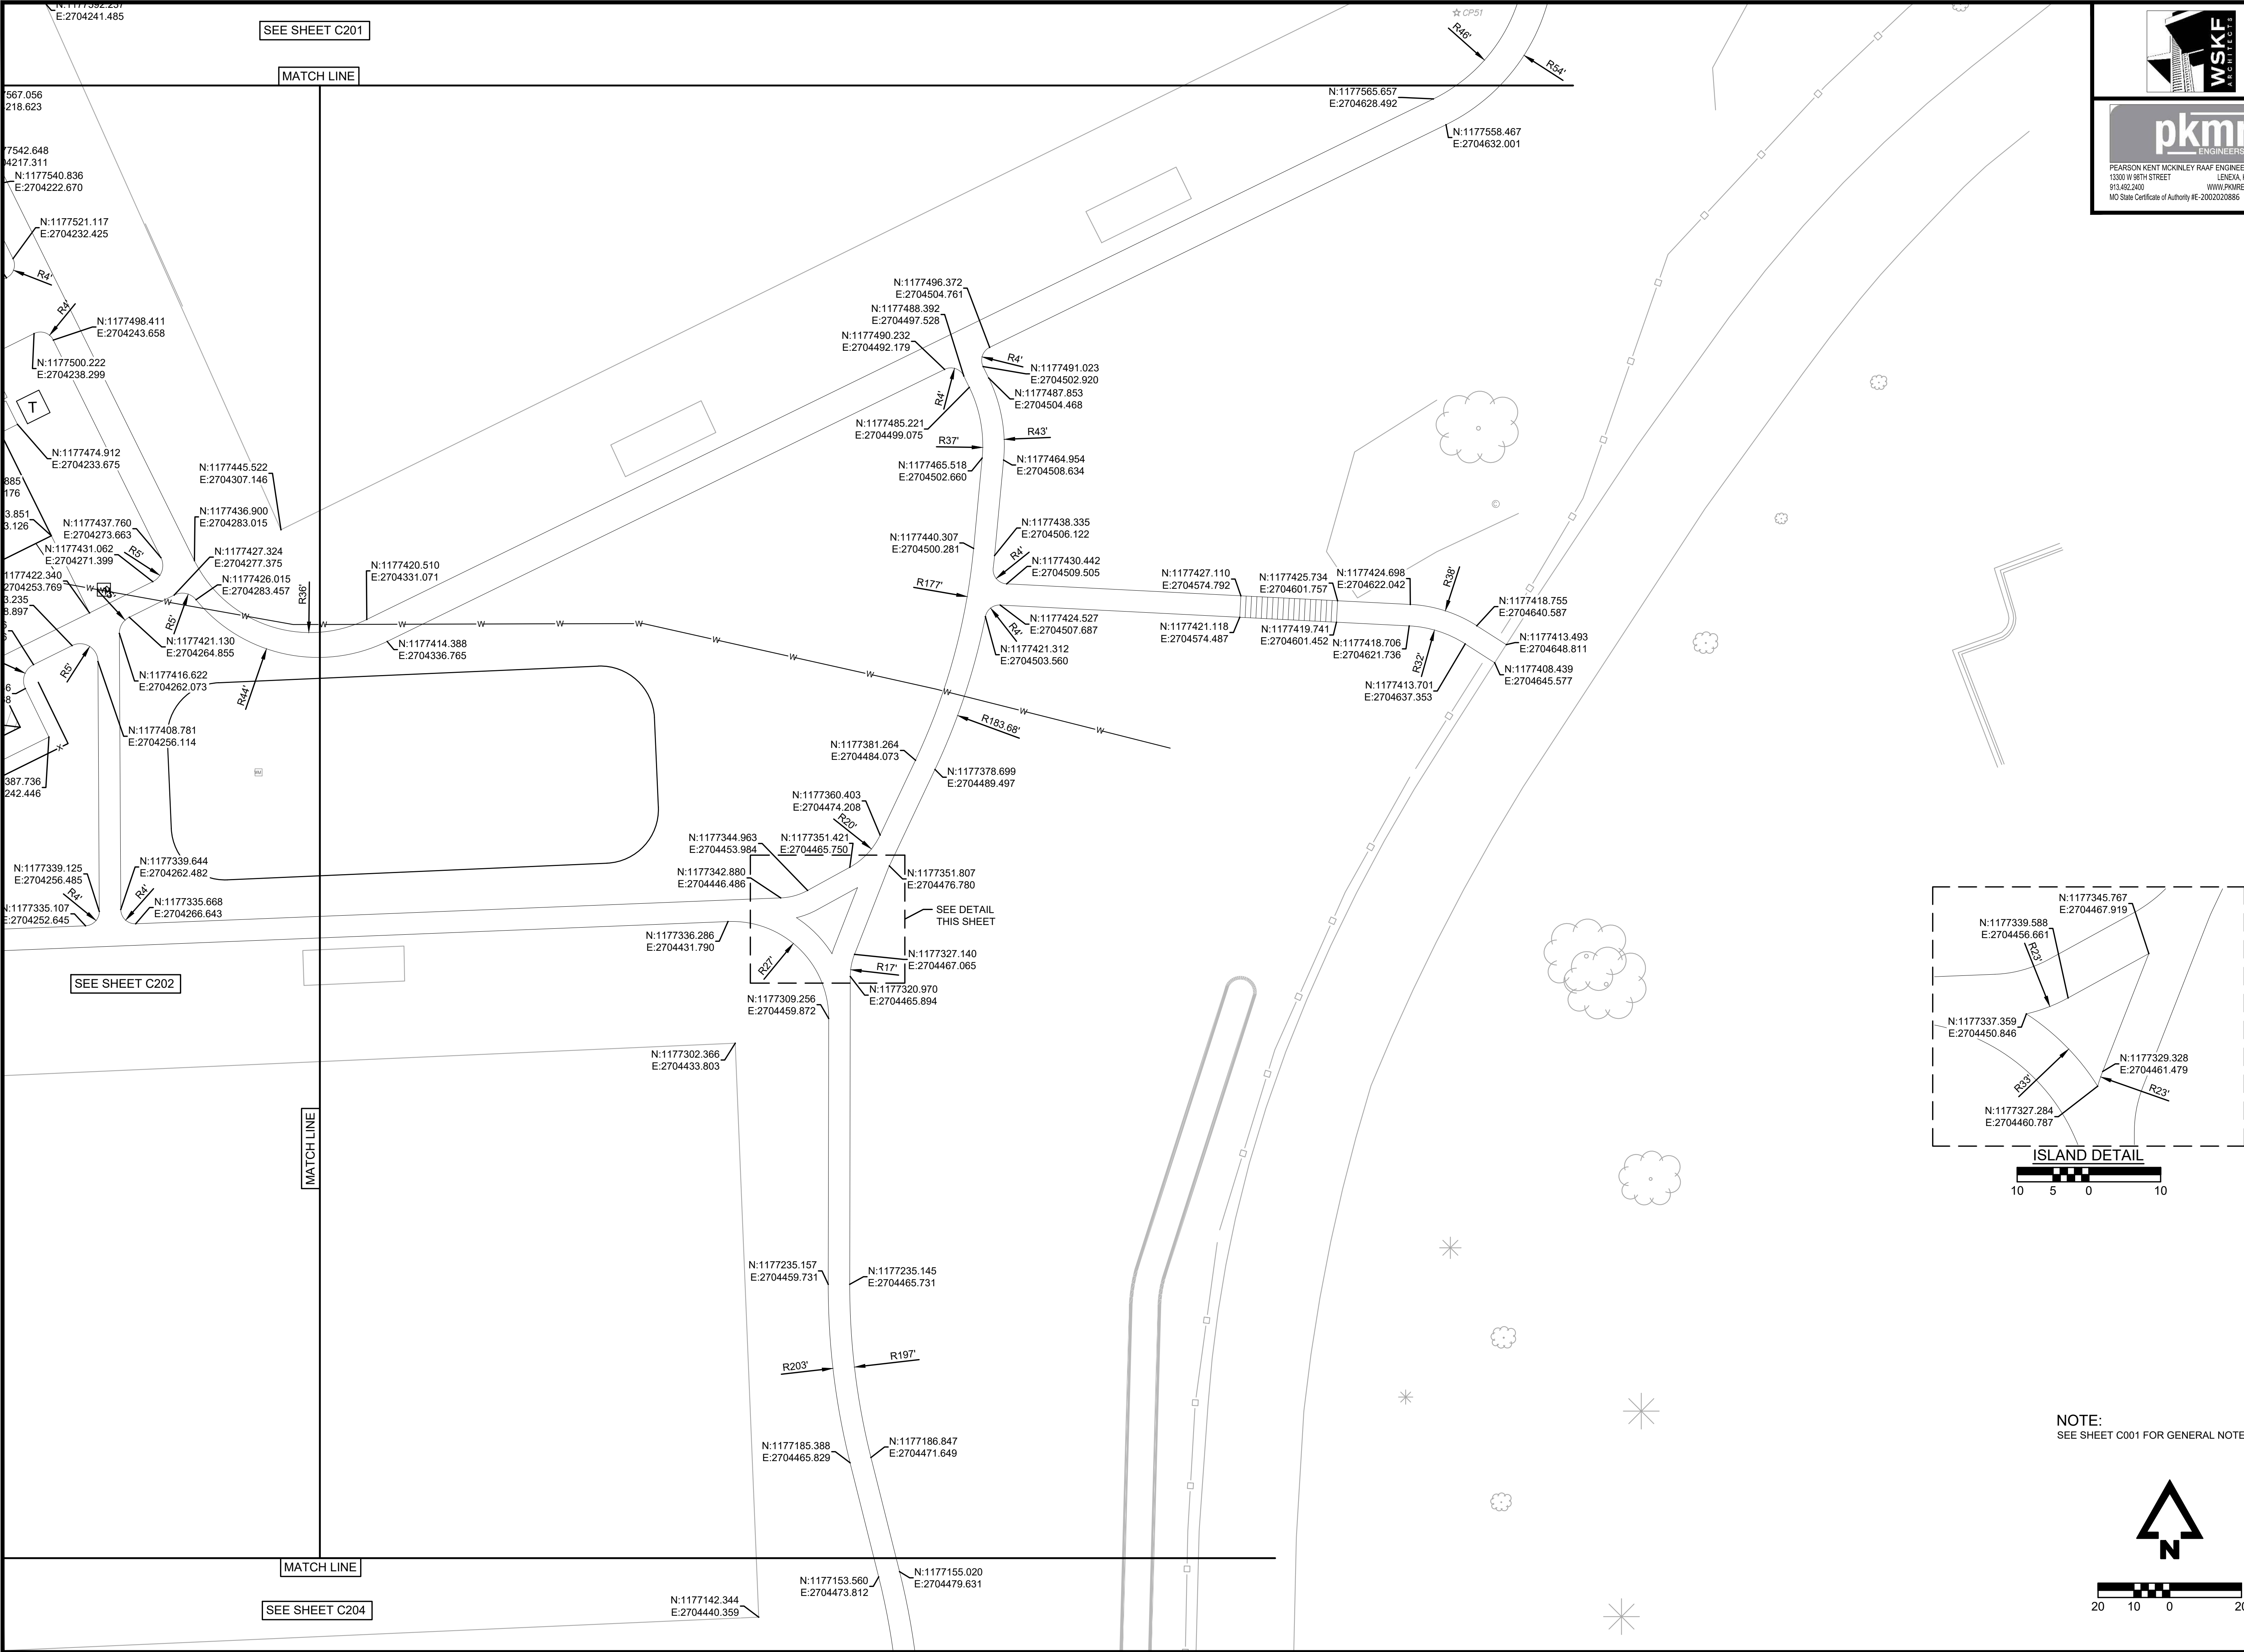
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DIMENSION PLAN

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DRAWING NO.

C202



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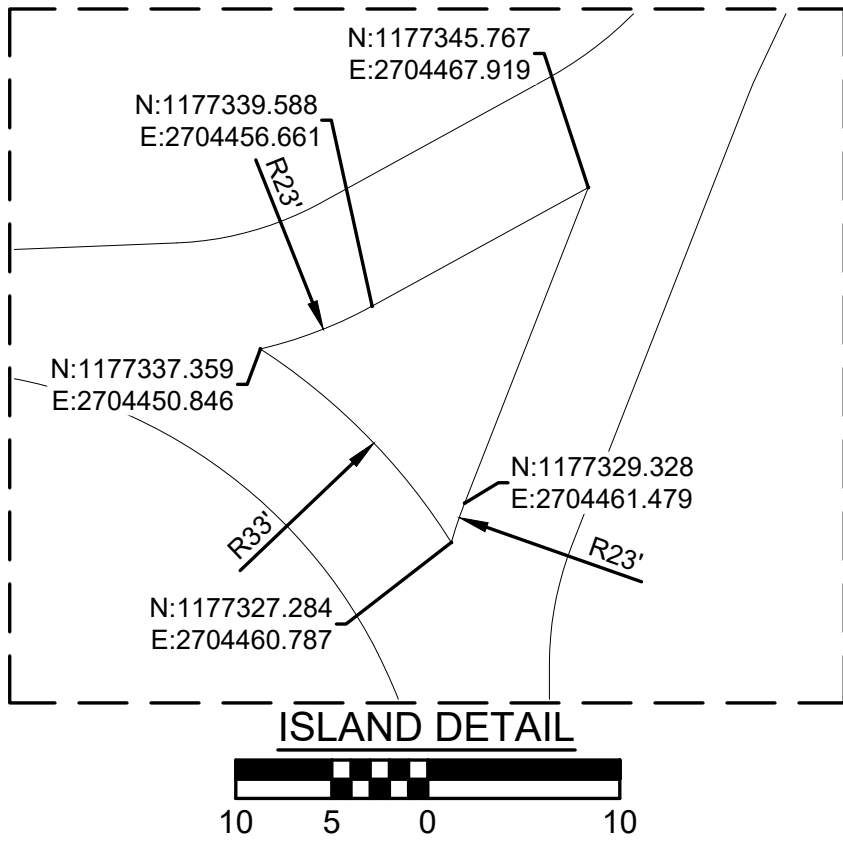
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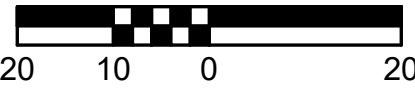
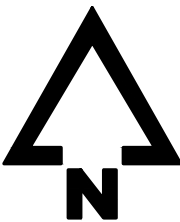
MISSOURI CERTIFICATE OF AUTHORITY NO. E-2006023253
EXPIRES: DECEMBER 31, 2022



REVISIONS		
PROJECT INFO		
210266-000		
ENGINEER	DRAWN BY	CHECKED BY
	AVD	AVD



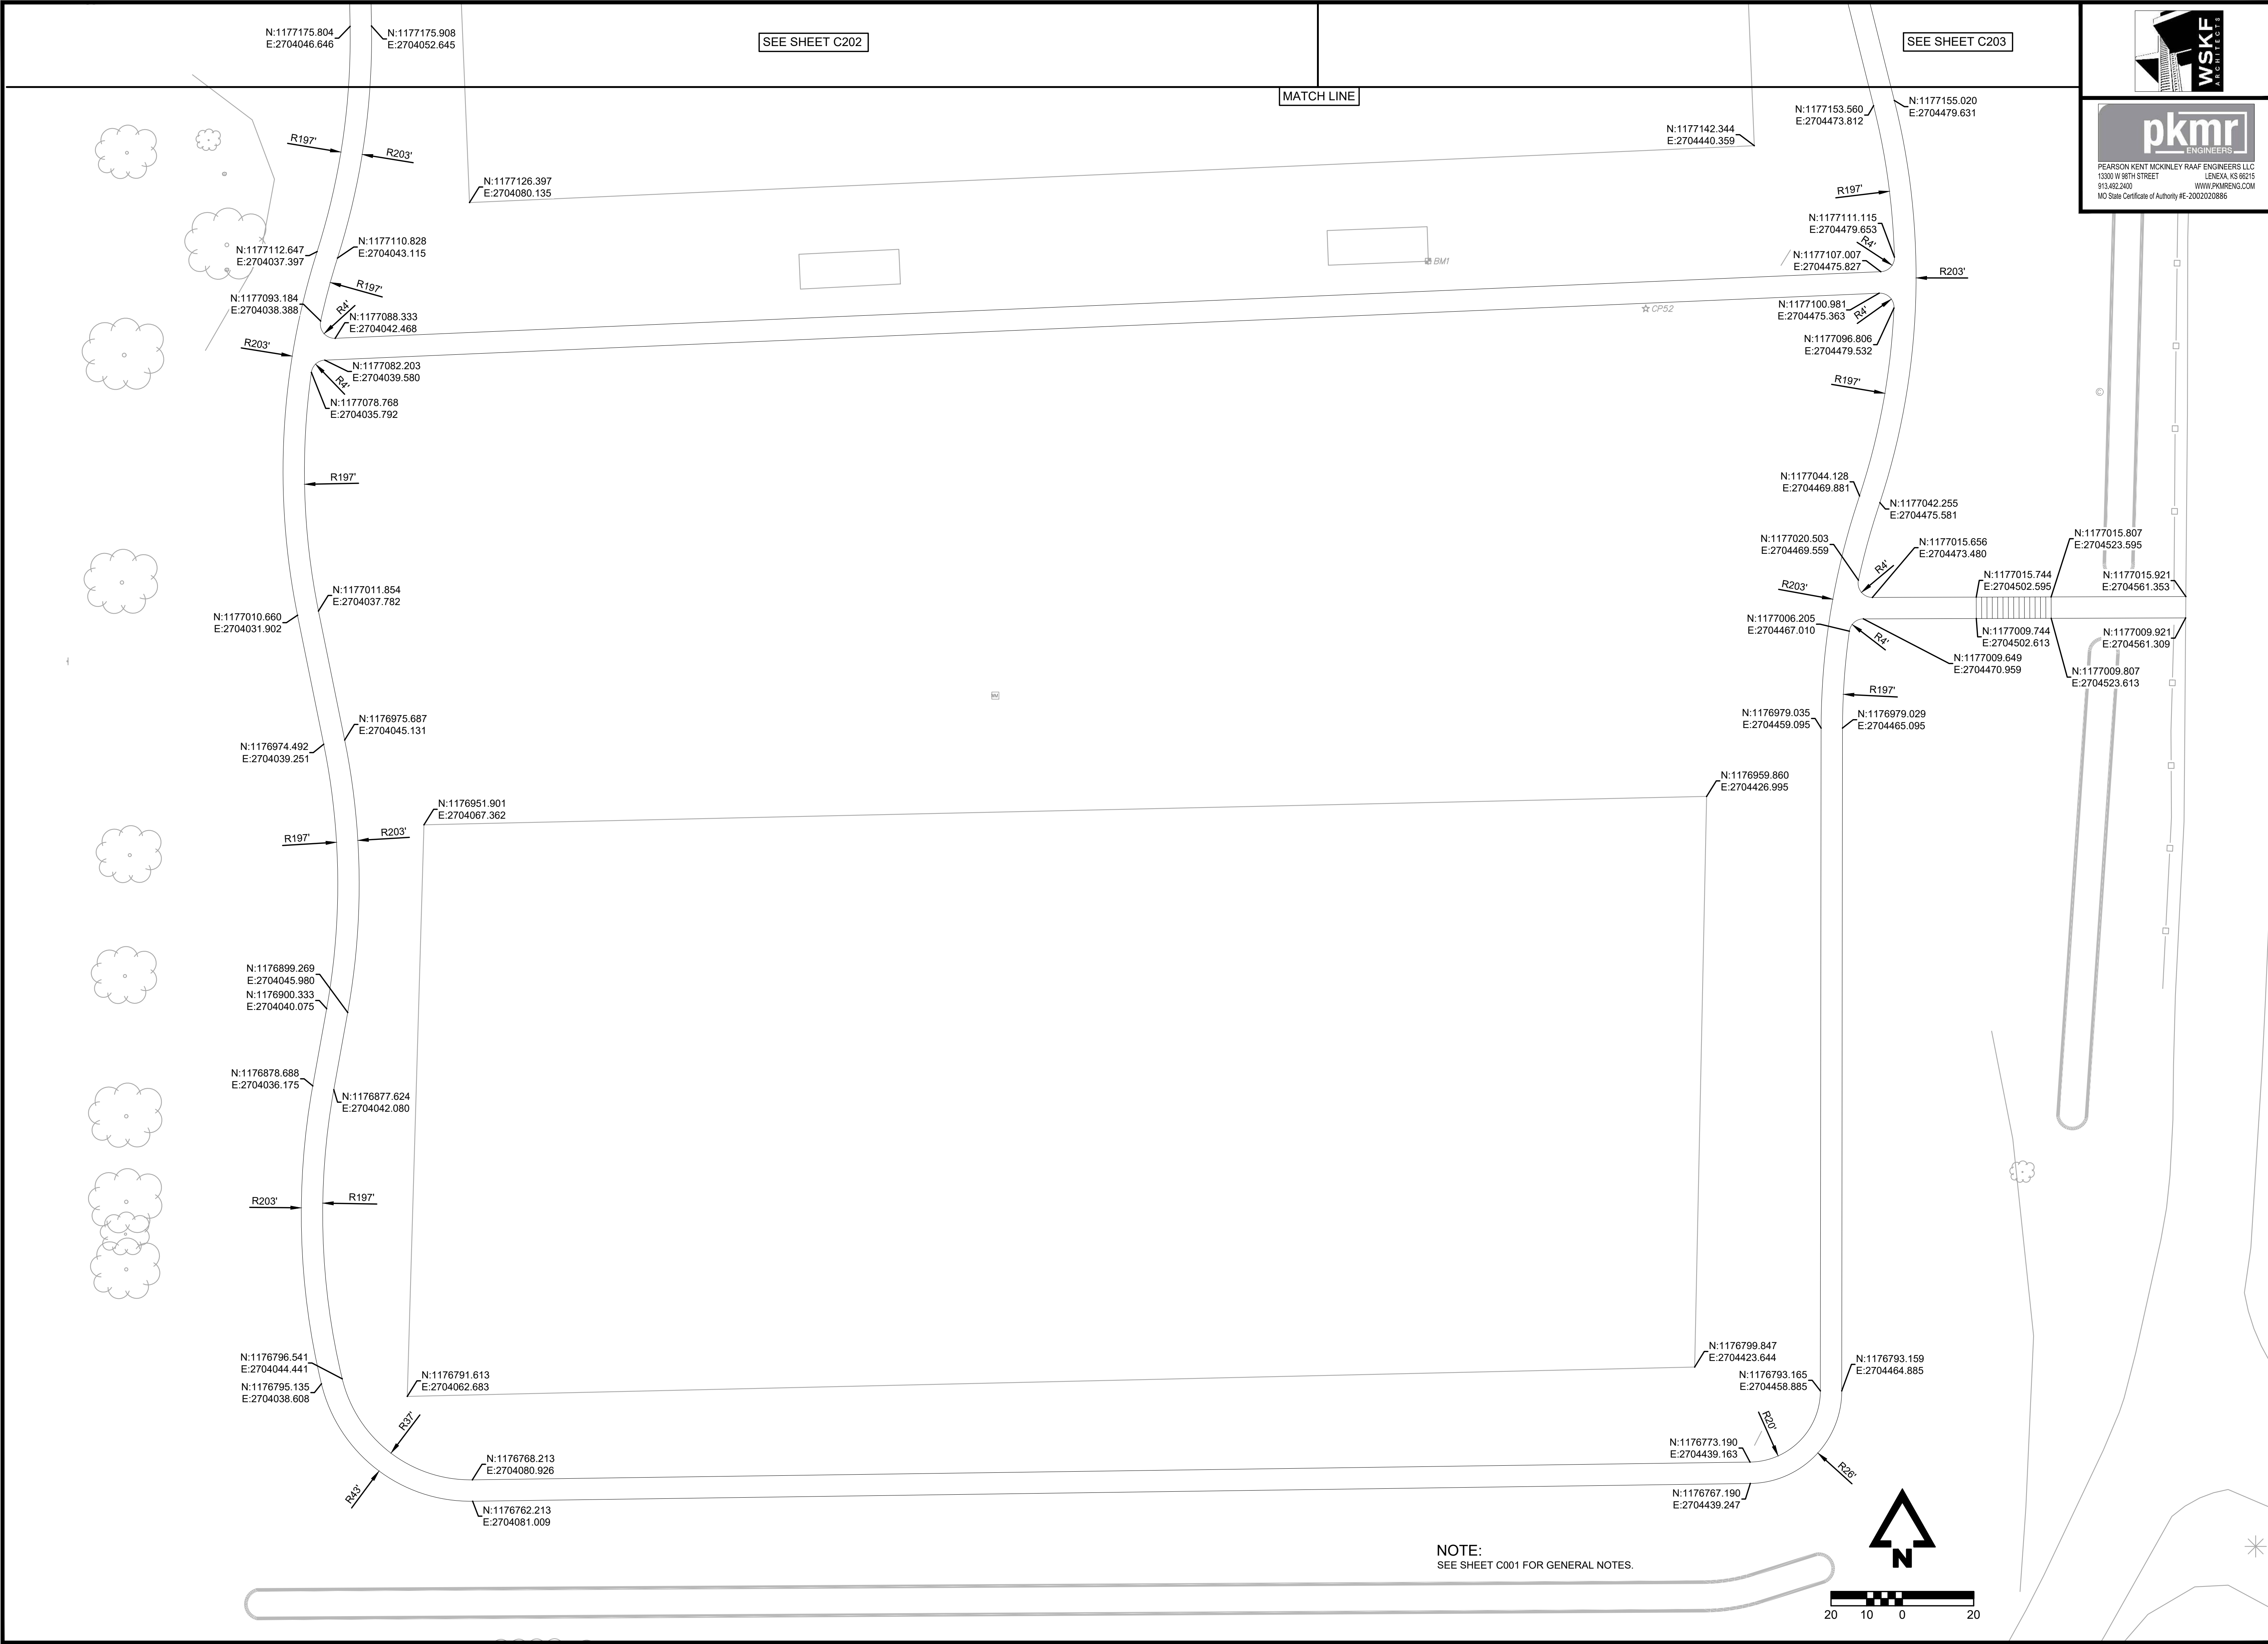
NOTE:
SEE SHEET C001 FOR GENERAL NOTES.





PLATTE RIDGE PARK
FOOTBALL COMPLEX IMPROVEMENTS
17130 HIGHWAY 371, PLATTE CITY, MO 64079

DIMENSION PLAN


DRAWING NO.
C203





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
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REVISIONS

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210266-000

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PLATTE RIDGE PARK
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DIMENSION PLAN

DRAWING NO.
C204



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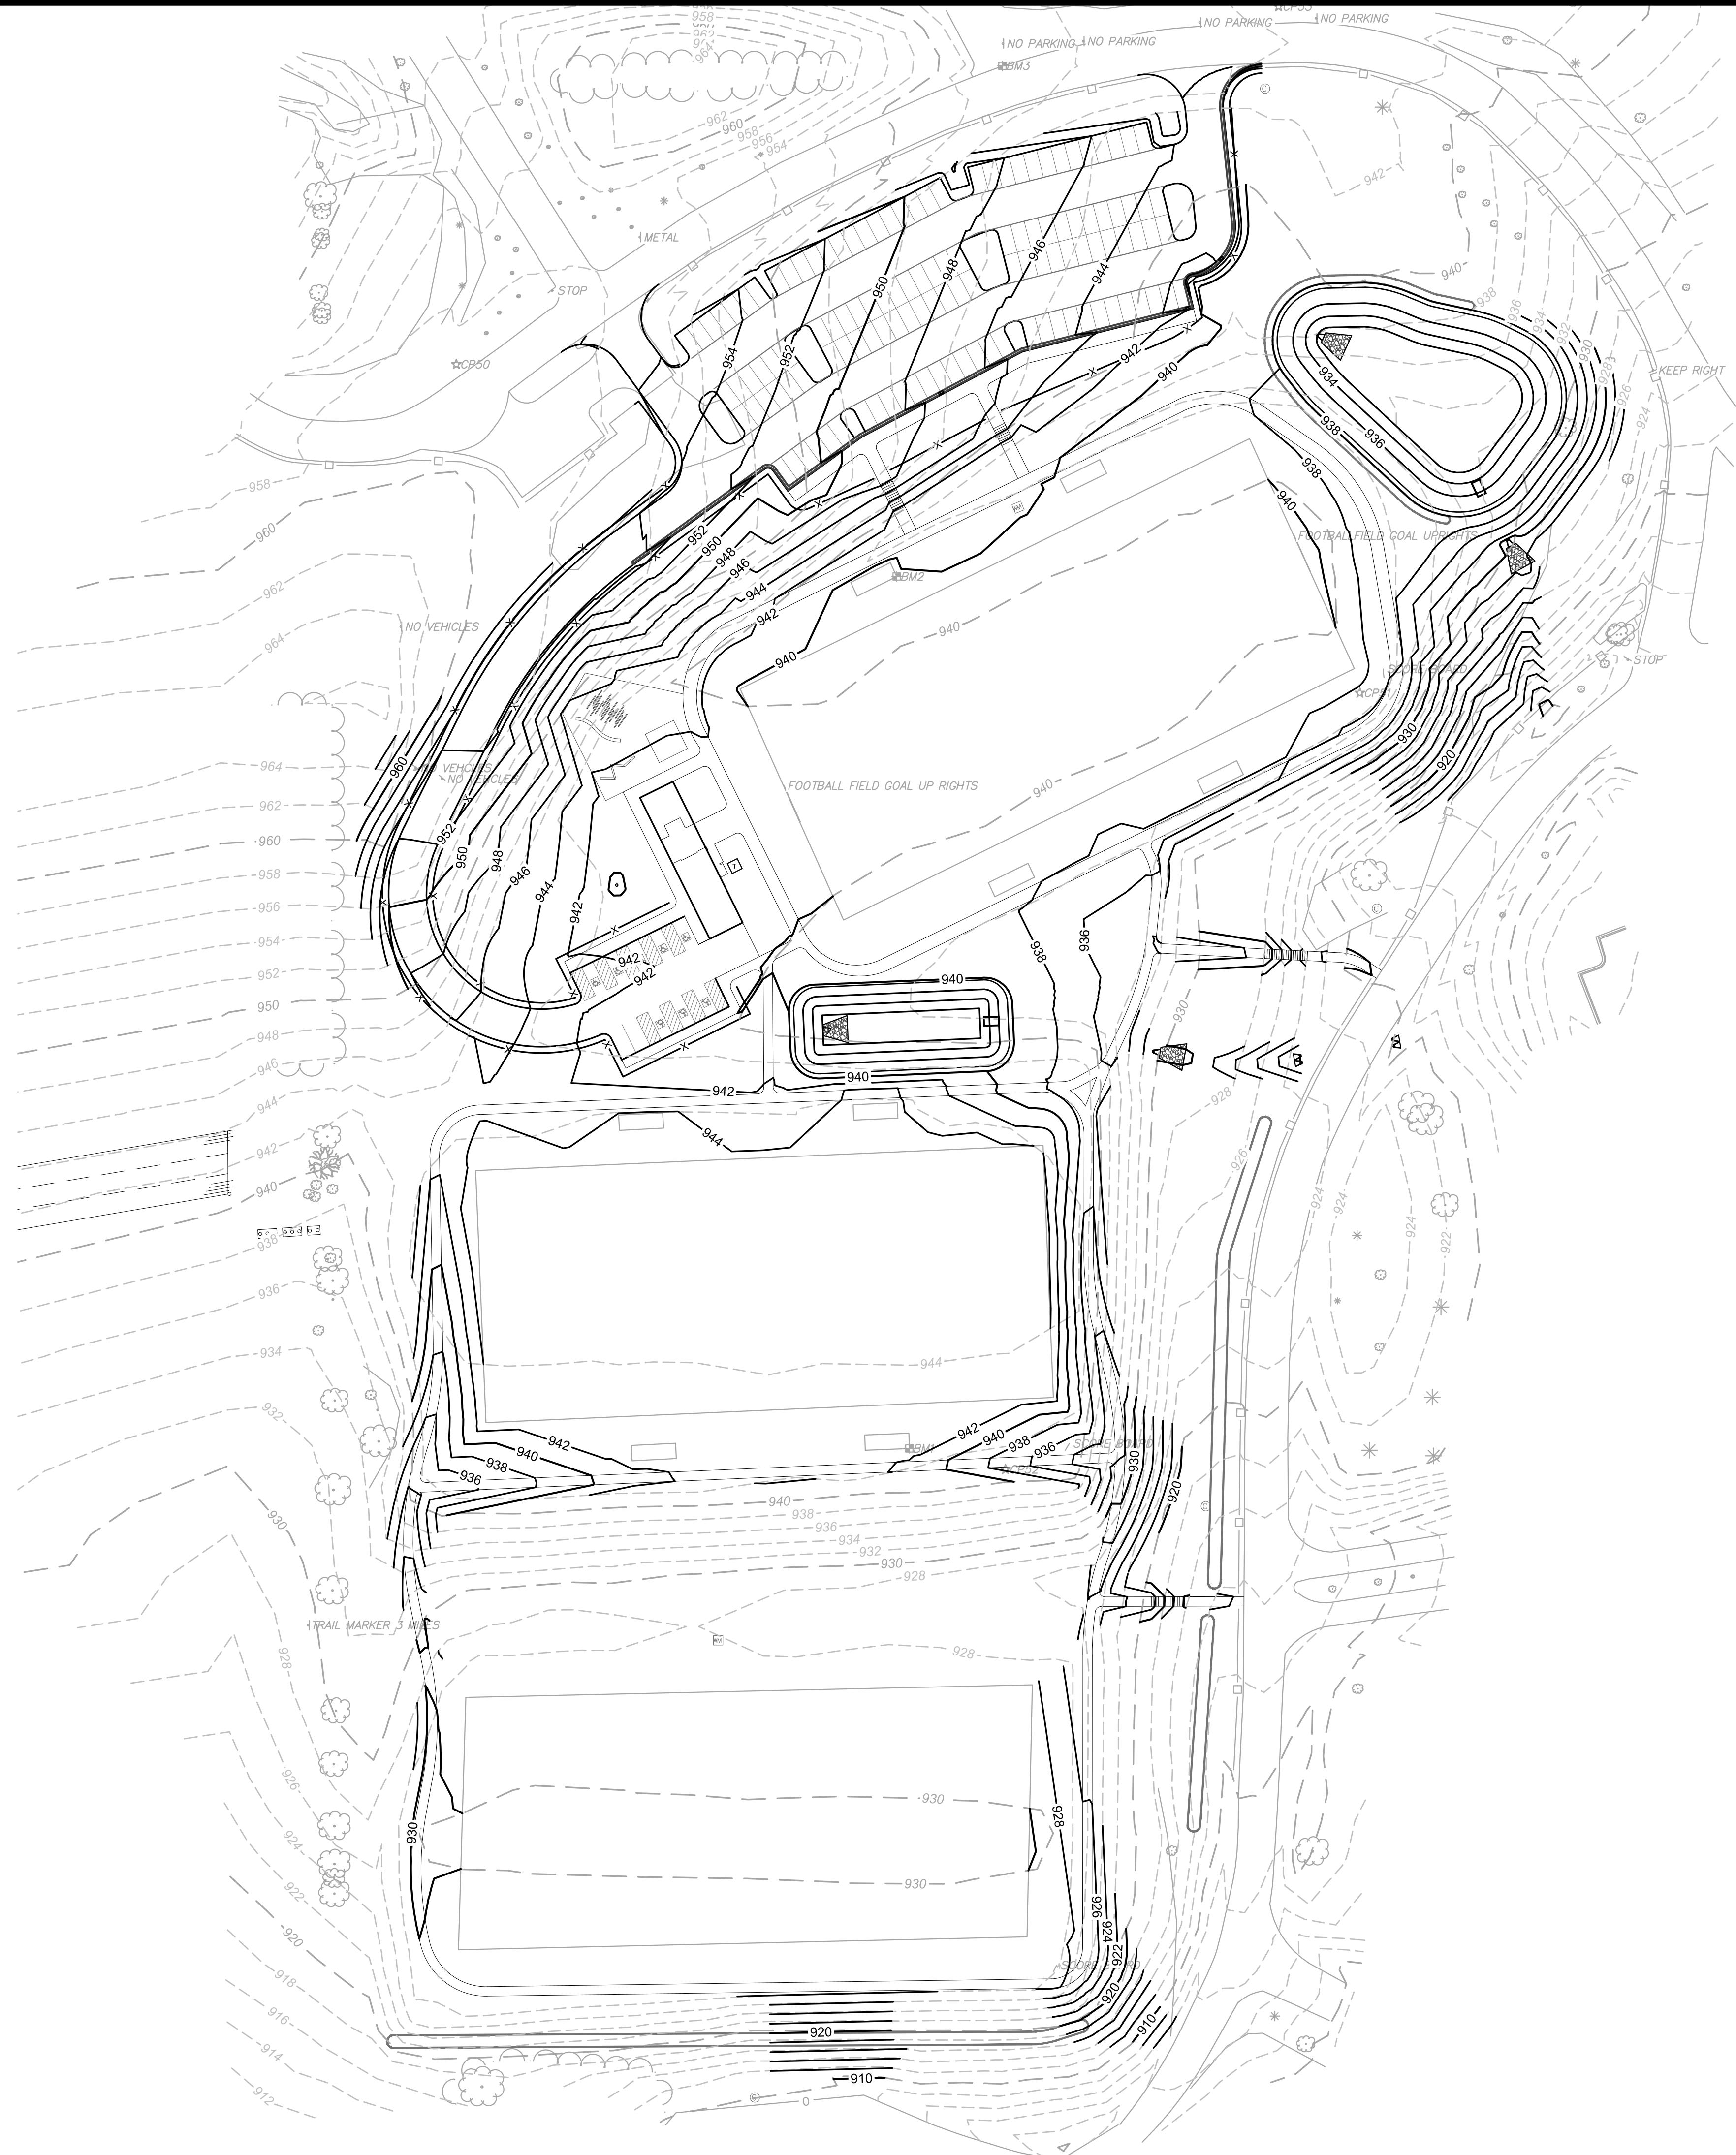
PROJECT INFO
210266-000

PLATTE RIDGE PARK
FOOTBALL COMPLEX IMPROVEMENTS
17130 HIGHWAY 371, PLATTE CITY, MO 64079

GRADING PLAN

DRAWING NO.

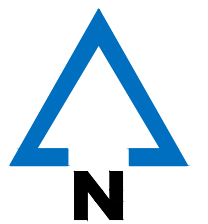
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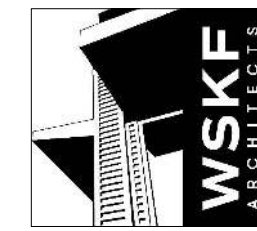
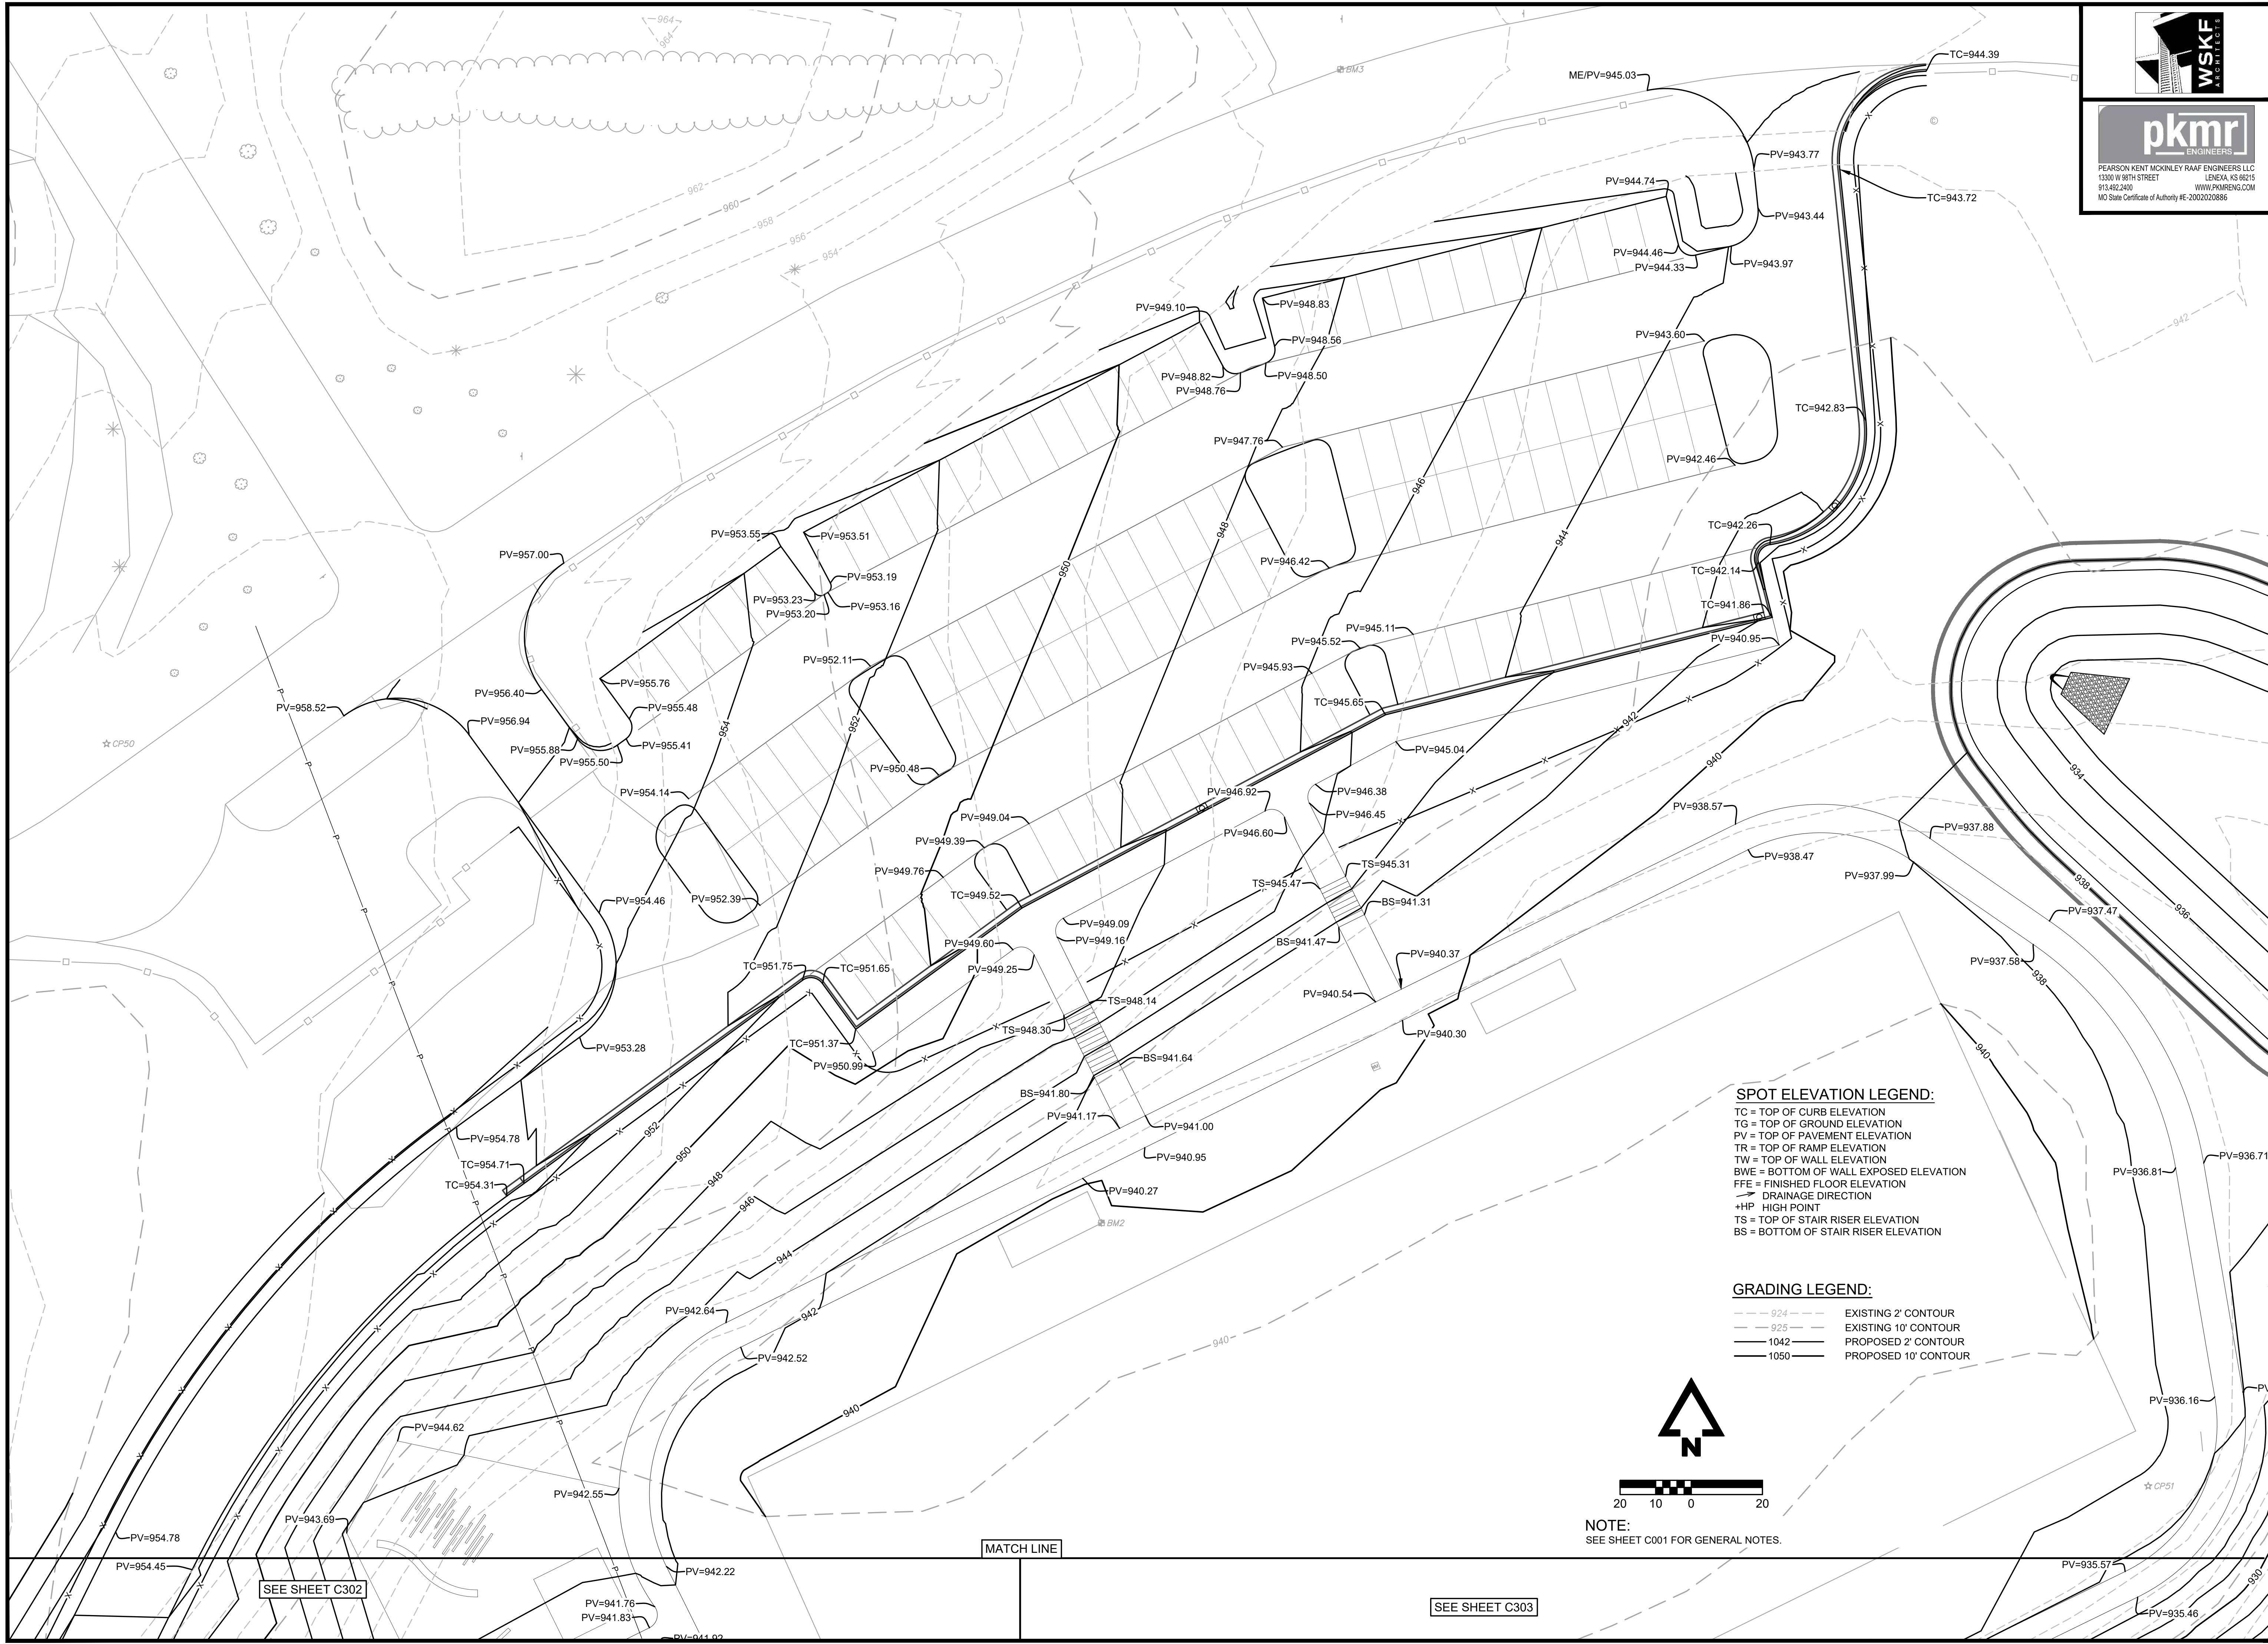


NOTE:
SEE SHEET C001 FOR GENERAL NOTES.

GRADING LEGEND:

--- 924 --- EXISTING 2' CONTOUR
 --- 925 --- EXISTING 10' CONTOUR
 ——— 1042 ——— PROPOSED 2' CONTOUR
 ——— 1050 ——— PROPOSED 10' CONTOUR





pkmr
ENGINEERS
PEARSON KENT MCKINLEY RAAF ENGINEERS LLC
13300 W 88TH STREET LENEXA, KS 66215
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EXPIRES: DECEMBER 31, 2022



REVISIONS

PROJECT INFO

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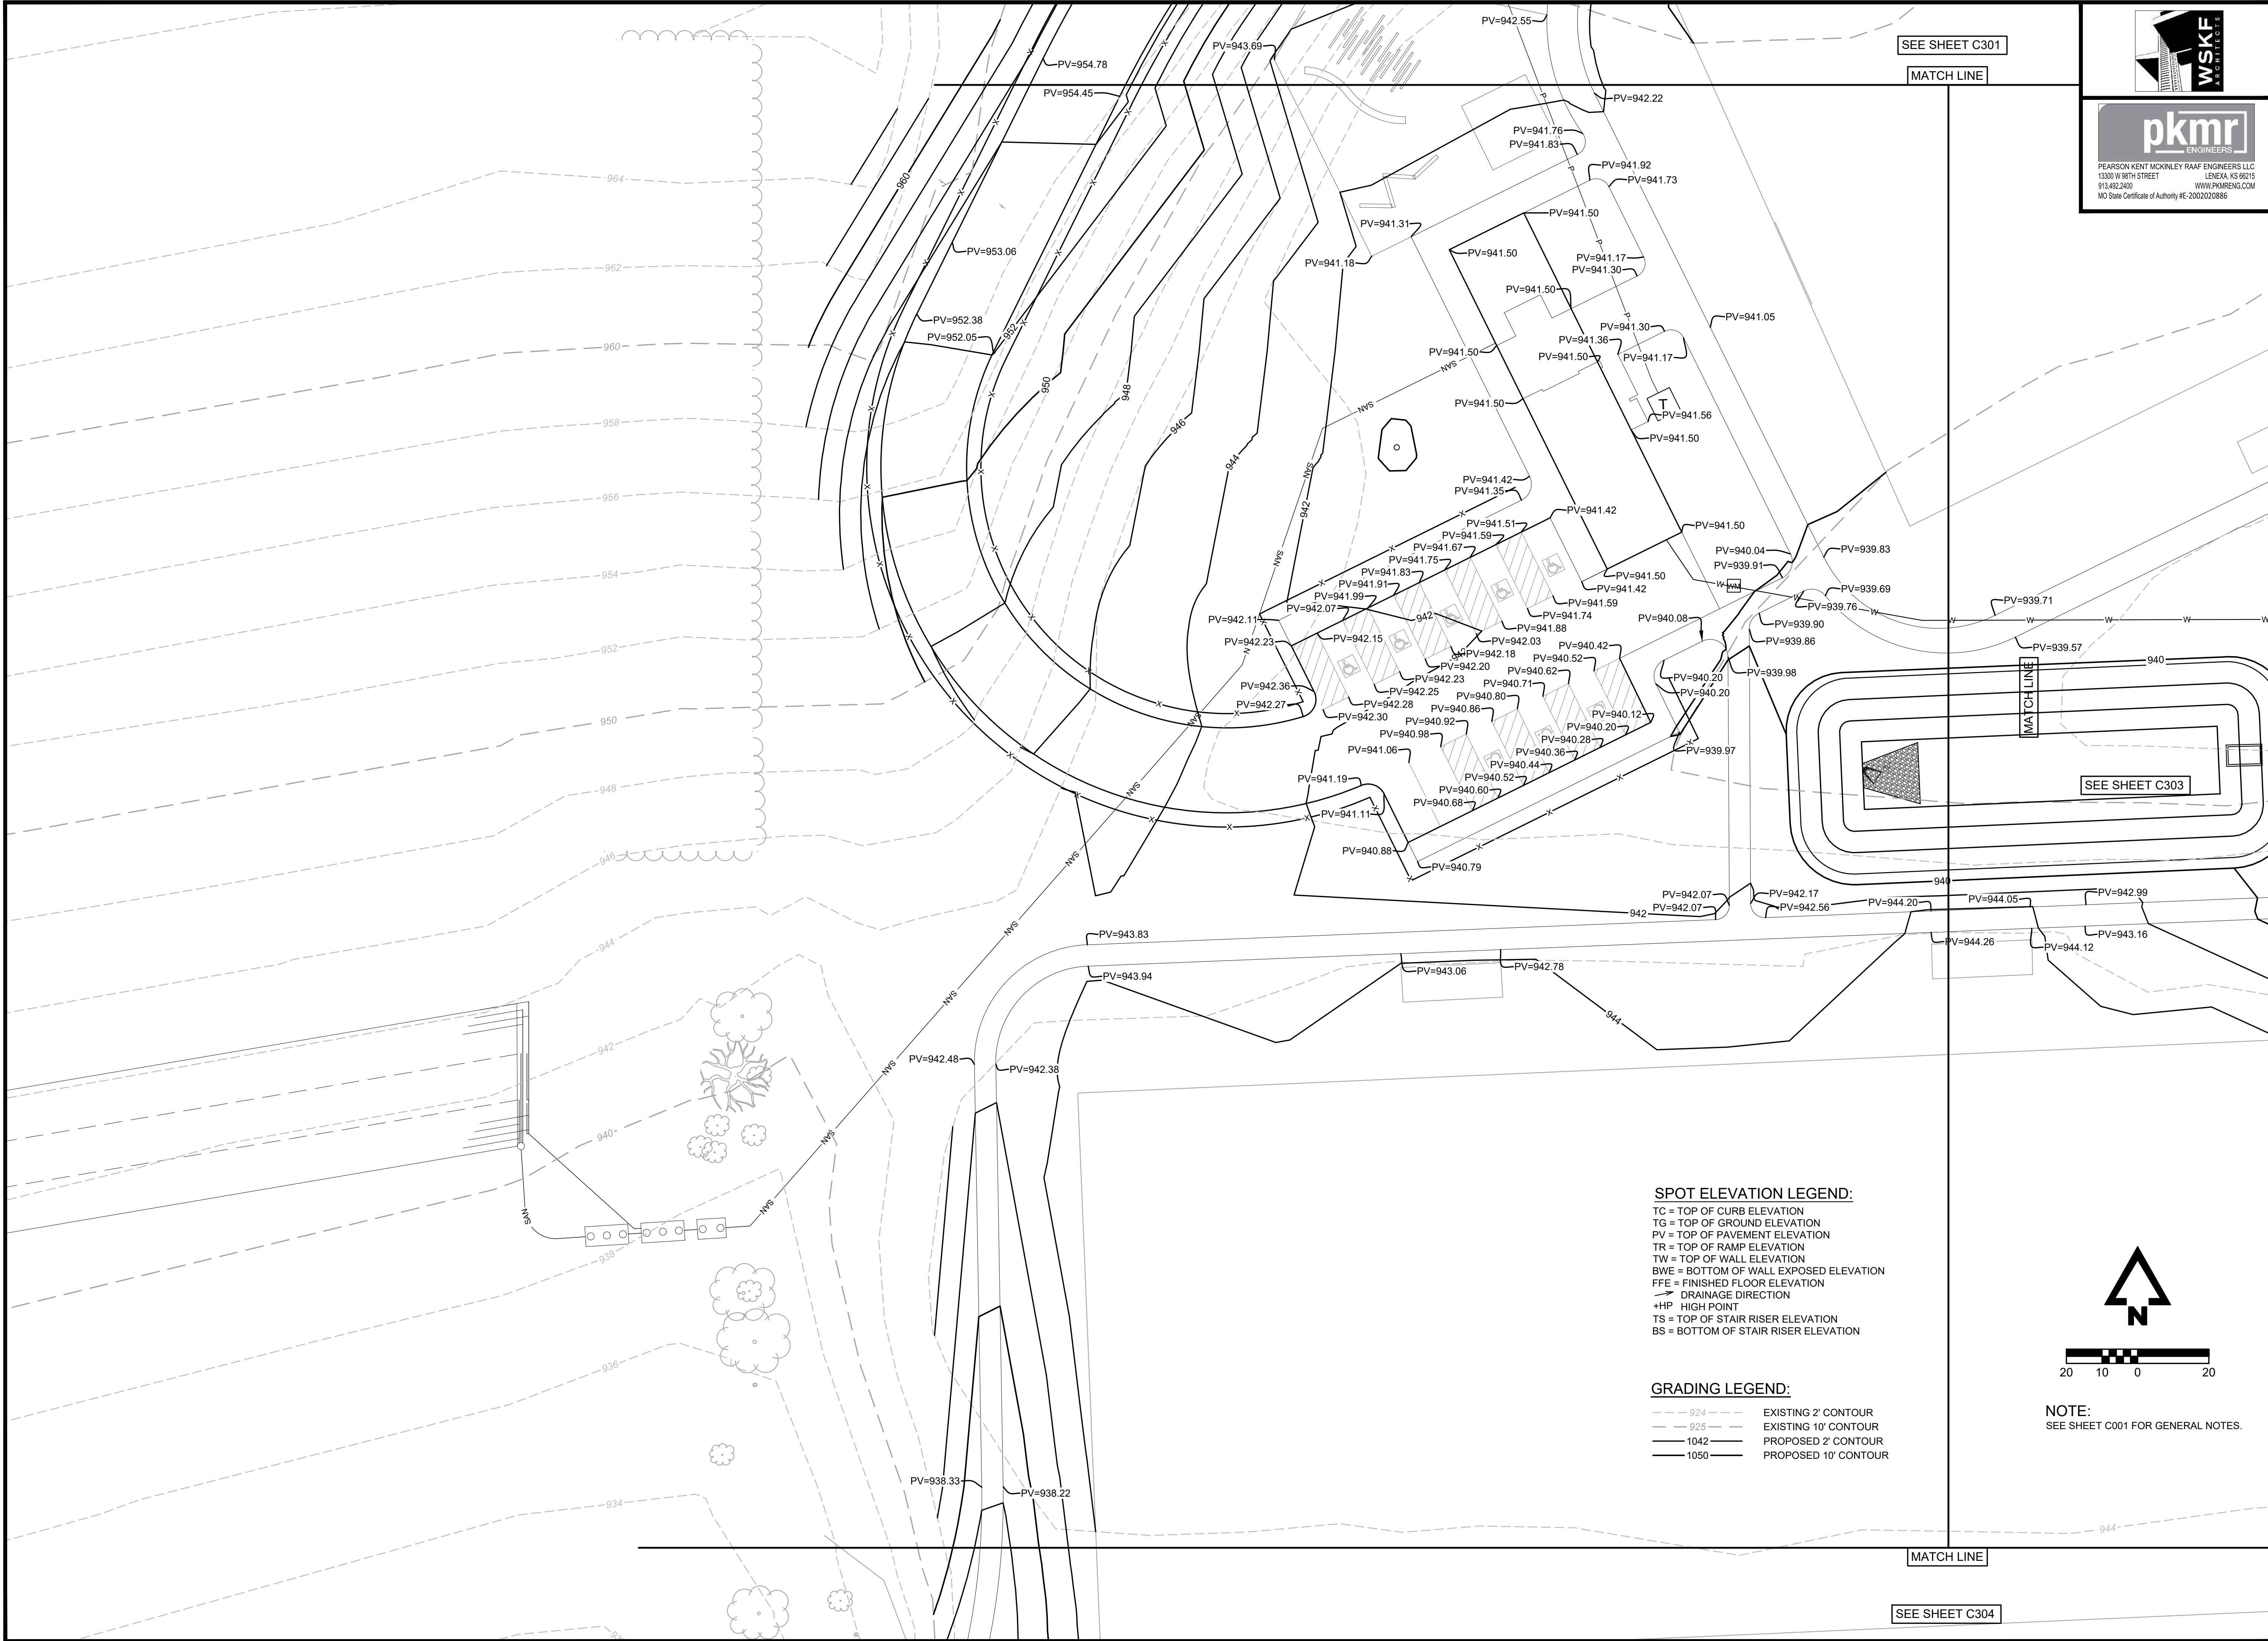
PLATTE RIDGE PARK
FOOTBALL COMPLEX IMPROVEMENTS
17130 HIGHWAY 371, PLATTE CITY, MO 64079

ENLARGED GRADING PLAN


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DRAWING NO.

C301



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MISSOURI CERTIFICATE OF AUTHORITY NO. E-2006023253
EXPIRES: DECEMBER 31, 2022




REVISIONS		
PROJECT INFO		
210266-000		
ENGINEER	DRAWN BY	CHECKED BY
	AVD	AVD

SPOT ELEVATION LEGEND:

- TC = TOP OF CURB ELEVATION
- TG = TOP OF GROUND ELEVATION
- PV = TOP OF PAVEMENT ELEVATION
- TR = TOP OF RAMP ELEVATION
- TW = TOP OF WALL ELEVATION
- BWE = BOTTOM OF WALL EXPOSED ELEVATION
- FFE = FINISHED FLOOR ELEVATION
- DRAINAGE DIRECTION
- +HP HIGH POINT
- TS = TOP OF STAIR RISER ELEVATION
- BS = BOTTOM OF STAIR RISER ELEVATION

GRADING LEGEND:

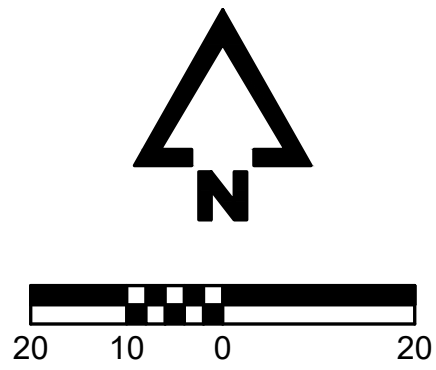- - - 924 - - - EXISTING 2' CONTOUR
- - - 925 - - - EXISTING 10' CONTOUR
- 1042 — PROPOSED 2' CONTOUR
- 1050 — PROPOSED 10' CONTOUR



NOTE:
SEE SHEET C001 FOR GENERAL NOTES.

PLATTE RIDGE PARK
FOOTBALL COMPLEX IMPROVEMENTS
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ENLARGED GRADING PLAN

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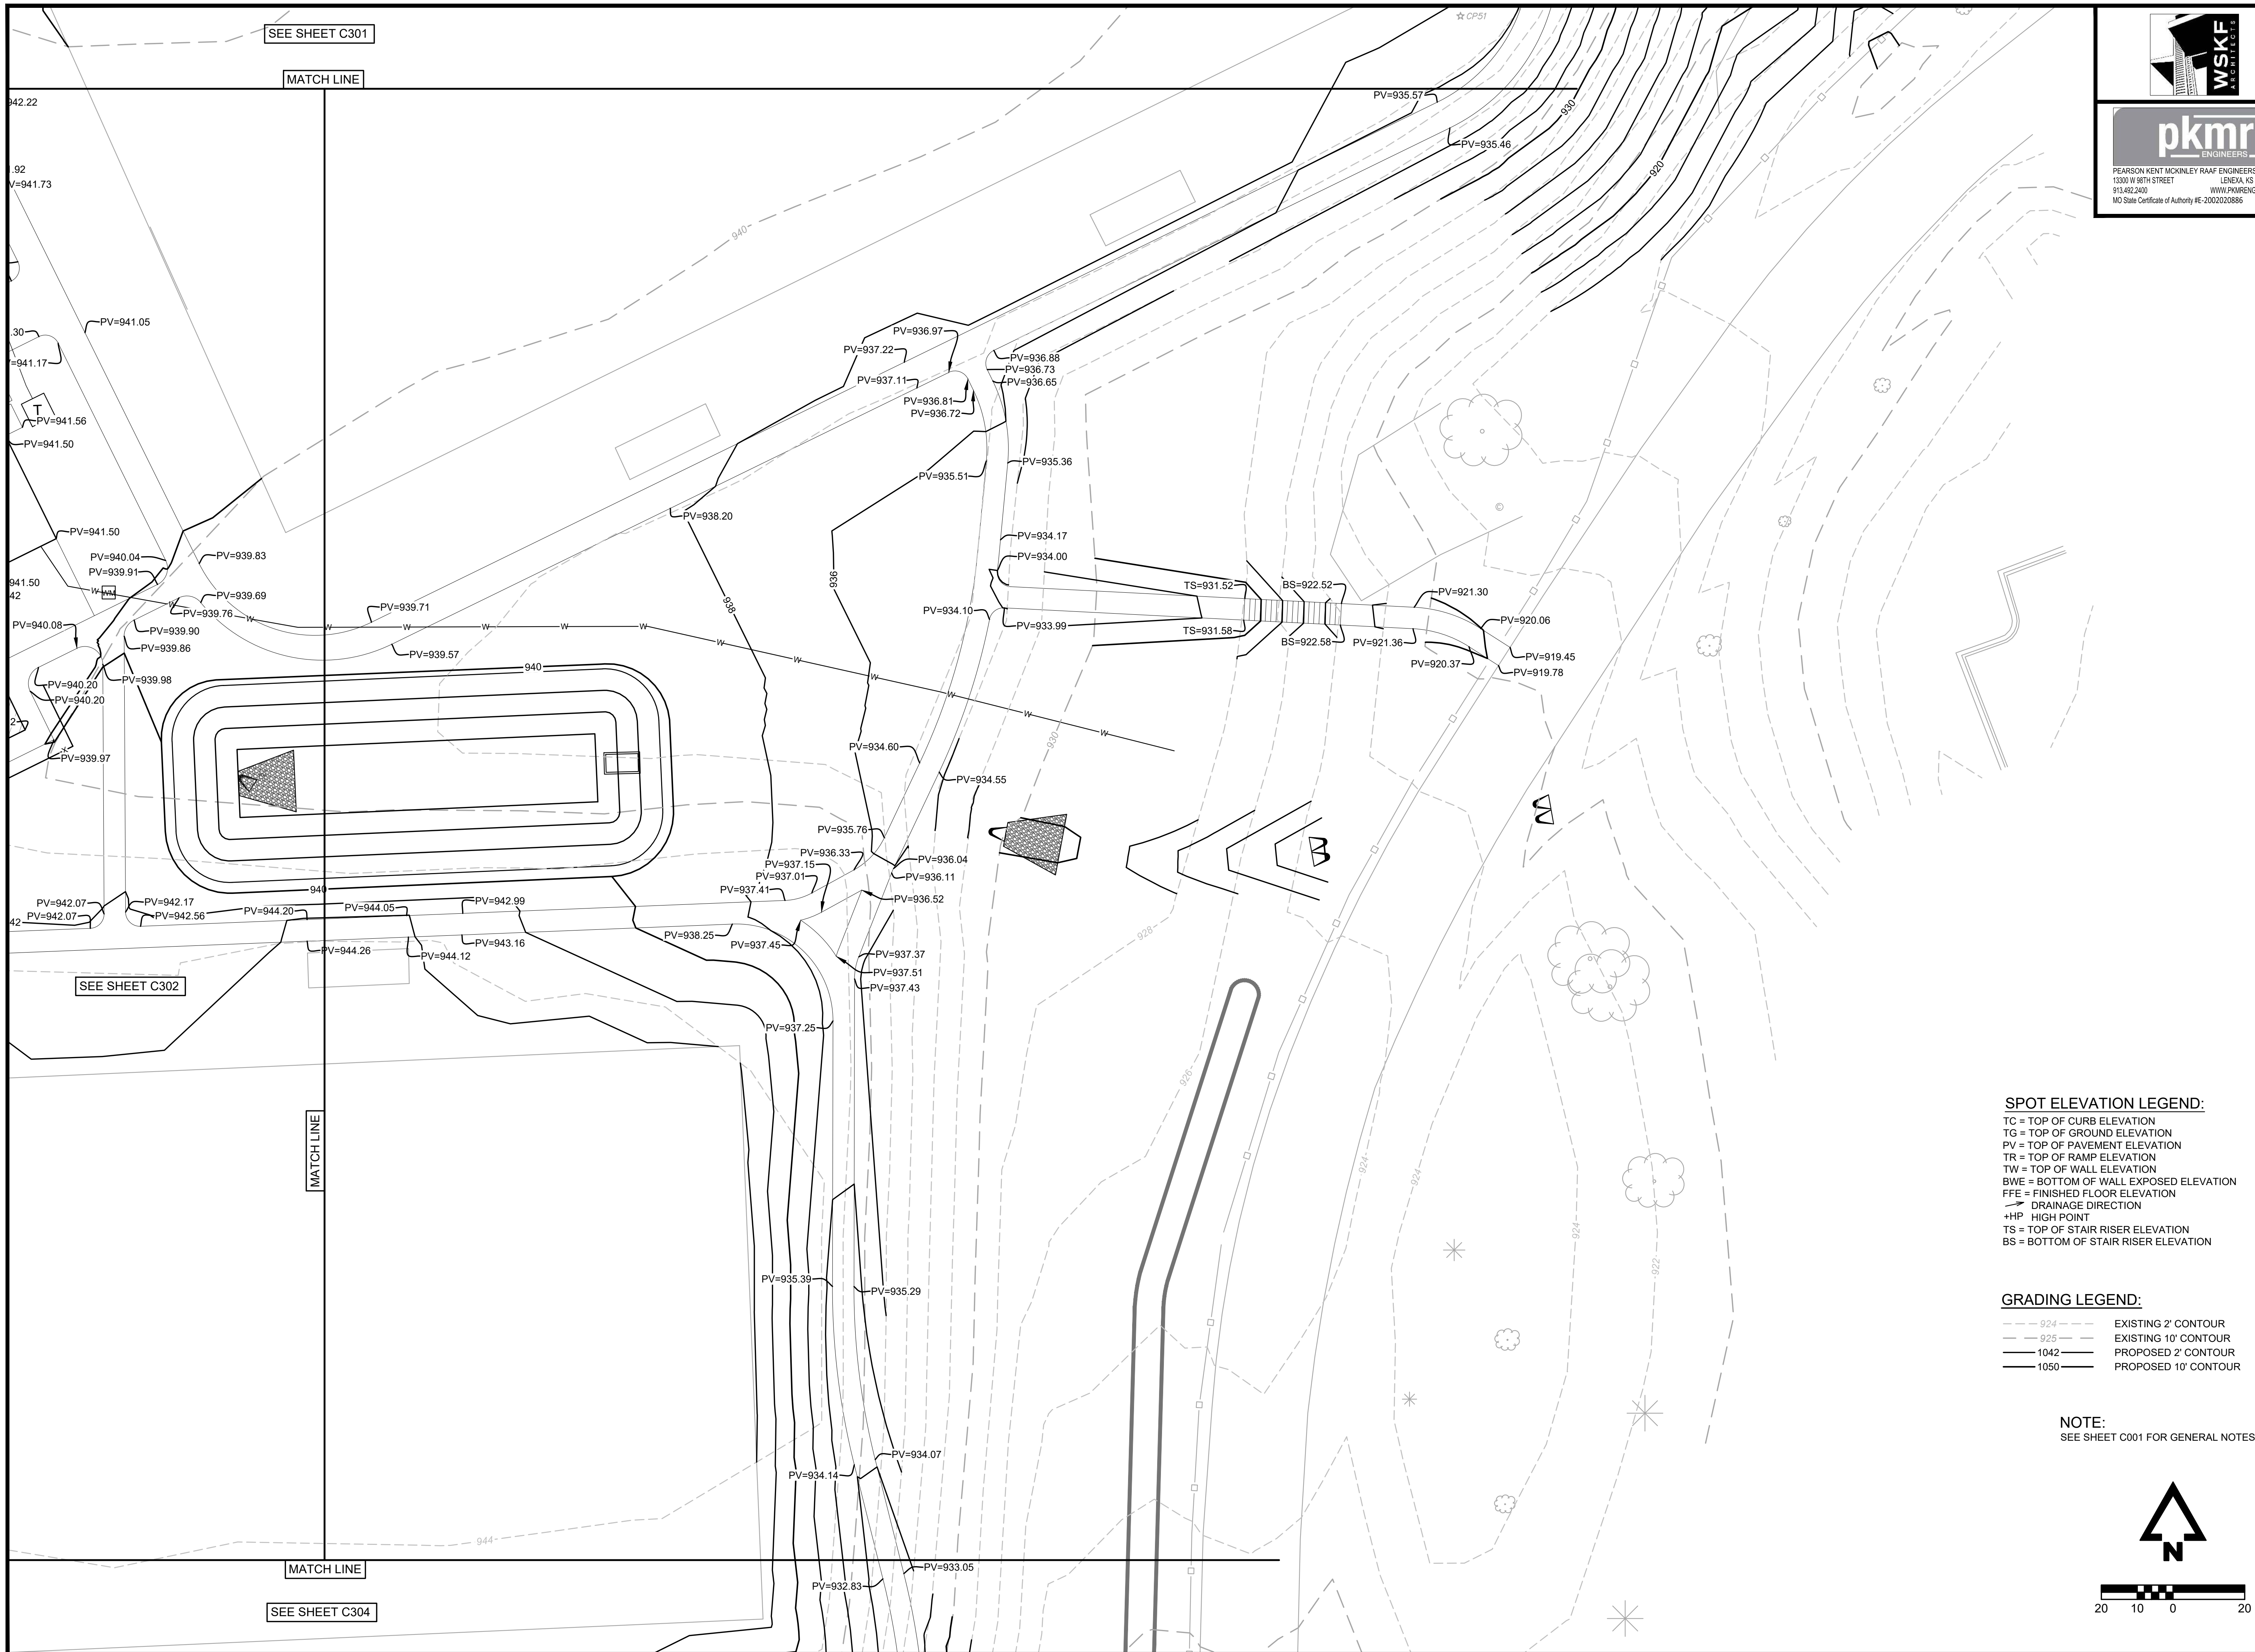
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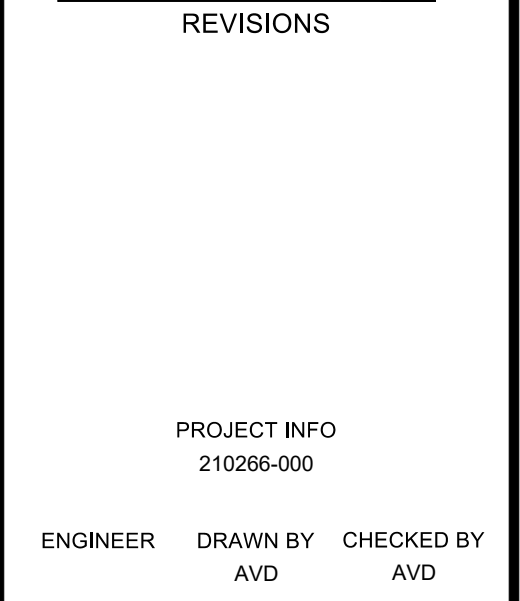
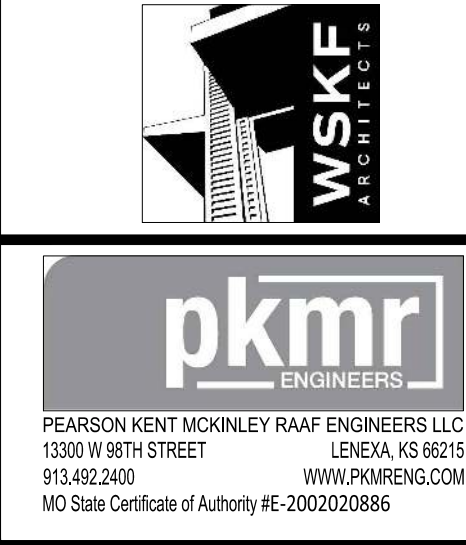
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ENLARGED GRADING PLAN

DRAWING NO.

C303





DRAWING NO.
C304



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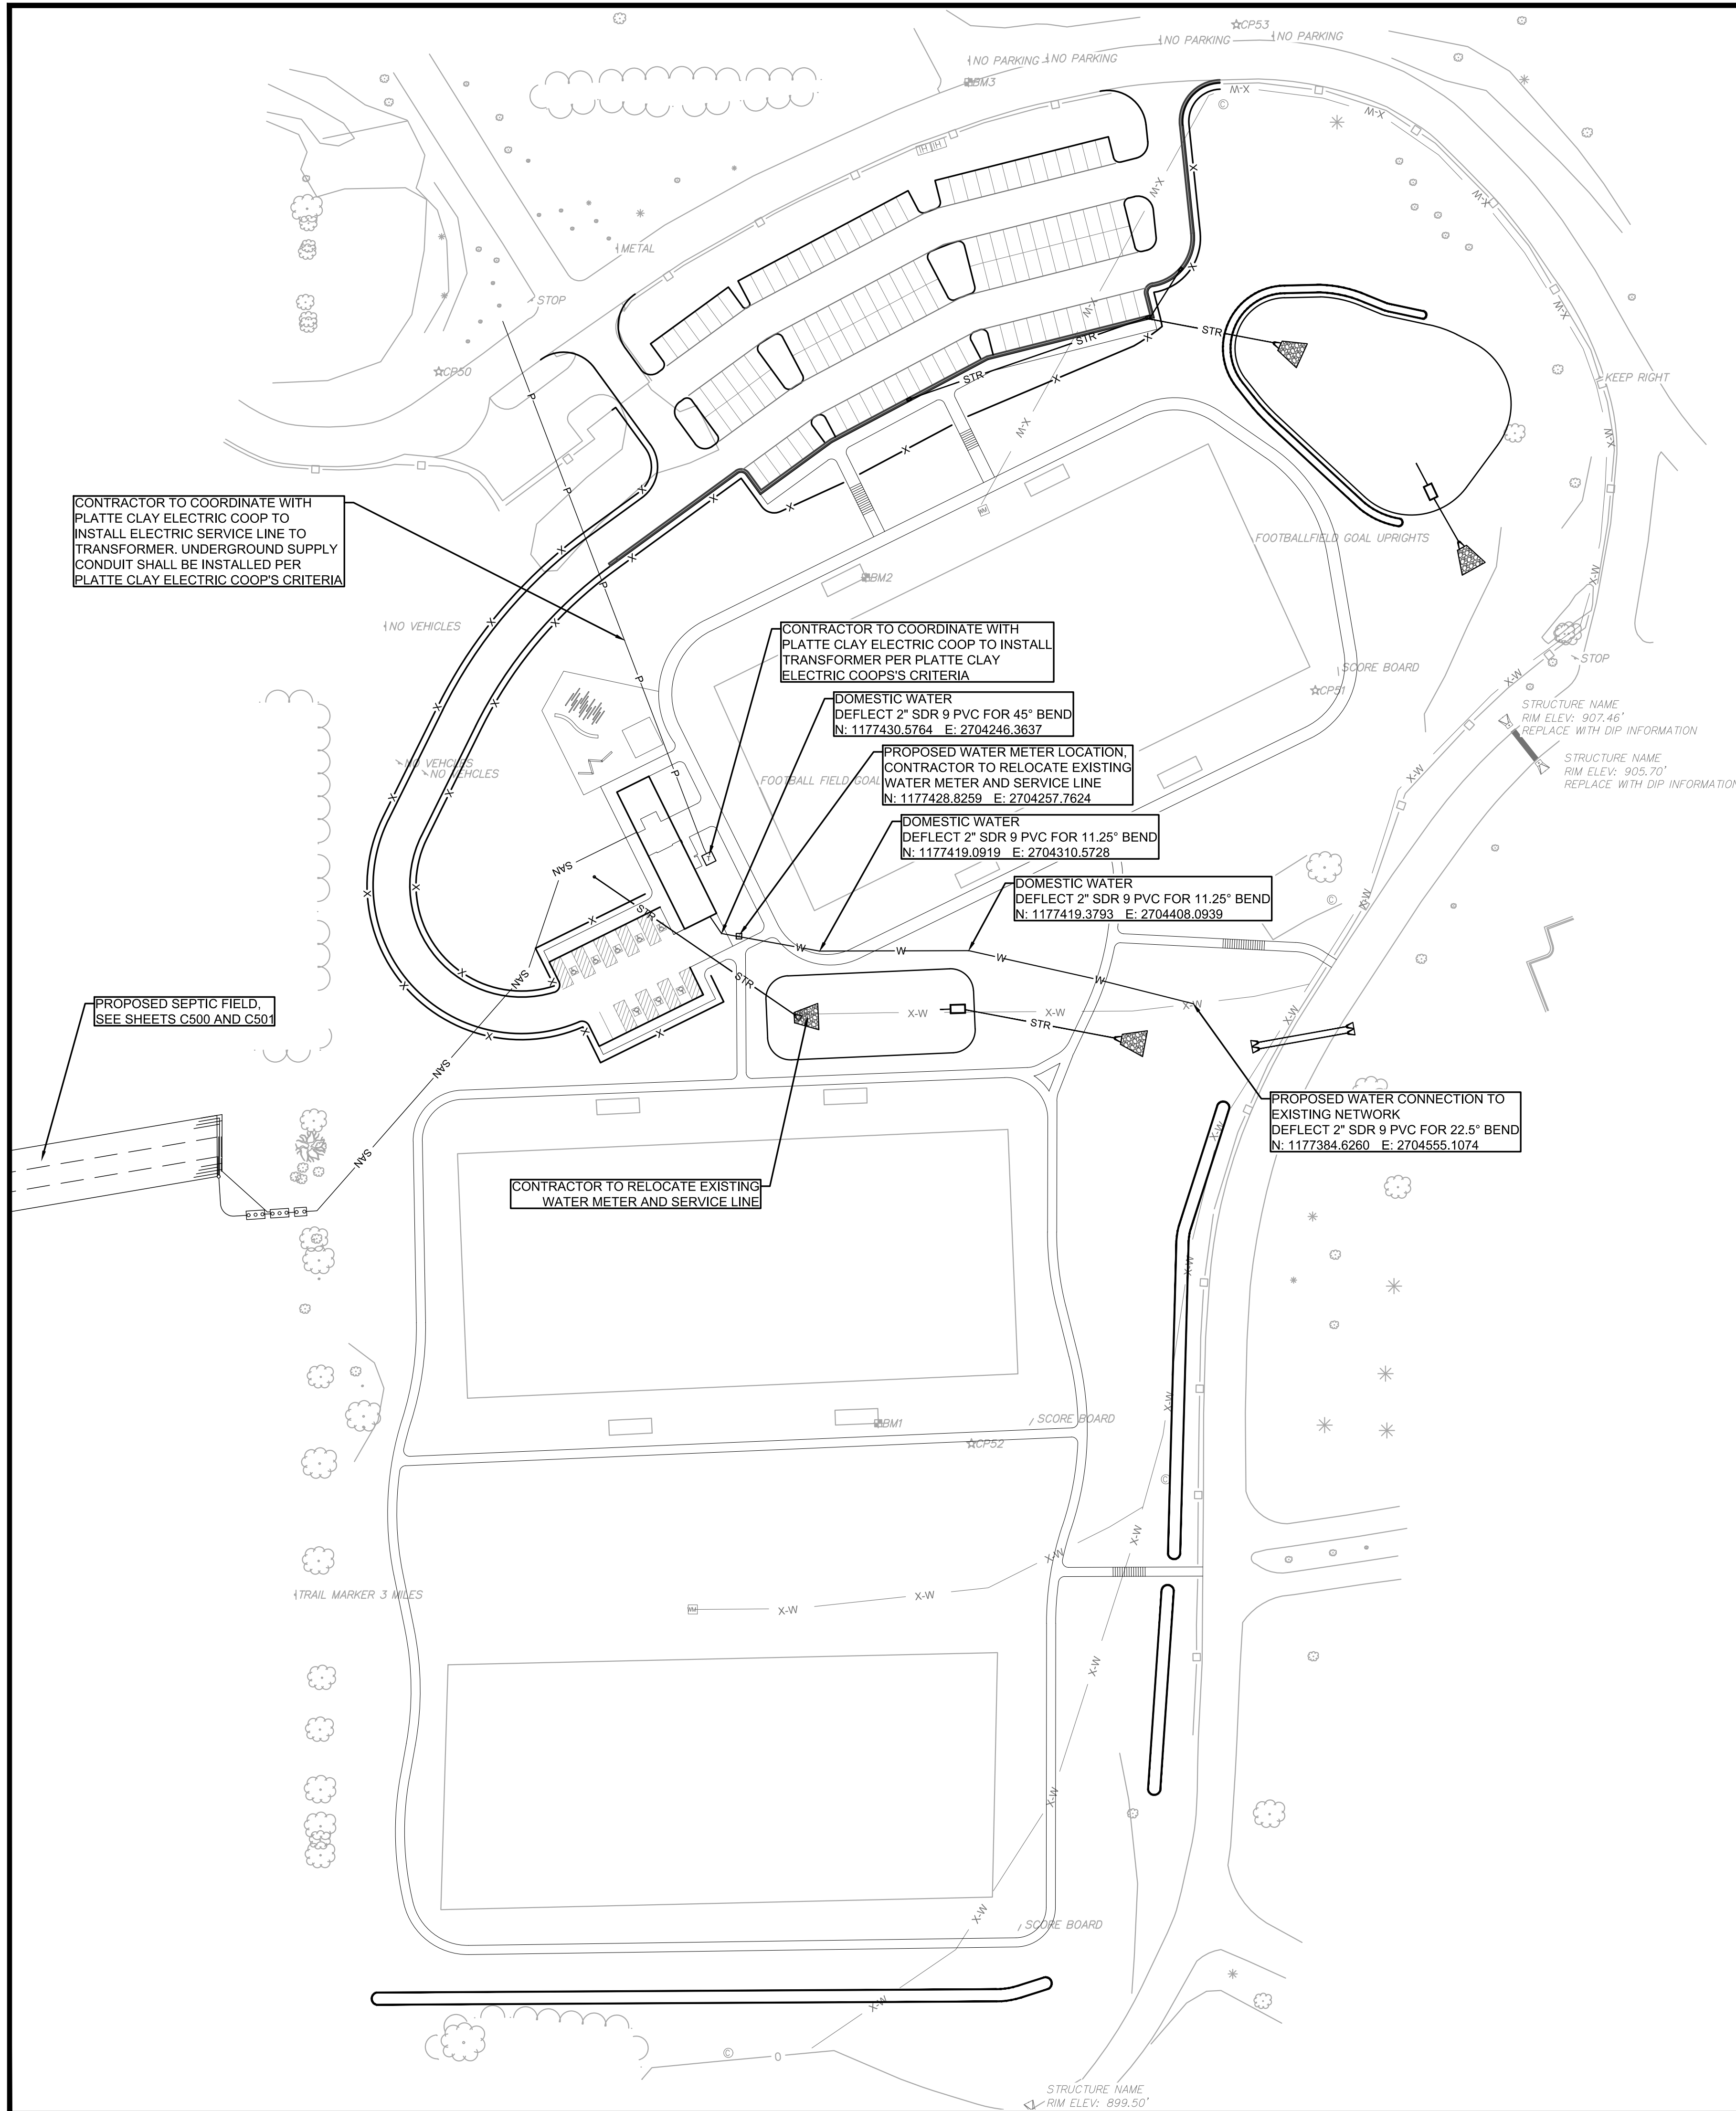
PLATTE RIDGE PARK
FOOTBALL COMPLEX IMPROVEMENTS
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UTILITY PLAN














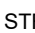
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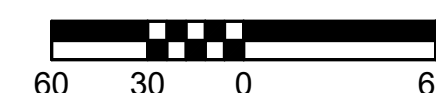
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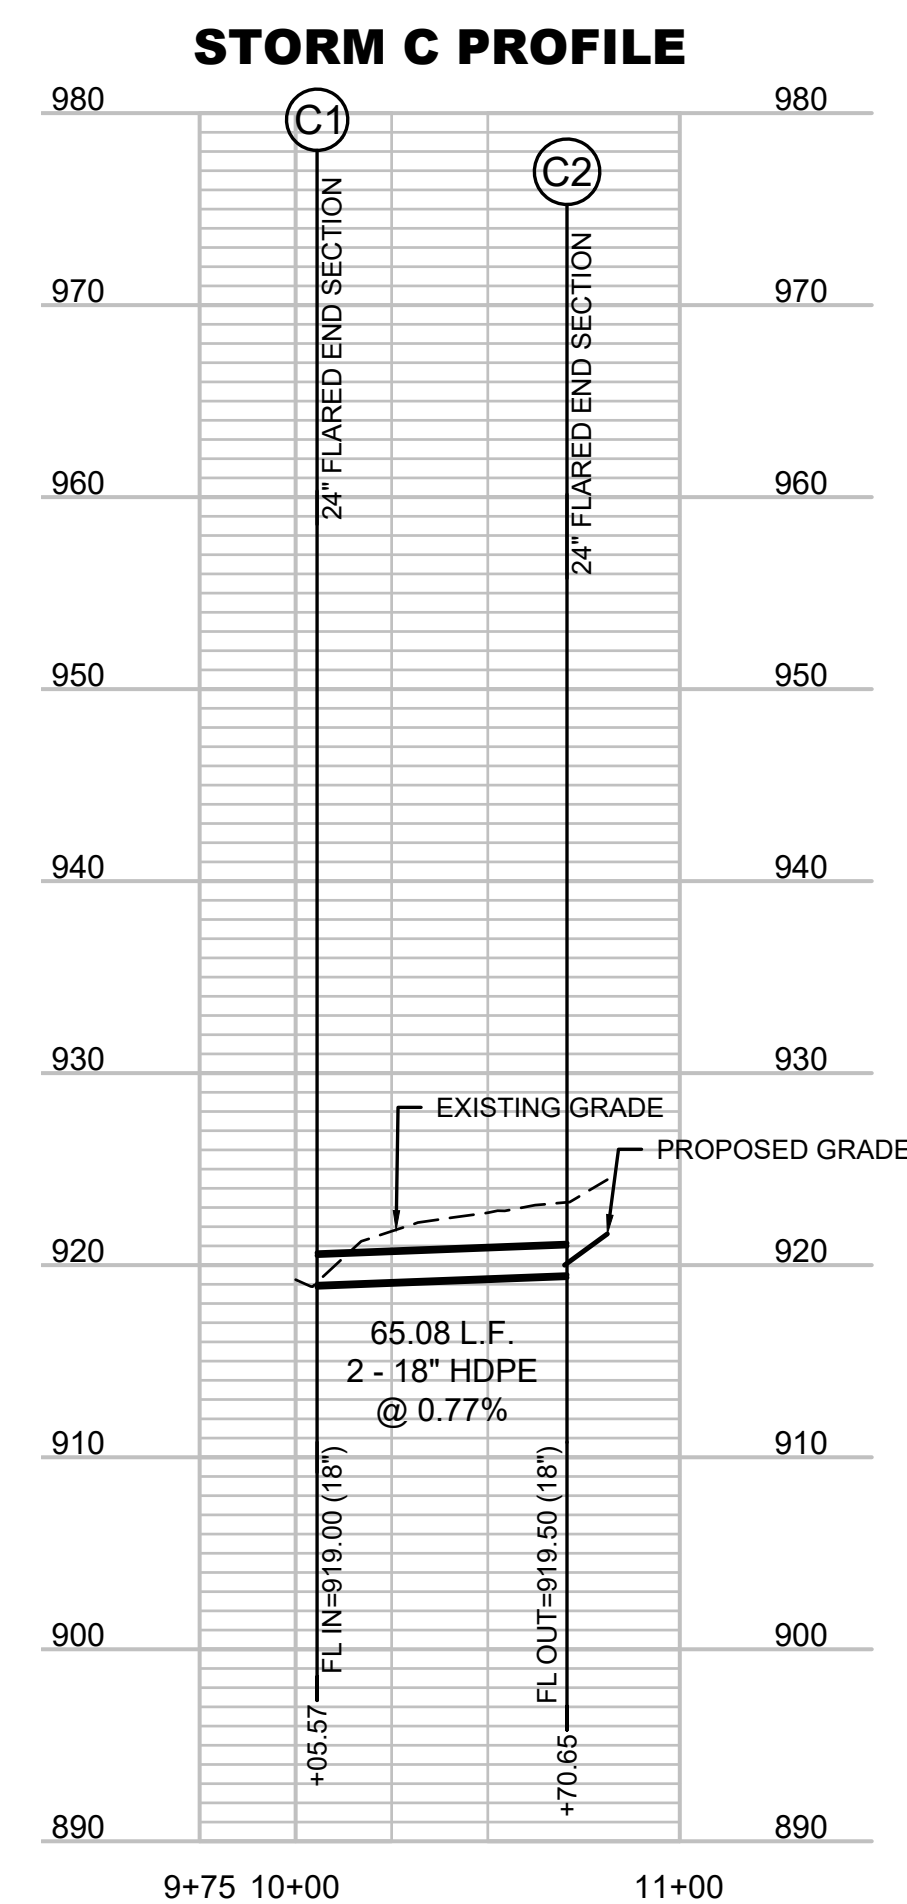
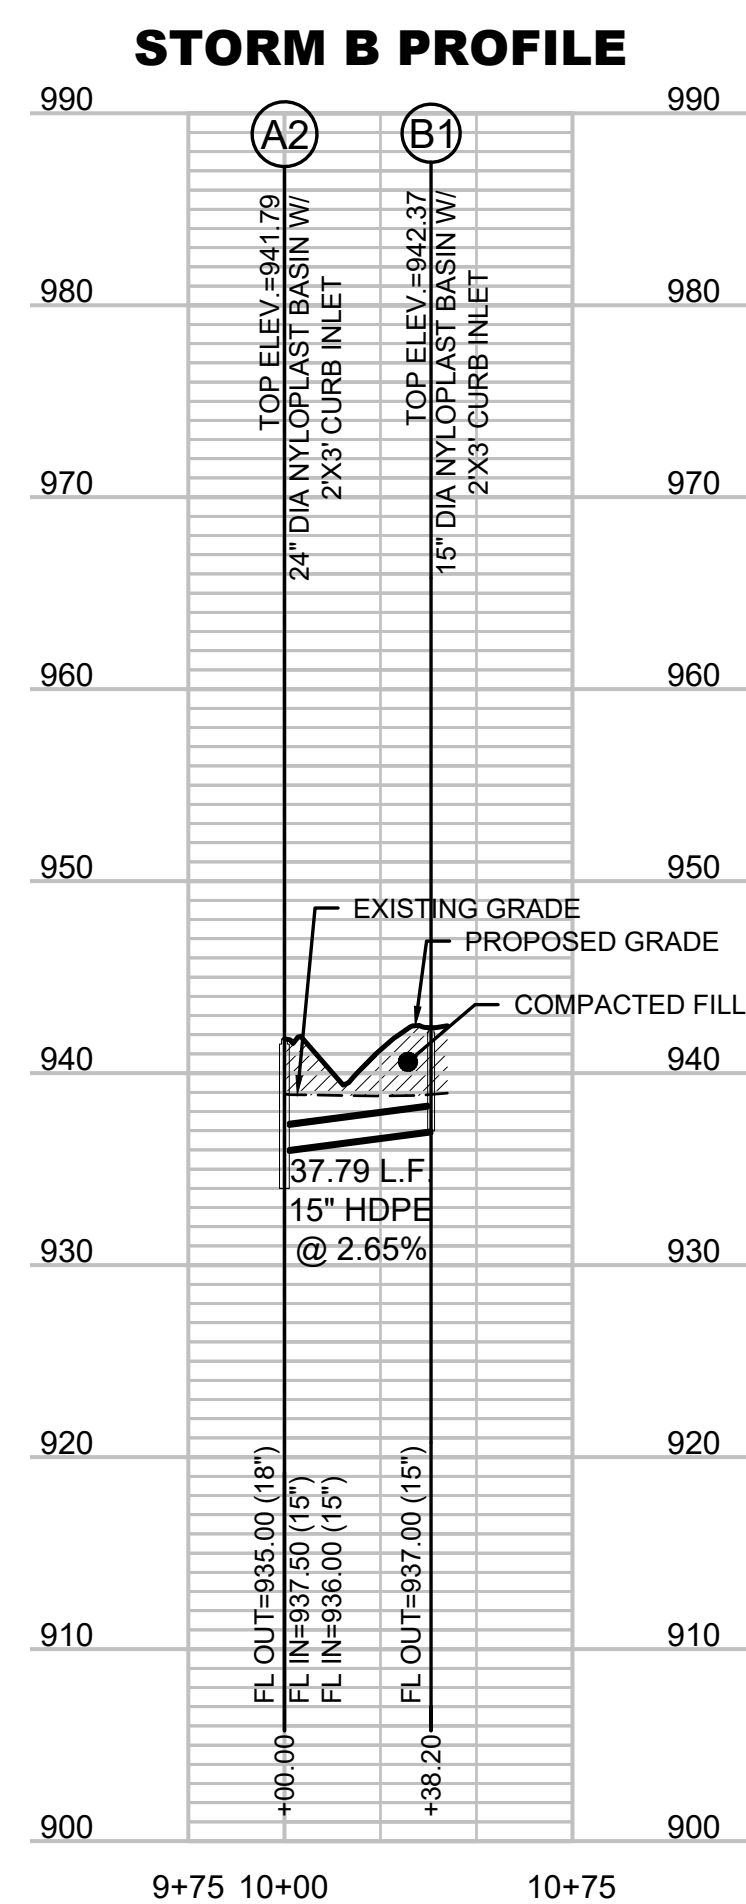
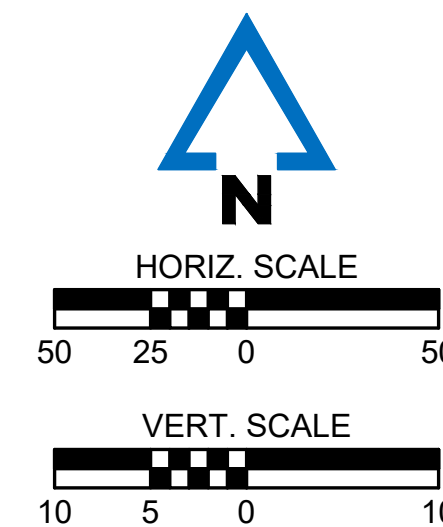


UTILITY LEGEND

XSAN	EX. SANITARY SEWER LINE
XUGT	EX. UNDERGROUND TELEPHONE LINE
XSTM	EX. STORM SEWER LINE
XUGE	EX. UNDERGROUND ELECTRIC LINE
XW	EX. WATER LINE
XOHE	EX. OVERHEAD ELECTRIC
	EX. SIGN
	EX. FIBER OPTIC HAND HOLE
	EX. WATER METER
	EX. ELECTRIC HAND HOLE
	EX. COMMUNICATIONS HAND HOLE
	EX. COMMUNICATIONS MANHOLE
	EX. TELEPHONE PEDESTAL
	EX. WATER VALVE
	EX. STORM MANHOLE
	EX. LIGHT POLE
	EX. SANITARY MANHOLE
	EX. FIRE HYDRANT
	NEW WATER VALVE
	NEW STORM SEWER INTAKE
STR	NEW STORM SEWER LINE
FO	NEW FIBER OPTIC LINE
W	NEW WATER LINE
FW	NEW FIRE SERVICE LINE
SAN	NEW SANITARY SEWER LINE
-	PROPERTY LINE OF SUBJECT PROPERTY
G	NEW GAS LINE
C	NEW CABLE LINE
E	NEW ELECTRIC LINE

NOTE:
SEE SHEET C001 FOR GENERAL NOTES.





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AUTHORITY NO. E-2006023253
EXPIRES: DECEMBER 31, 2022



REVISIONS

PROJECT INFO
210266-000

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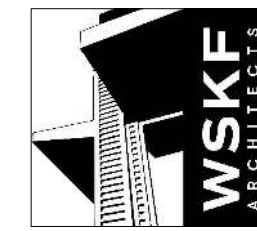
PLATTE RIDGE PARK
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17130 HIGHWAY 371, PLATTE CITY, MO 64079

SIORM PLAN AND PROFILES

1006-DRAWINGS-CIVIL-CONS-TRUC-110N-DCCSZ-10Z00-000-FNF-DWGS

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C401



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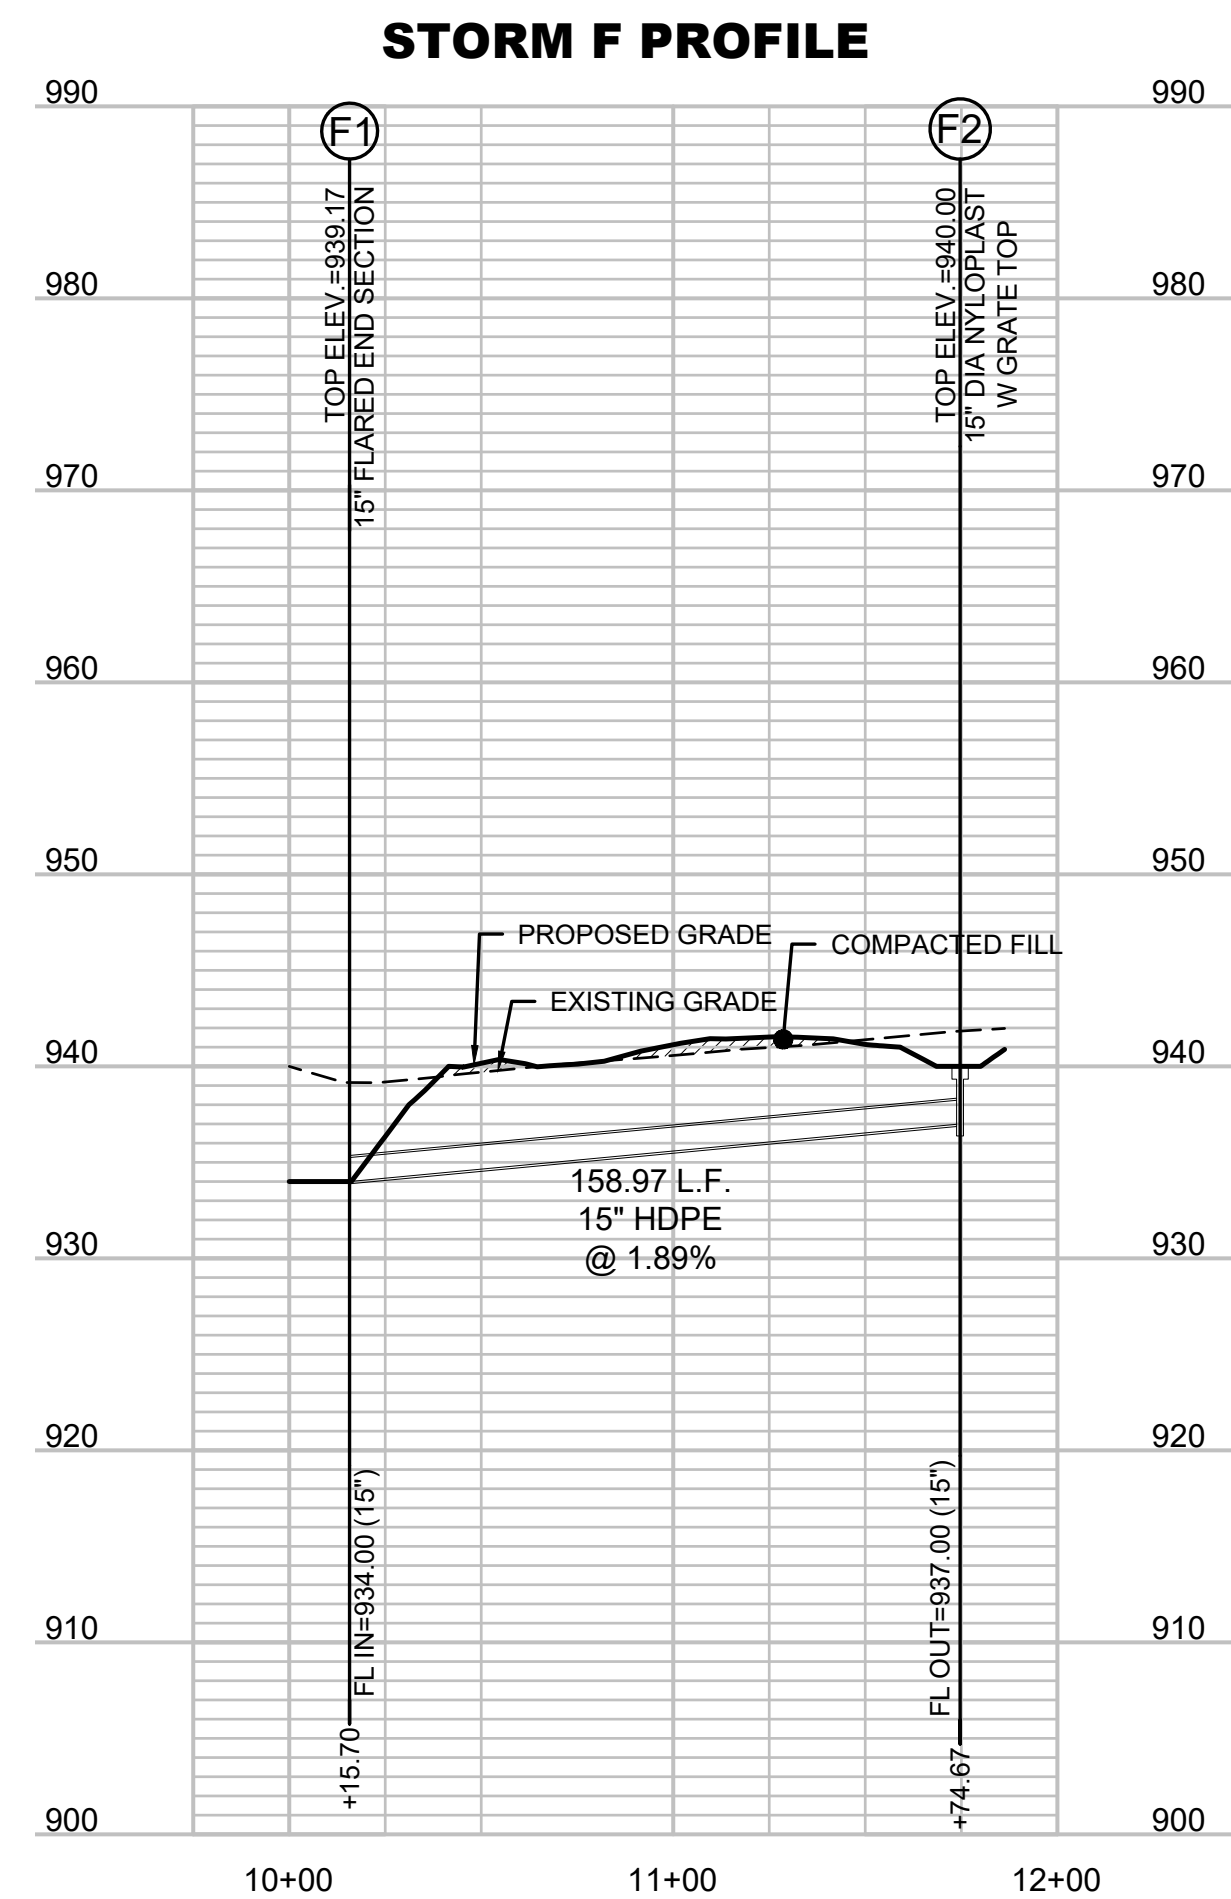
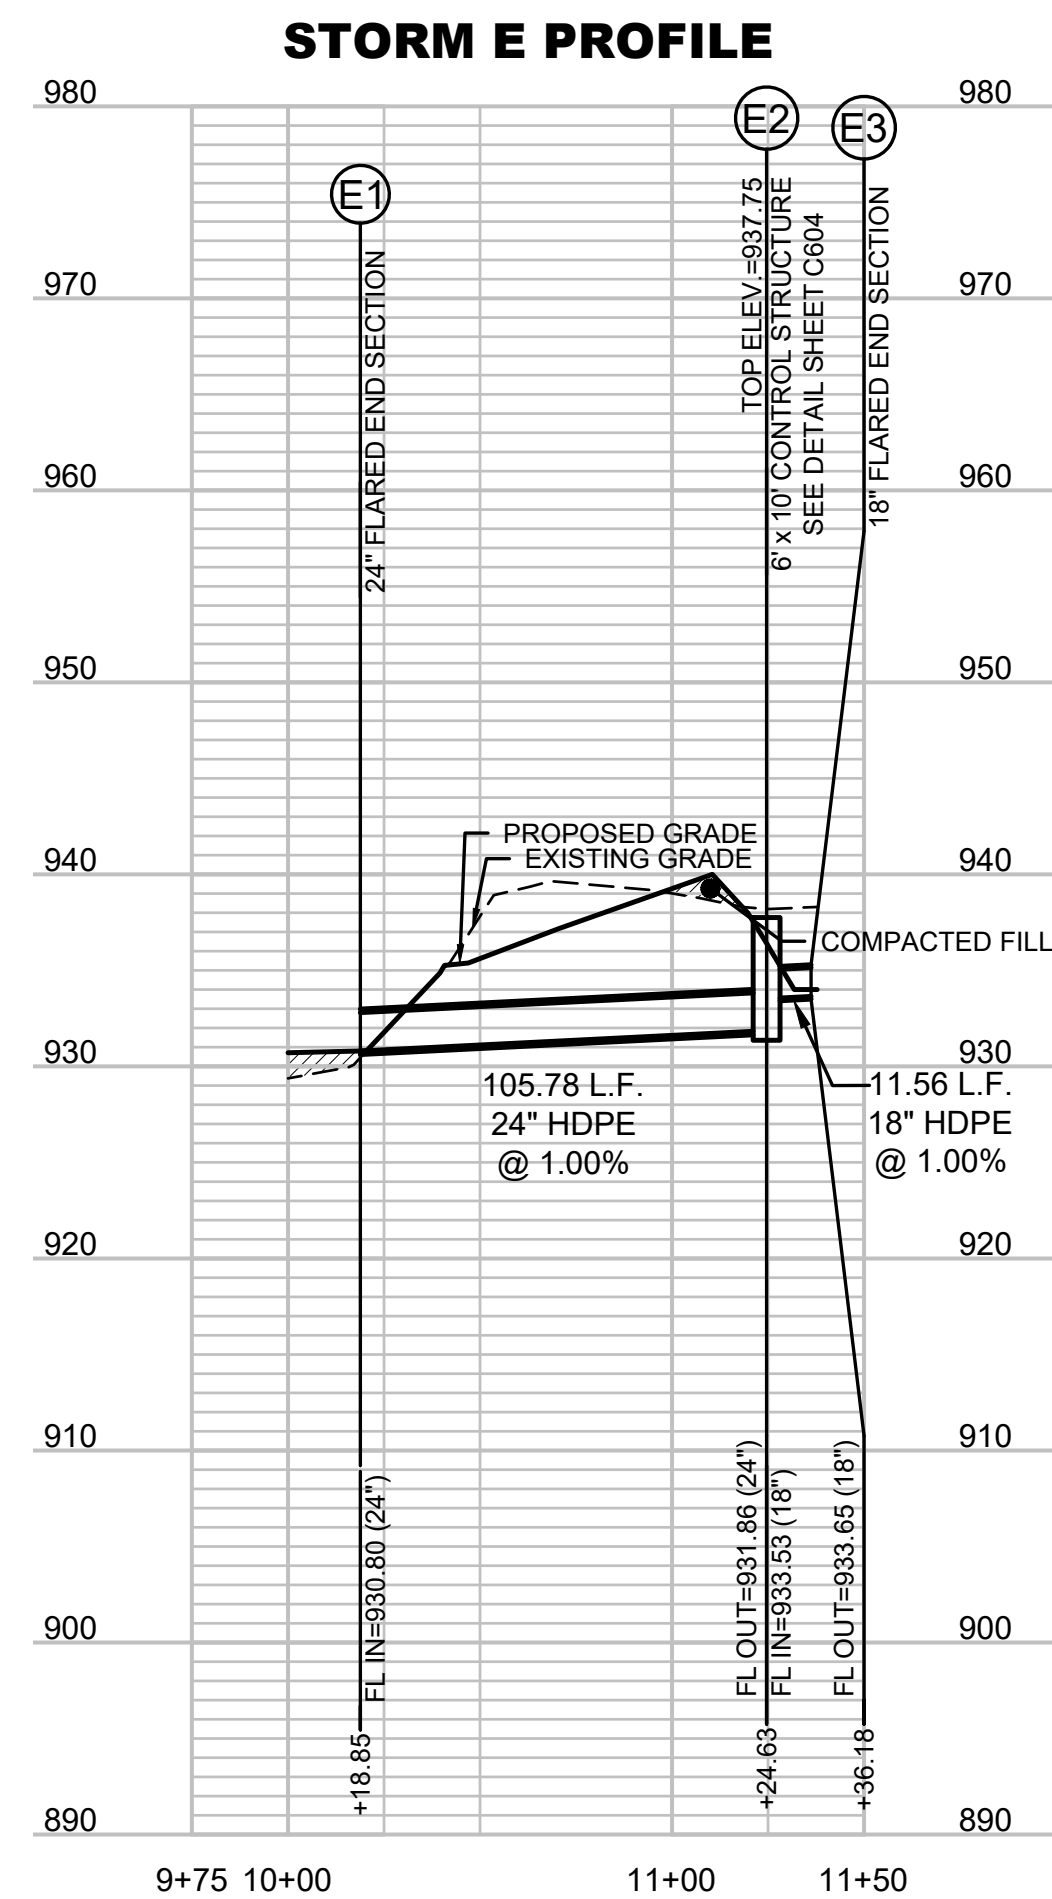
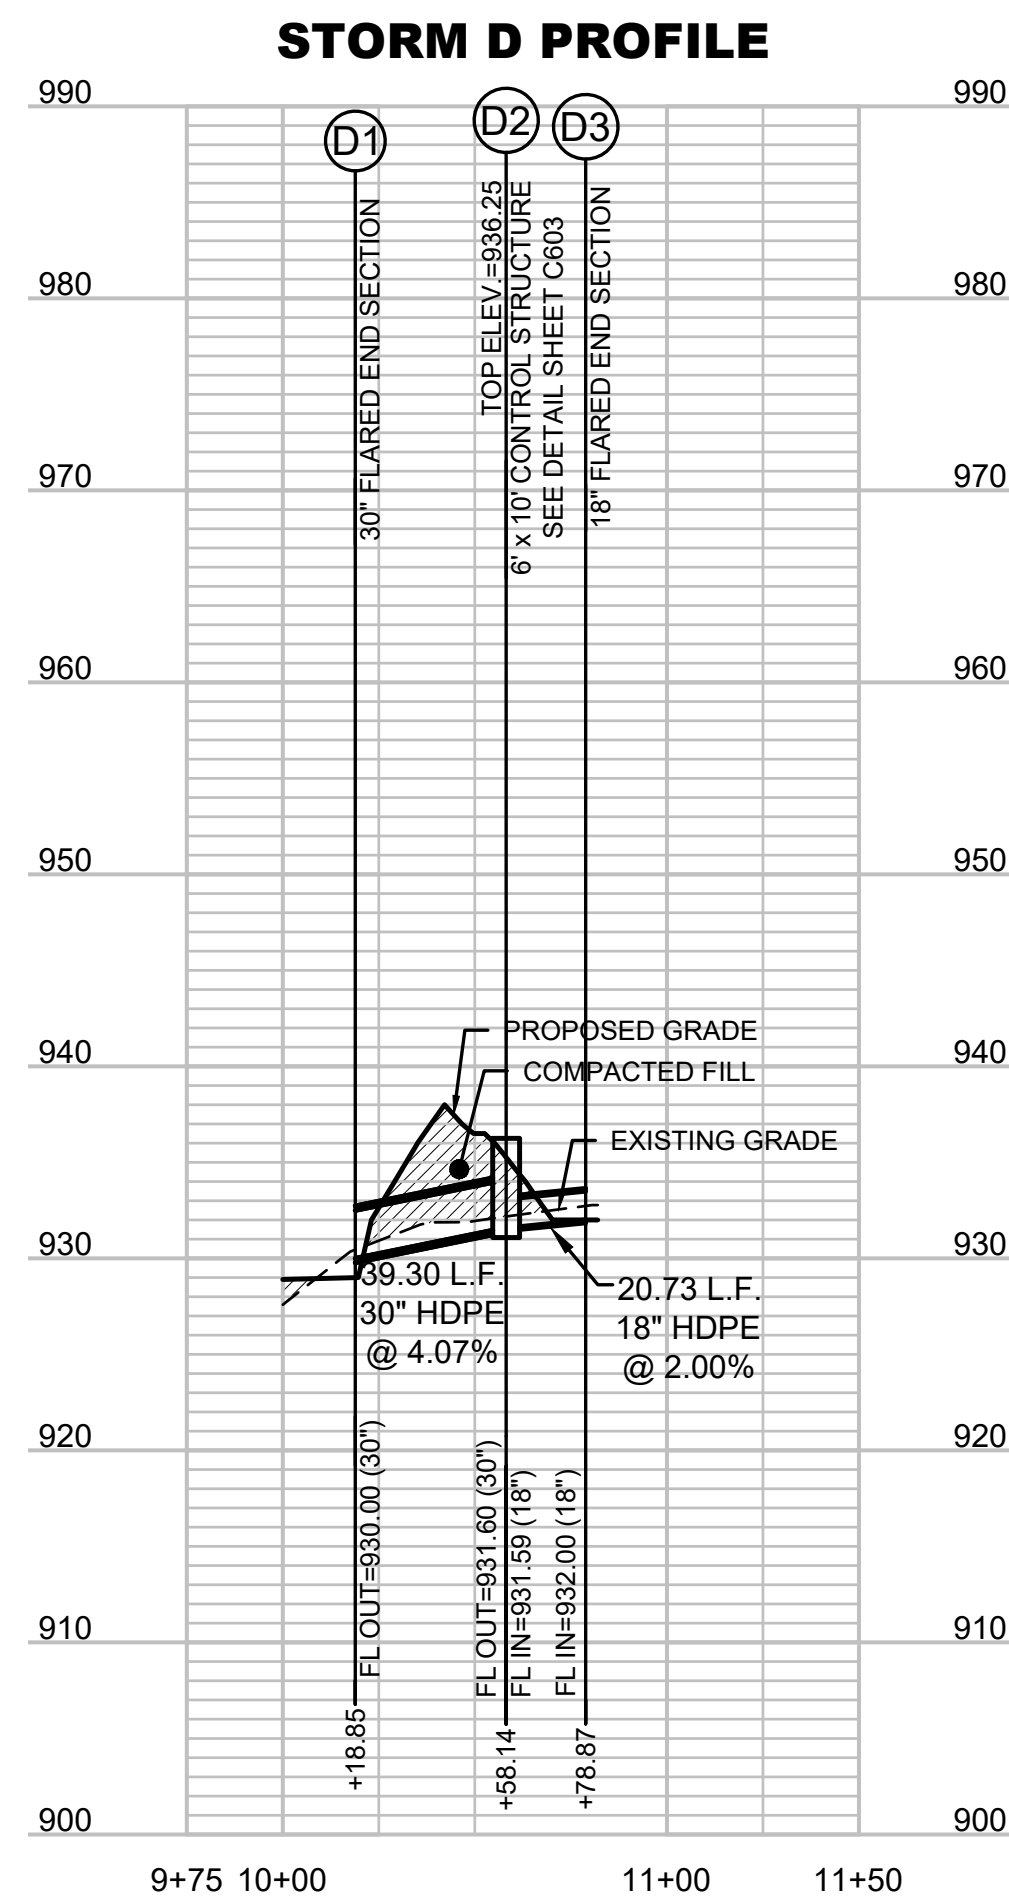
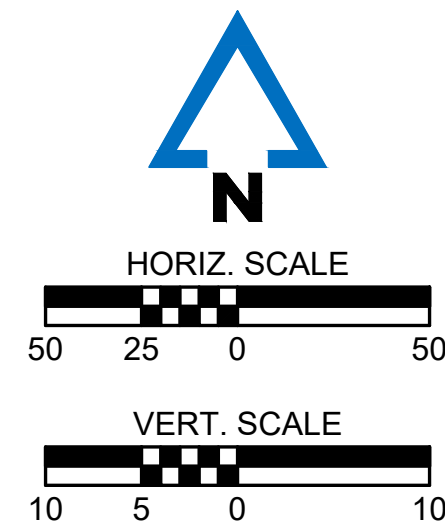
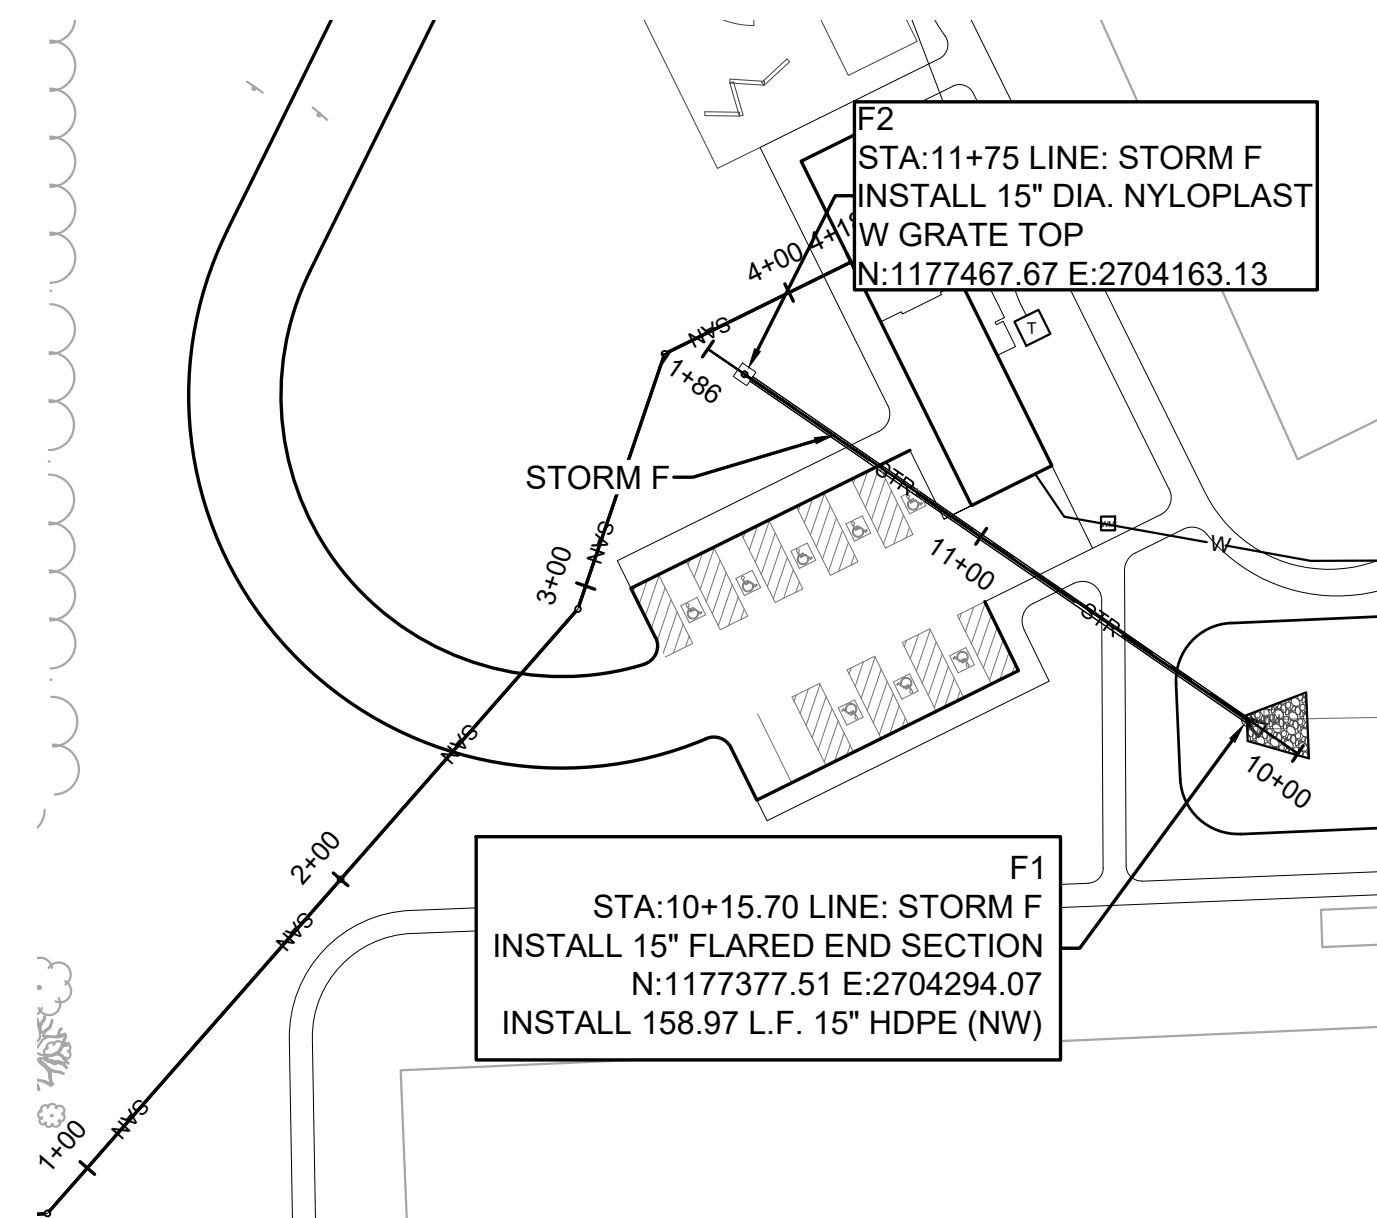
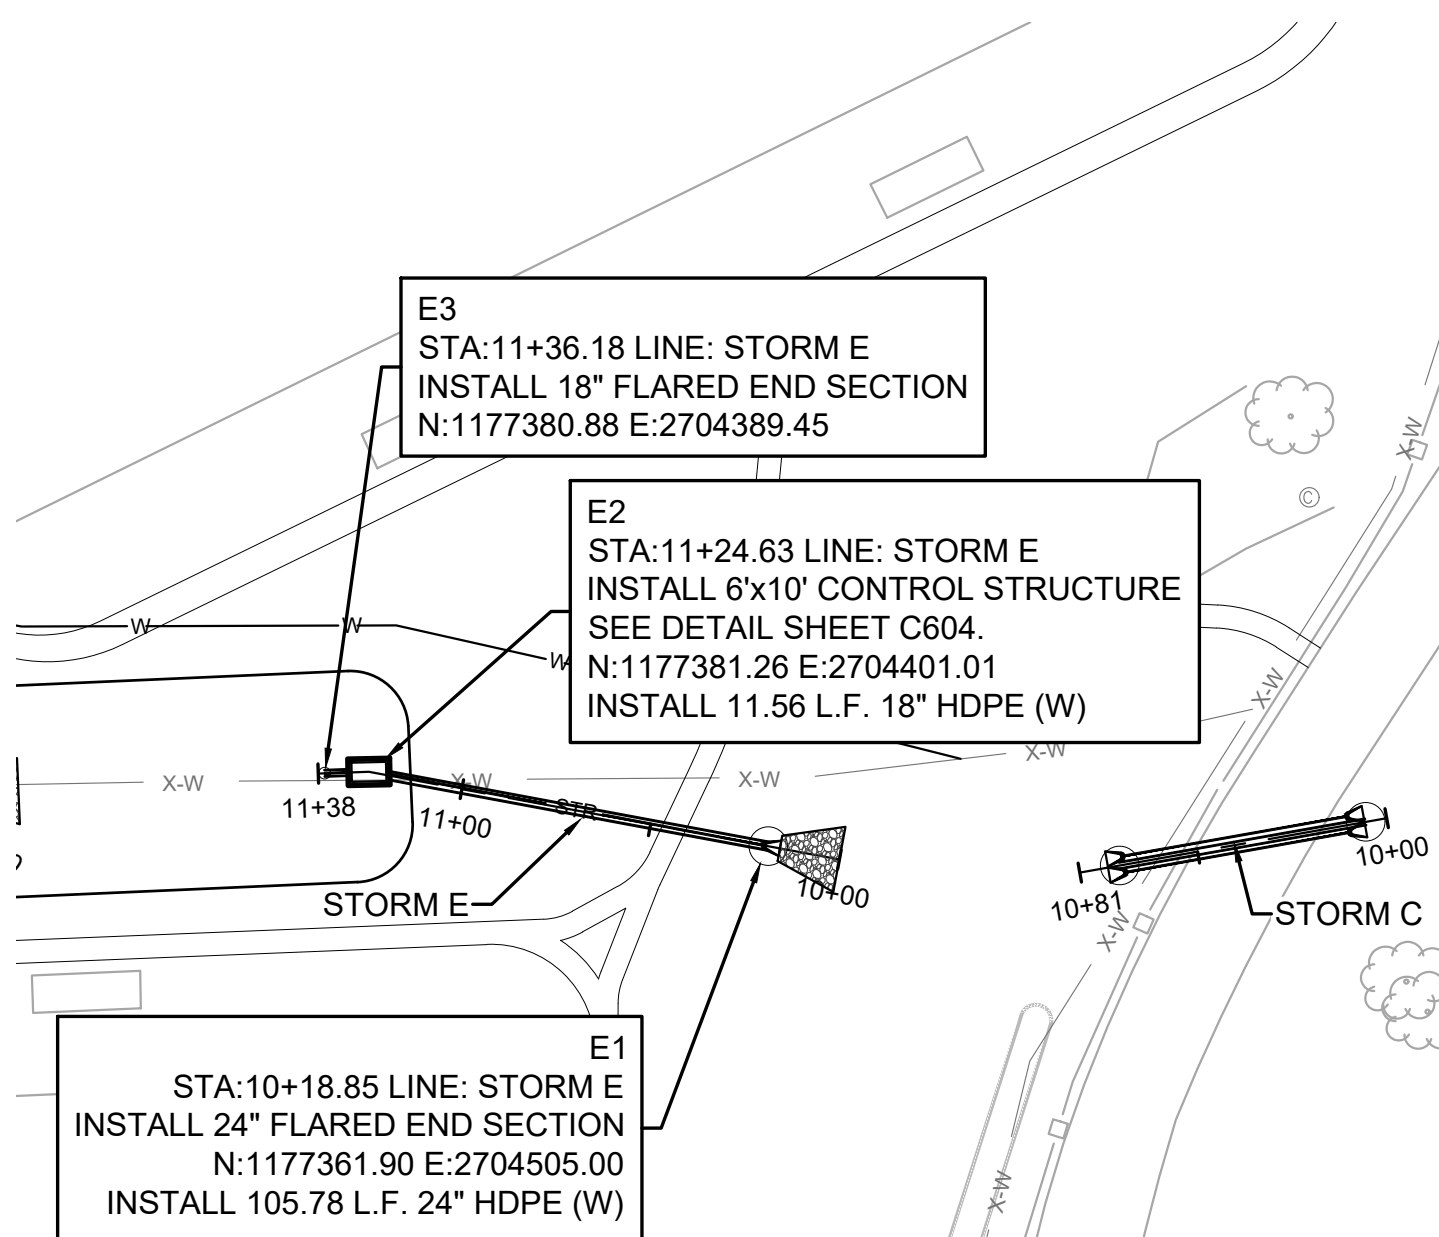
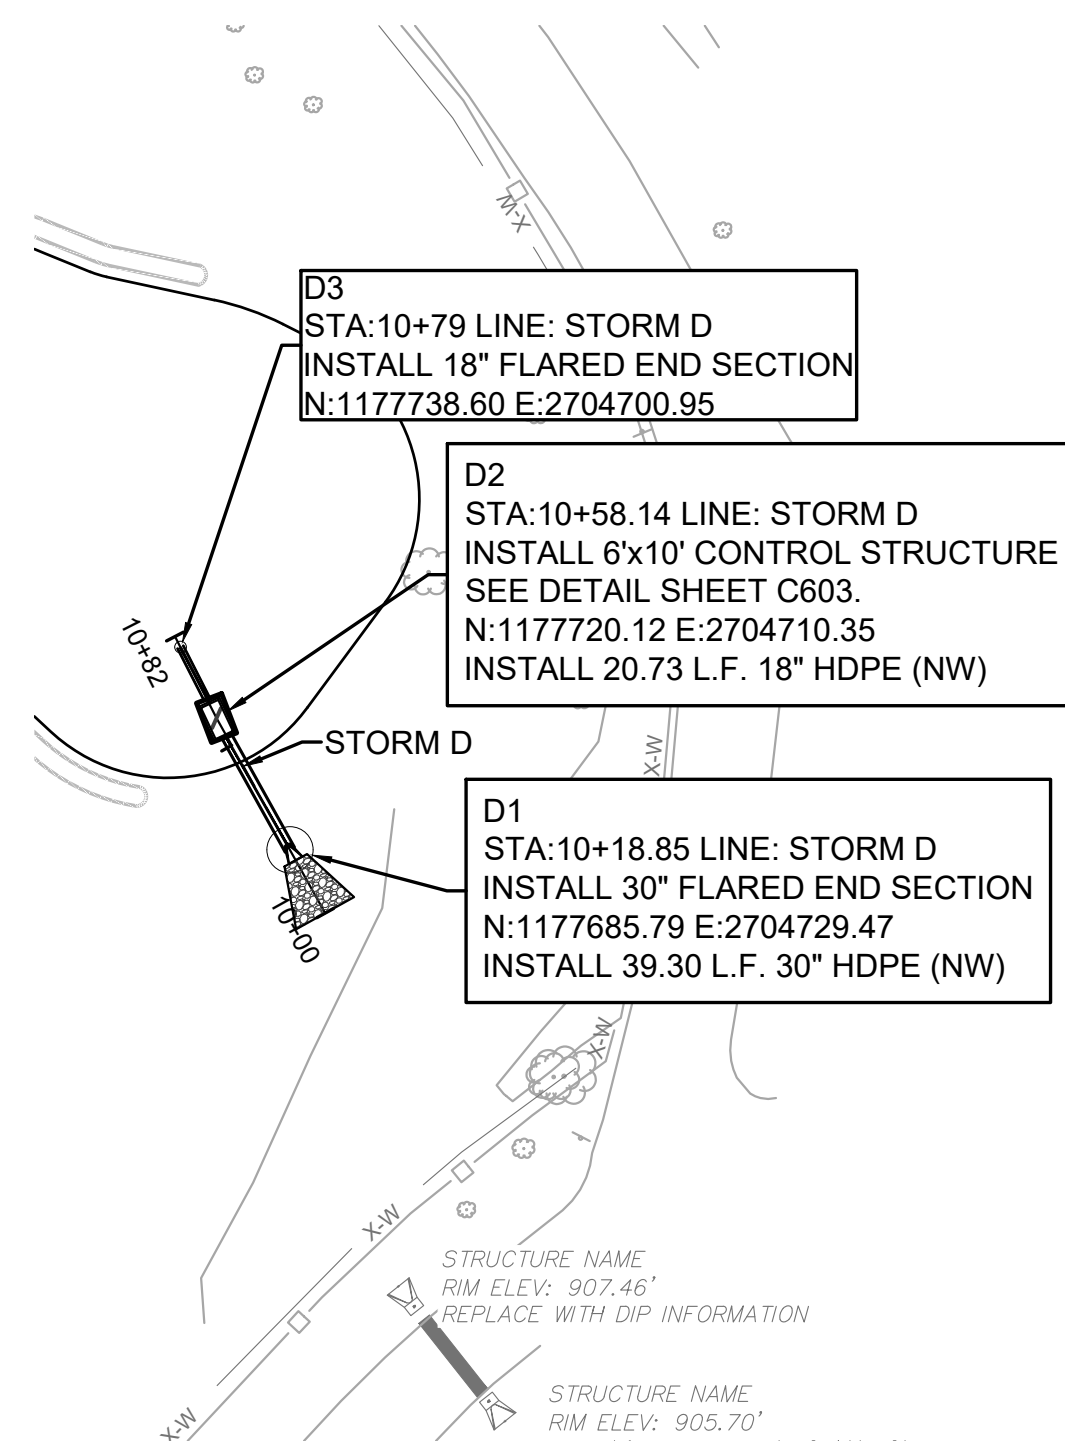
PLATTE RIDGE PARK
FOOTBALL COMPLEX IMPROVEMENTS
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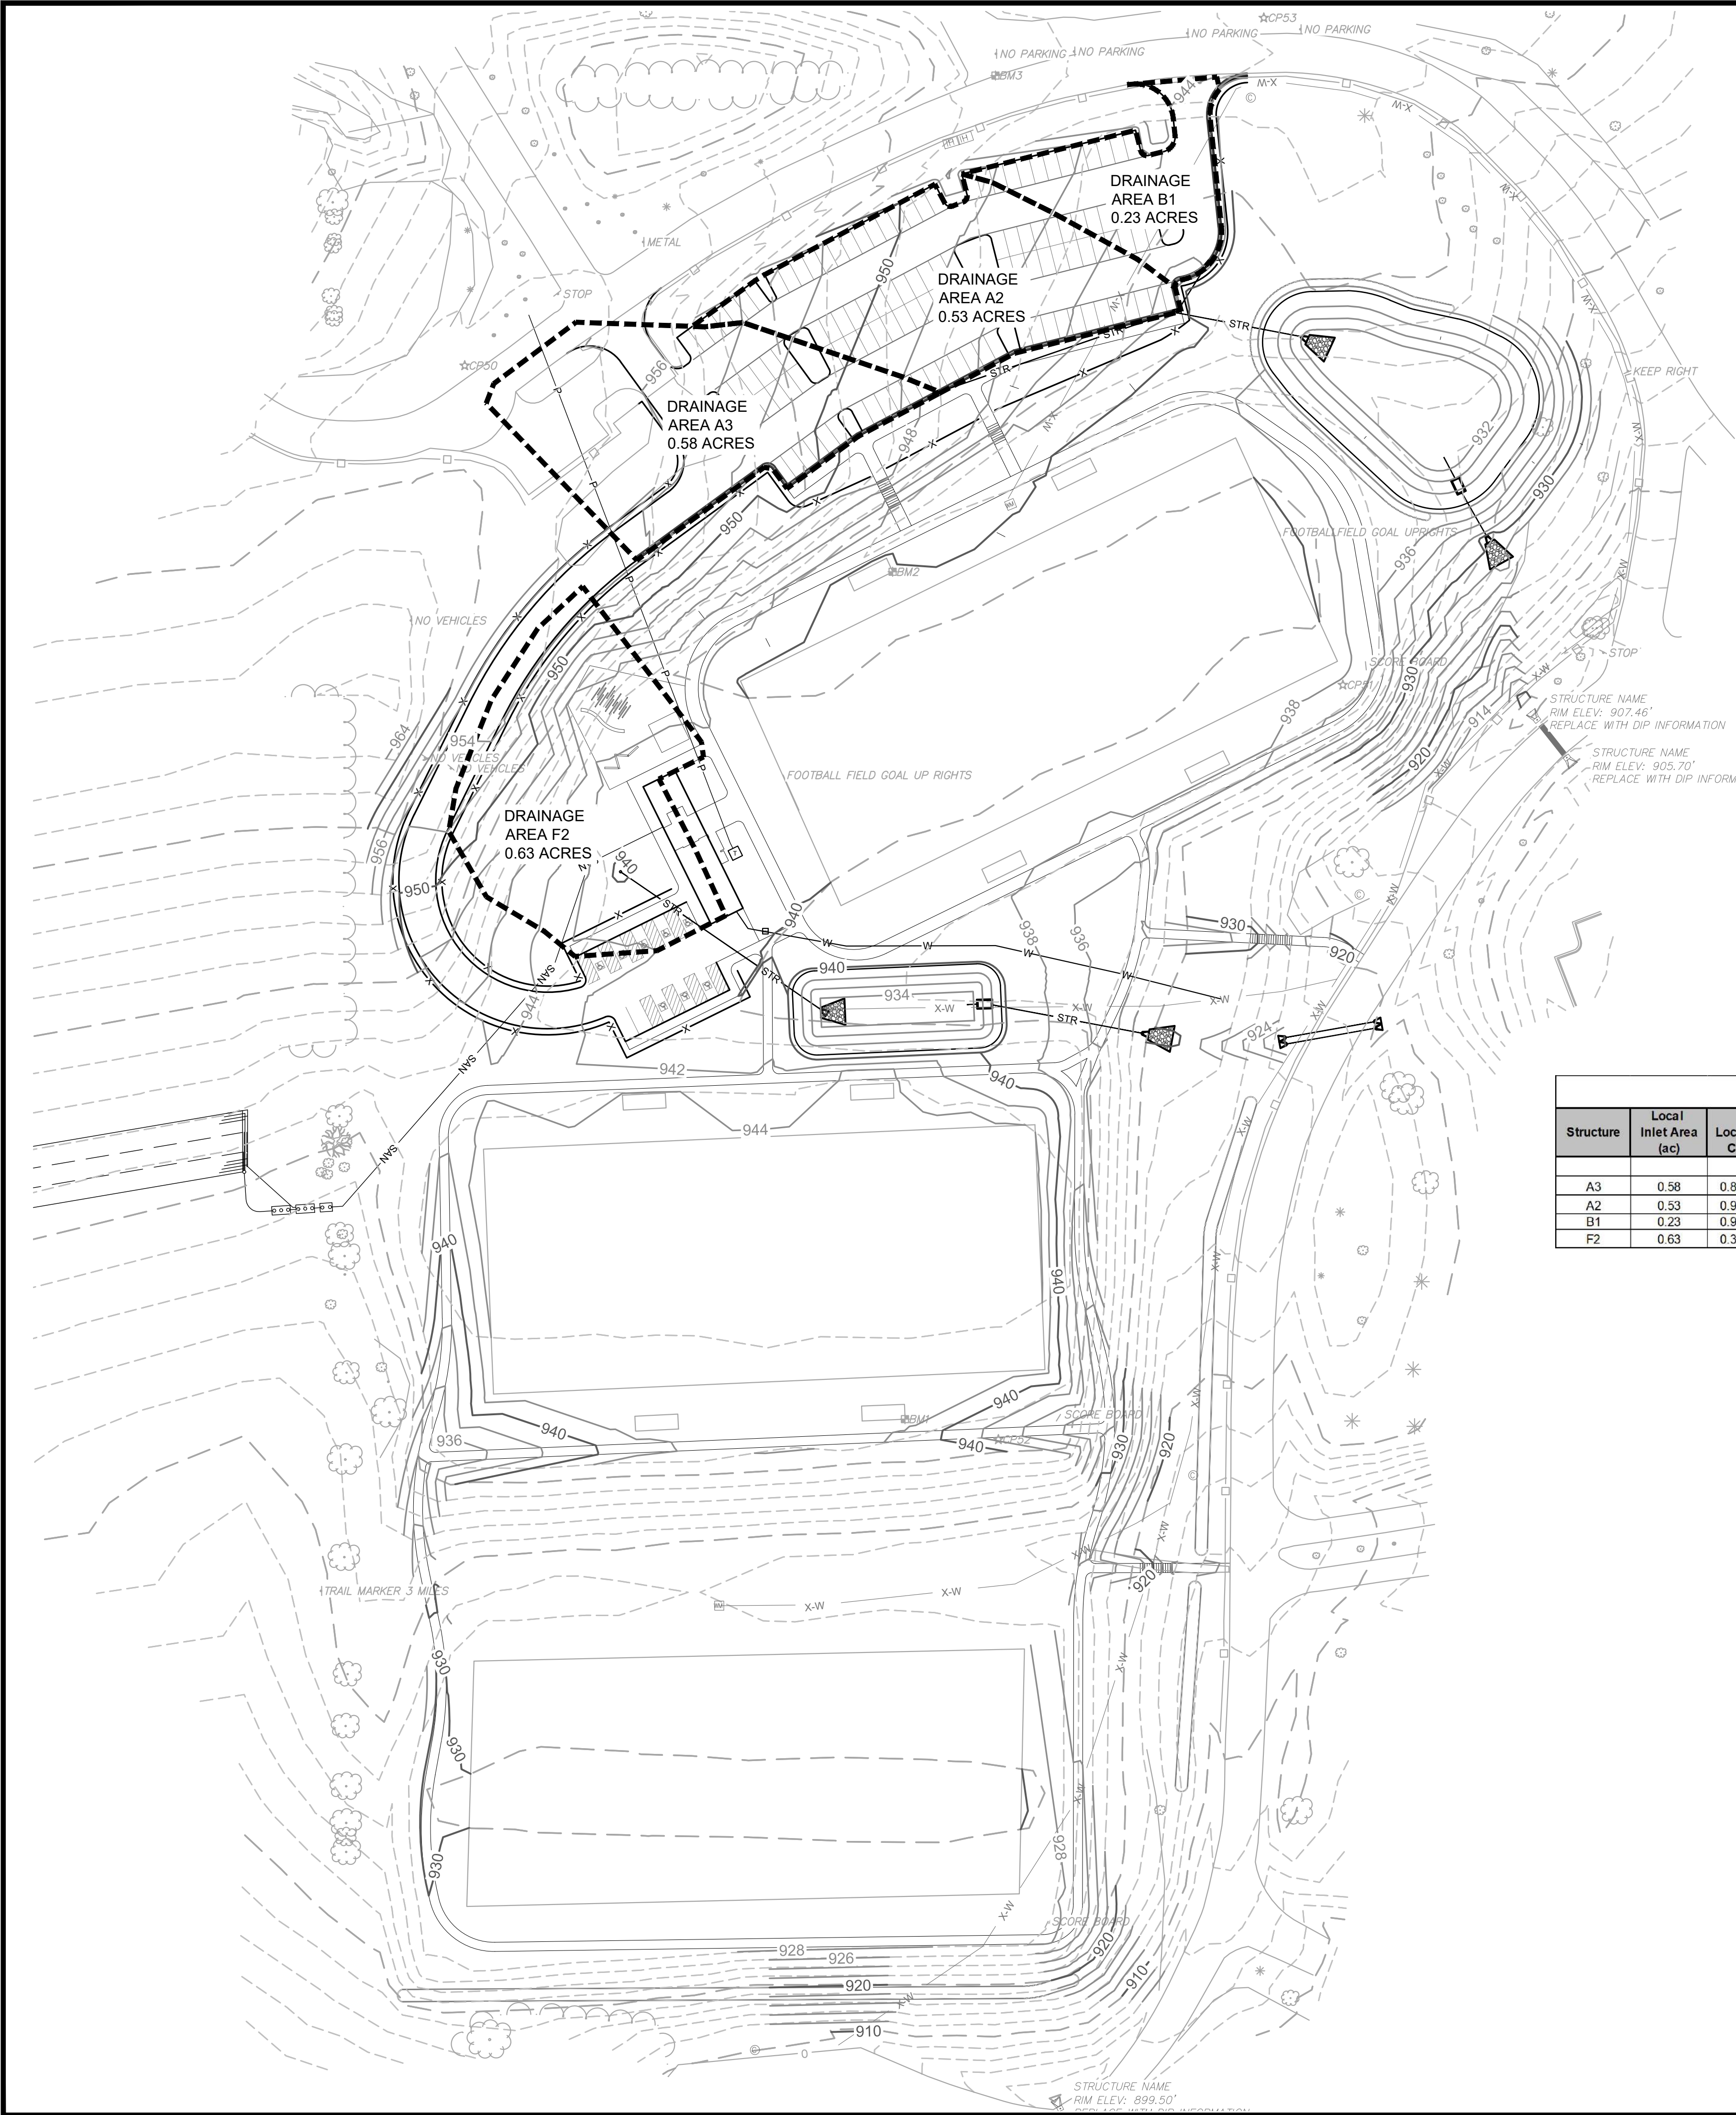
STORM PLAN AND PROFILES

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DRAWING NO.

C402





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DRAINAGE PLAN

DRAWING NO.

C403

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HYDROLOGY



Structure	Local Inlet Area (ac)	Local C	Local CA (ac)	System CA (ac)	Local Tc (min)	System Tc (min)	Local Intensity 10 yr (in/hr)	Local Intensity 100yr (in/hr)	System Intensity 10 yr (in/hr)	System Intensity 100 yr (in/hr)	Antecedent Precip Factor (10 yr)	Antecedent Precip Factor (100 yr)	Local Flow 10 Yr (cfs)	System Flow 10 Yr (cfs)	Local Flow 100 Yr (cfs)	System Flow 100 Yr (cfs)
A3	0.58	0.81	0.47	0.47	5.00	5.00	7.35	10.32	7.35	10.32	1.00	1.25	3.45	3.45	6.06	6.06
A2	0.53	0.90	0.48	1.15	5.00	5.00	7.35	10.32	7.35	10.32	1.00	1.25	3.51	8.48	6.15	14.89
B1	0.23	0.90	0.21	0.21	5.00	5.00	7.35	10.32	7.35	10.32	1.00	1.25	1.52	1.52	2.67	2.67
F2	0.63	0.36	0.23	0.23	5.00	5.00	7.35	10.32	7.35	10.32	1.00	1.25	1.67	1.67	2.93	2.93



PIPE DESIGN

Pipe Name	U/S Structure	D/S Structure	U/S Invert	D/S Invert	Pipe Length (ft)	Pipe Slope (ft/ft)	Pipe Diameter (in)	Manning's n	Inlet Capacity (cfs)	Full Capacity (cfs)	System Flow 10 Yr (cfs)	System Flow 100 Yr (cfs)	Average Velocity (ft/s)
LINE A3	A3	A2	942.50	937.50	165.56	0.0302	15	0.013	7.63	11.25	3.45	6.06	9.17
LINE A2	A2	A1	935.00	932.00	85.76	0.0350	18	0.013	12.03	19.69	8.48	14.89	11.15
LINE B1	B1	A2	937.00	936.00	37.79	0.0265	15	0.013	7.63	10.53	1.52	2.67	8.59
LINE C2	C2	C1	919.50	919.00	65.08	0.0077	18	0.013	24.06	18.45	11.98	19.05	5.22
LINE F1	F2	F1	937.00	934.00	158.97	0.0189	15	0.013	7.63	8.89	1.67	2.93	7.25


*LINE C2 CONSISTS OF TWO (2) - 18" PIPES; CALCULATION REFLECTS BOTH PIPES IN USE

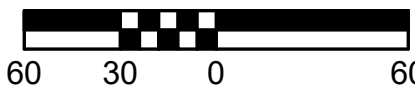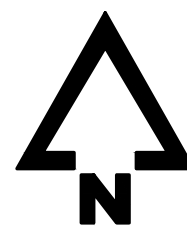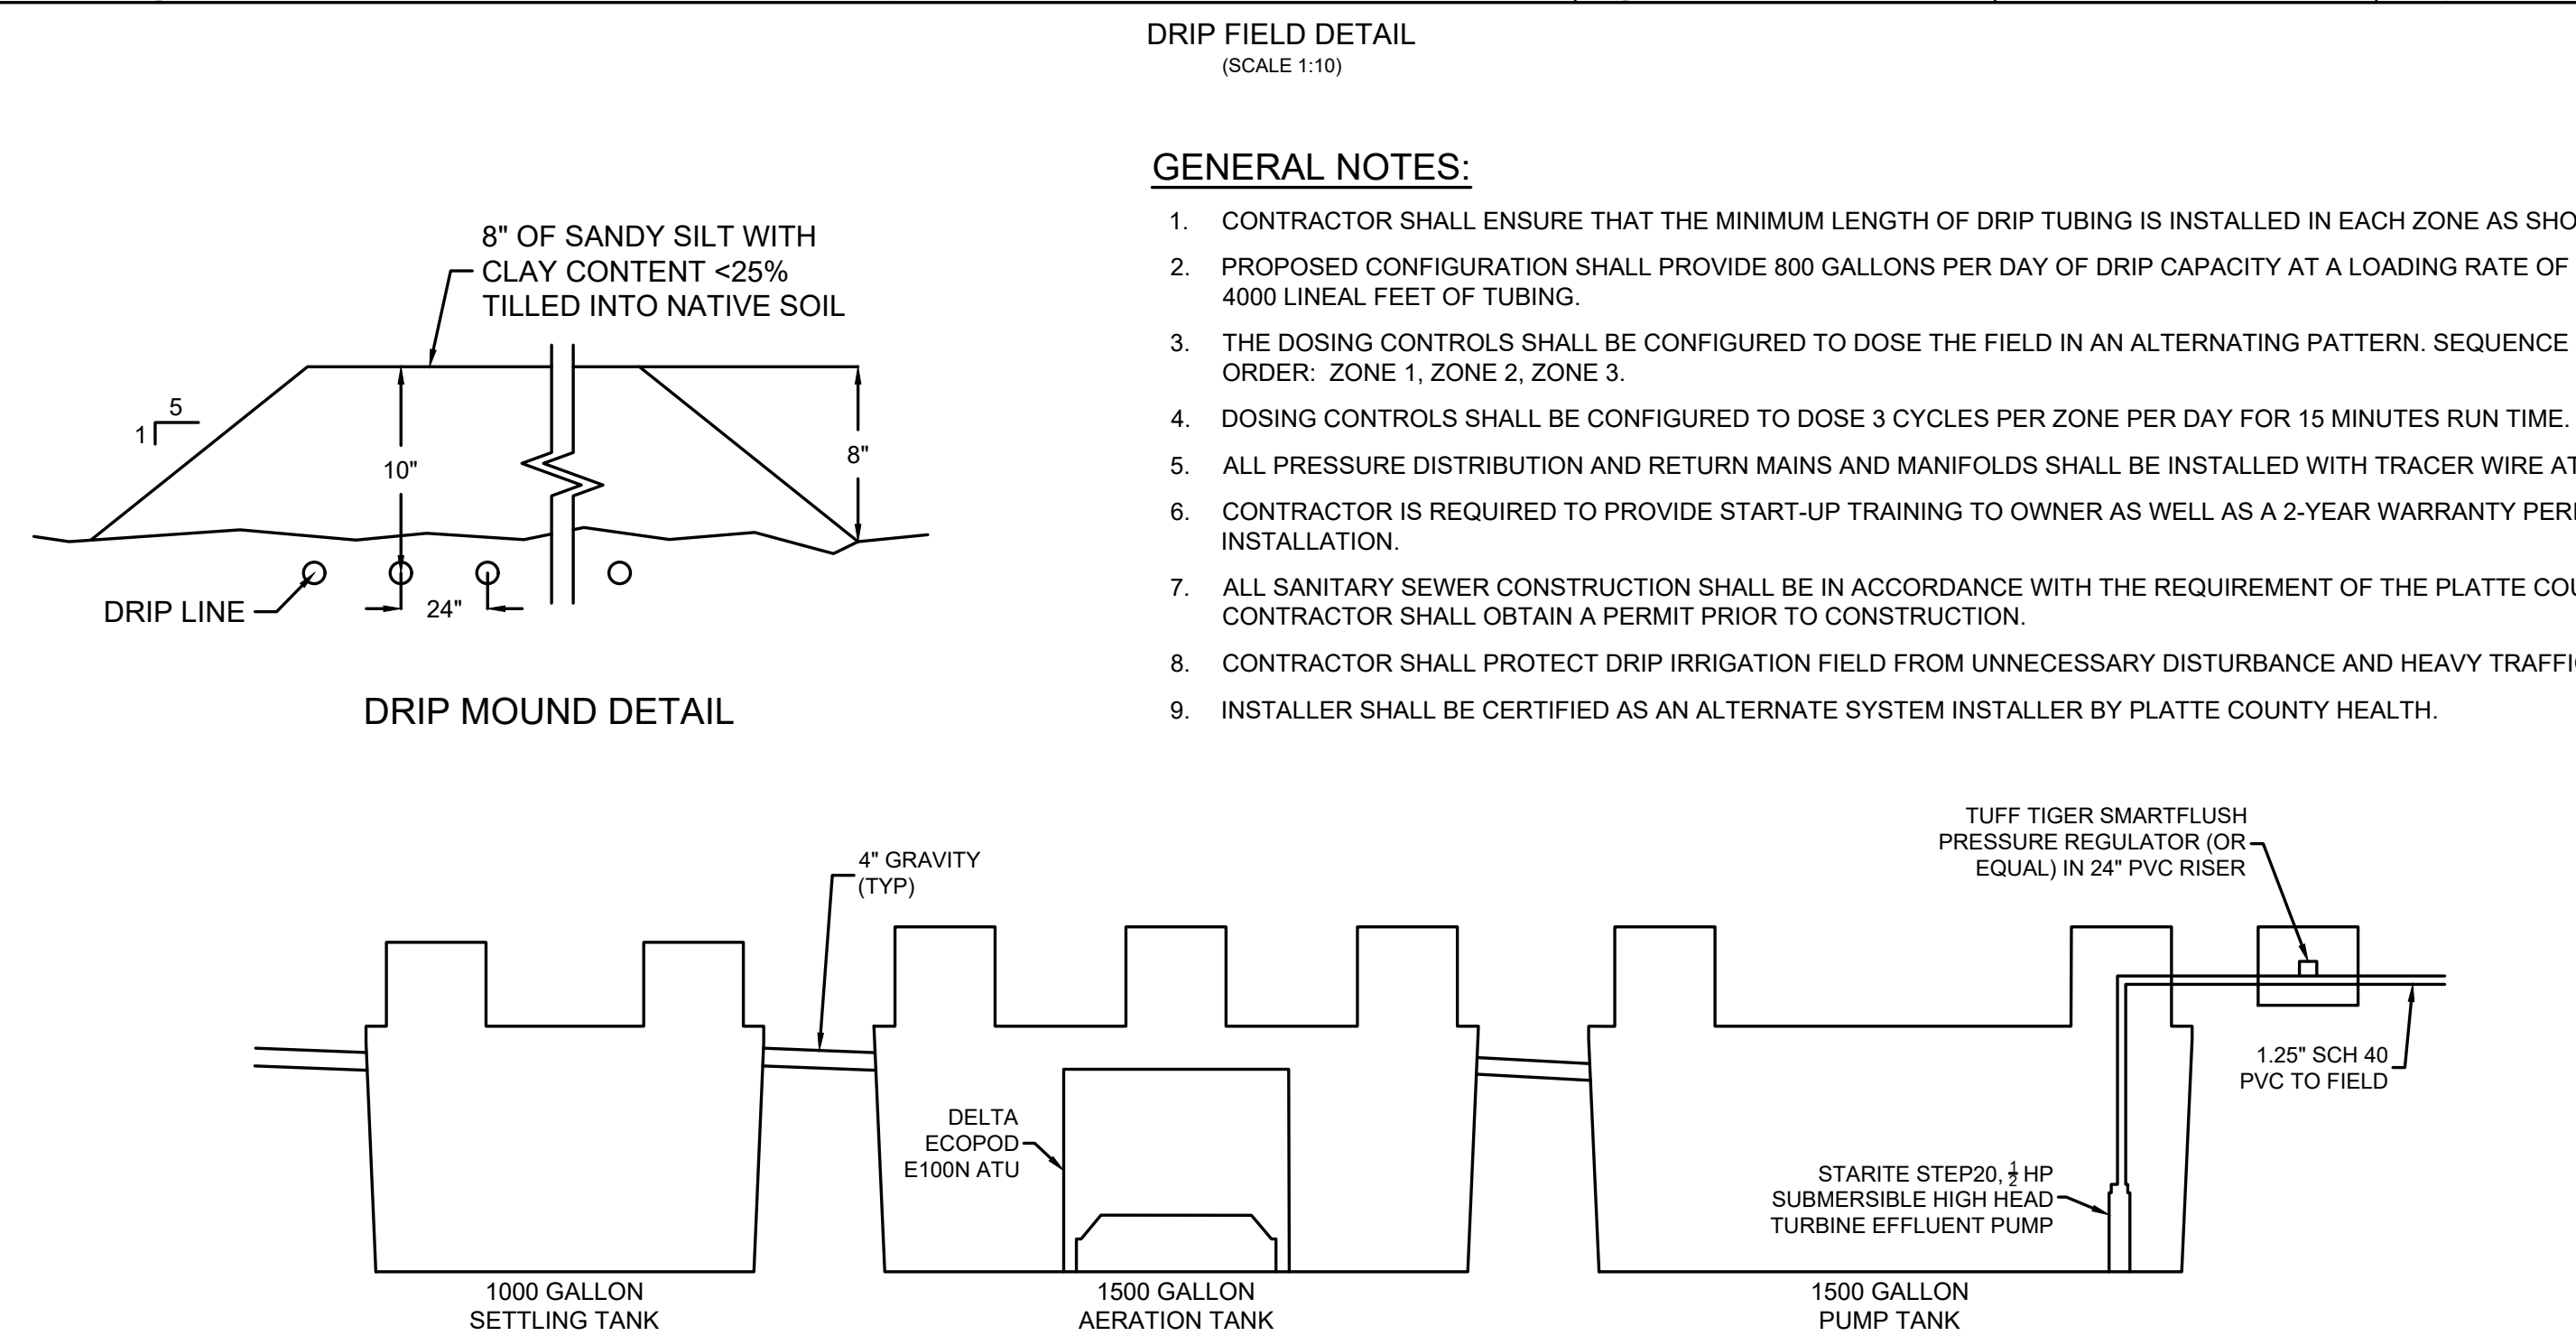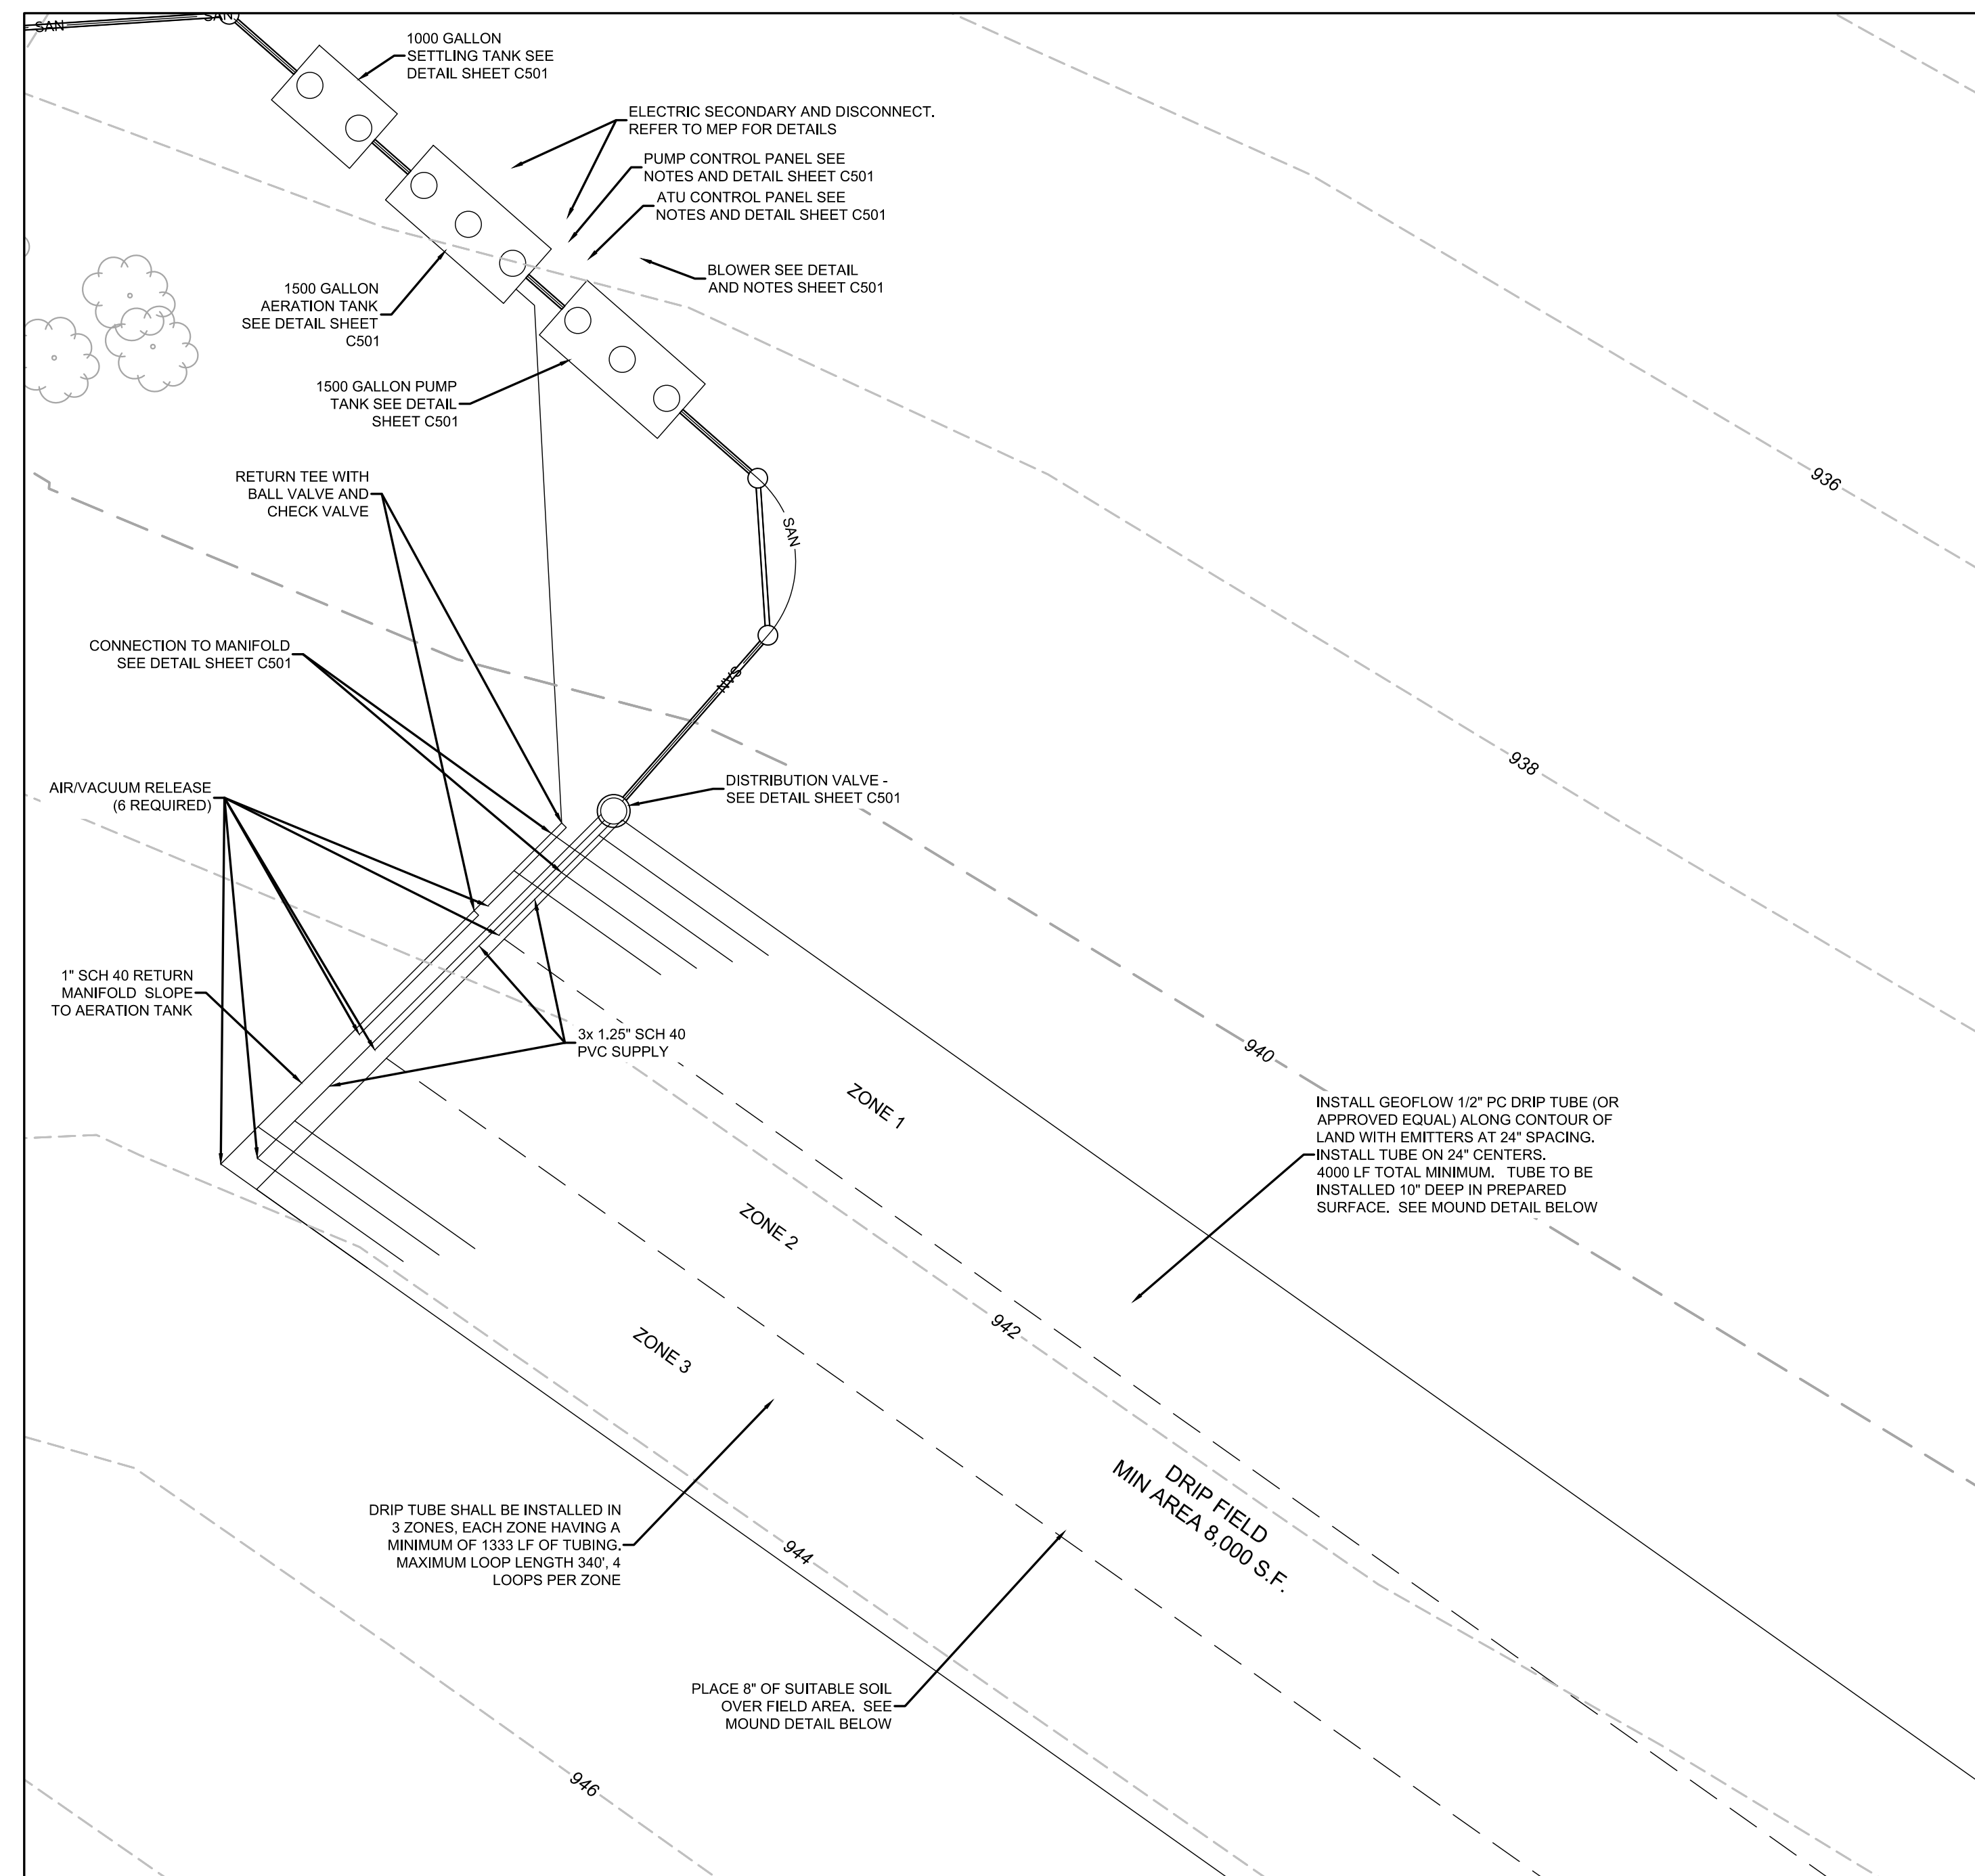NOTE:
SEE SHEET C001 FOR GENERAL NOTES.







1. CONTRACTOR SHALL ENSURE THAT THE MINIMUM LENGTH OF DRIP TUBING IS INSTALLED IN EACH ZONE AS SHOWN BY THE ZONE PLAN.
2. PROPOSED CONFIGURATION SHALL PROVIDE 800 GALLONS PER DAY OF DRIP CAPACITY AT A LOADING RATE OF 0.10 GPD PER SQUARE FEET OR 4000 LINEAL FEET OF TUBING.
3. THE DOSING CONTROLS SHALL BE CONFIGURED TO DOSE THE FIELD IN AN ALTERNATING PATTERN. SEQUENCE DOSING IN THE FOLLOWING ORDER: ZONE 1, ZONE 2, ZONE 3.
4. DOSING CONTROLS SHALL BE CONFIGURED TO DOSE 3 CYCLES PER ZONE PER DAY FOR 15 MINUTES RUN TIME.
5. ALL PRESSURE DISTRIBUTION AND RETURN MAINS AND MANIFOLDS SHALL BE INSTALLED WITH TRACER WIRE AT A MINIMUM DEPTH OF 18".
6. CONTRACTOR IS REQUIRED TO PROVIDE START-UP TRAINING TO OWNER AS WELL AS A 2-YEAR WARRANTY PERIOD FOR ALL EQUIPMENT AND INSTALLATION.
7. ALL SANITARY SEWER CONSTRUCTION SHALL BE IN ACCORDANCE WITH THE REQUIREMENT OF THE PLATTE COUNTY HEALTH DEPARTMENT. CONTRACTOR SHALL OBTAIN A PERMIT PRIOR TO CONSTRUCTION.
8. CONTRACTOR SHALL PROTECT DRIP IRRIGATION FIELD FROM UNNECESSARY DISTURBANCE AND HEAVY TRAFFIC.
9. INSTALLER SHALL BE CERTIFIED AS AN ALTERNATE SYSTEM INSTALLER BY PLATTE COUNTY HEALTH.

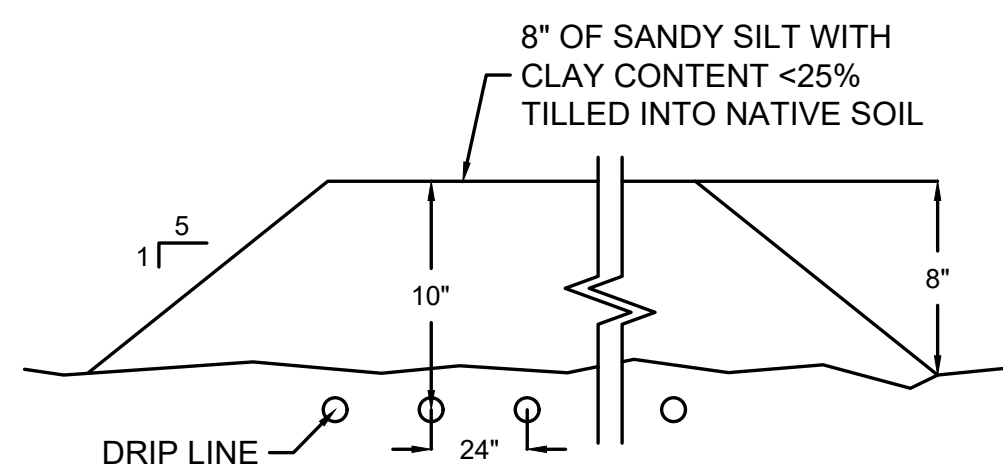

DRIP MOUND DETAIL

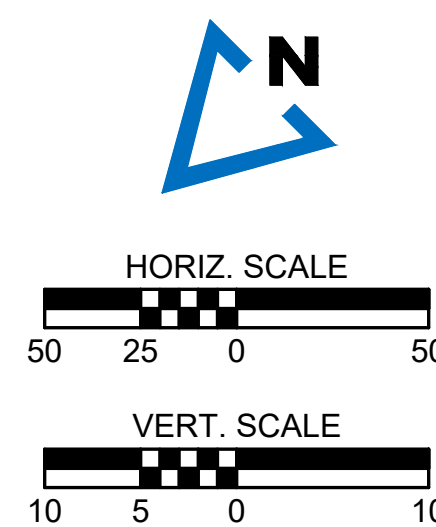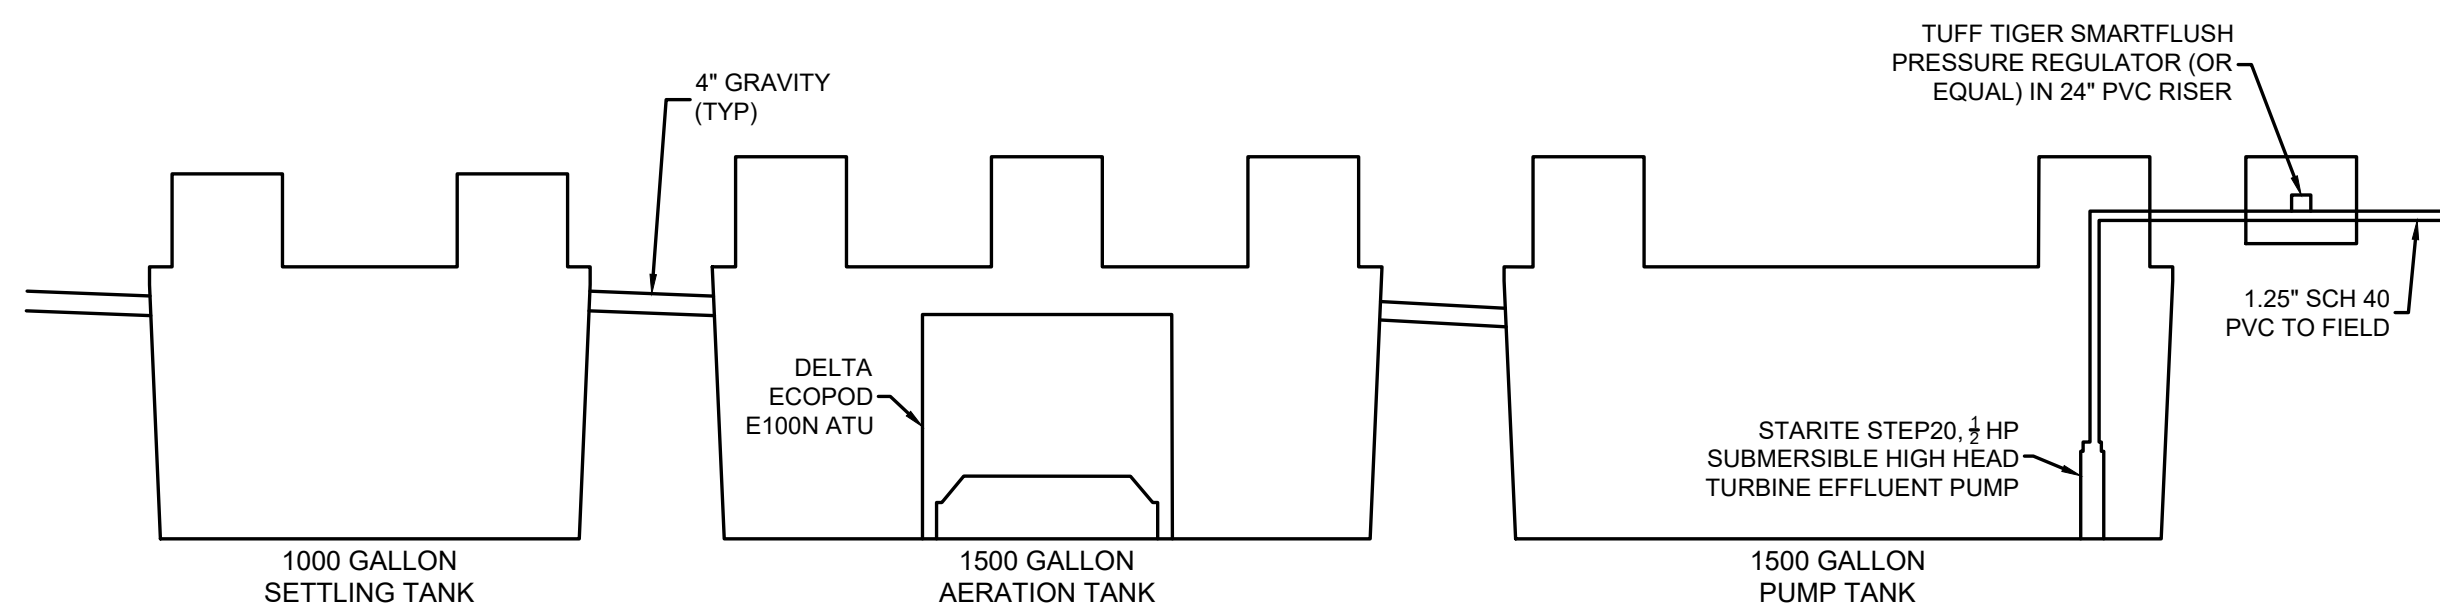

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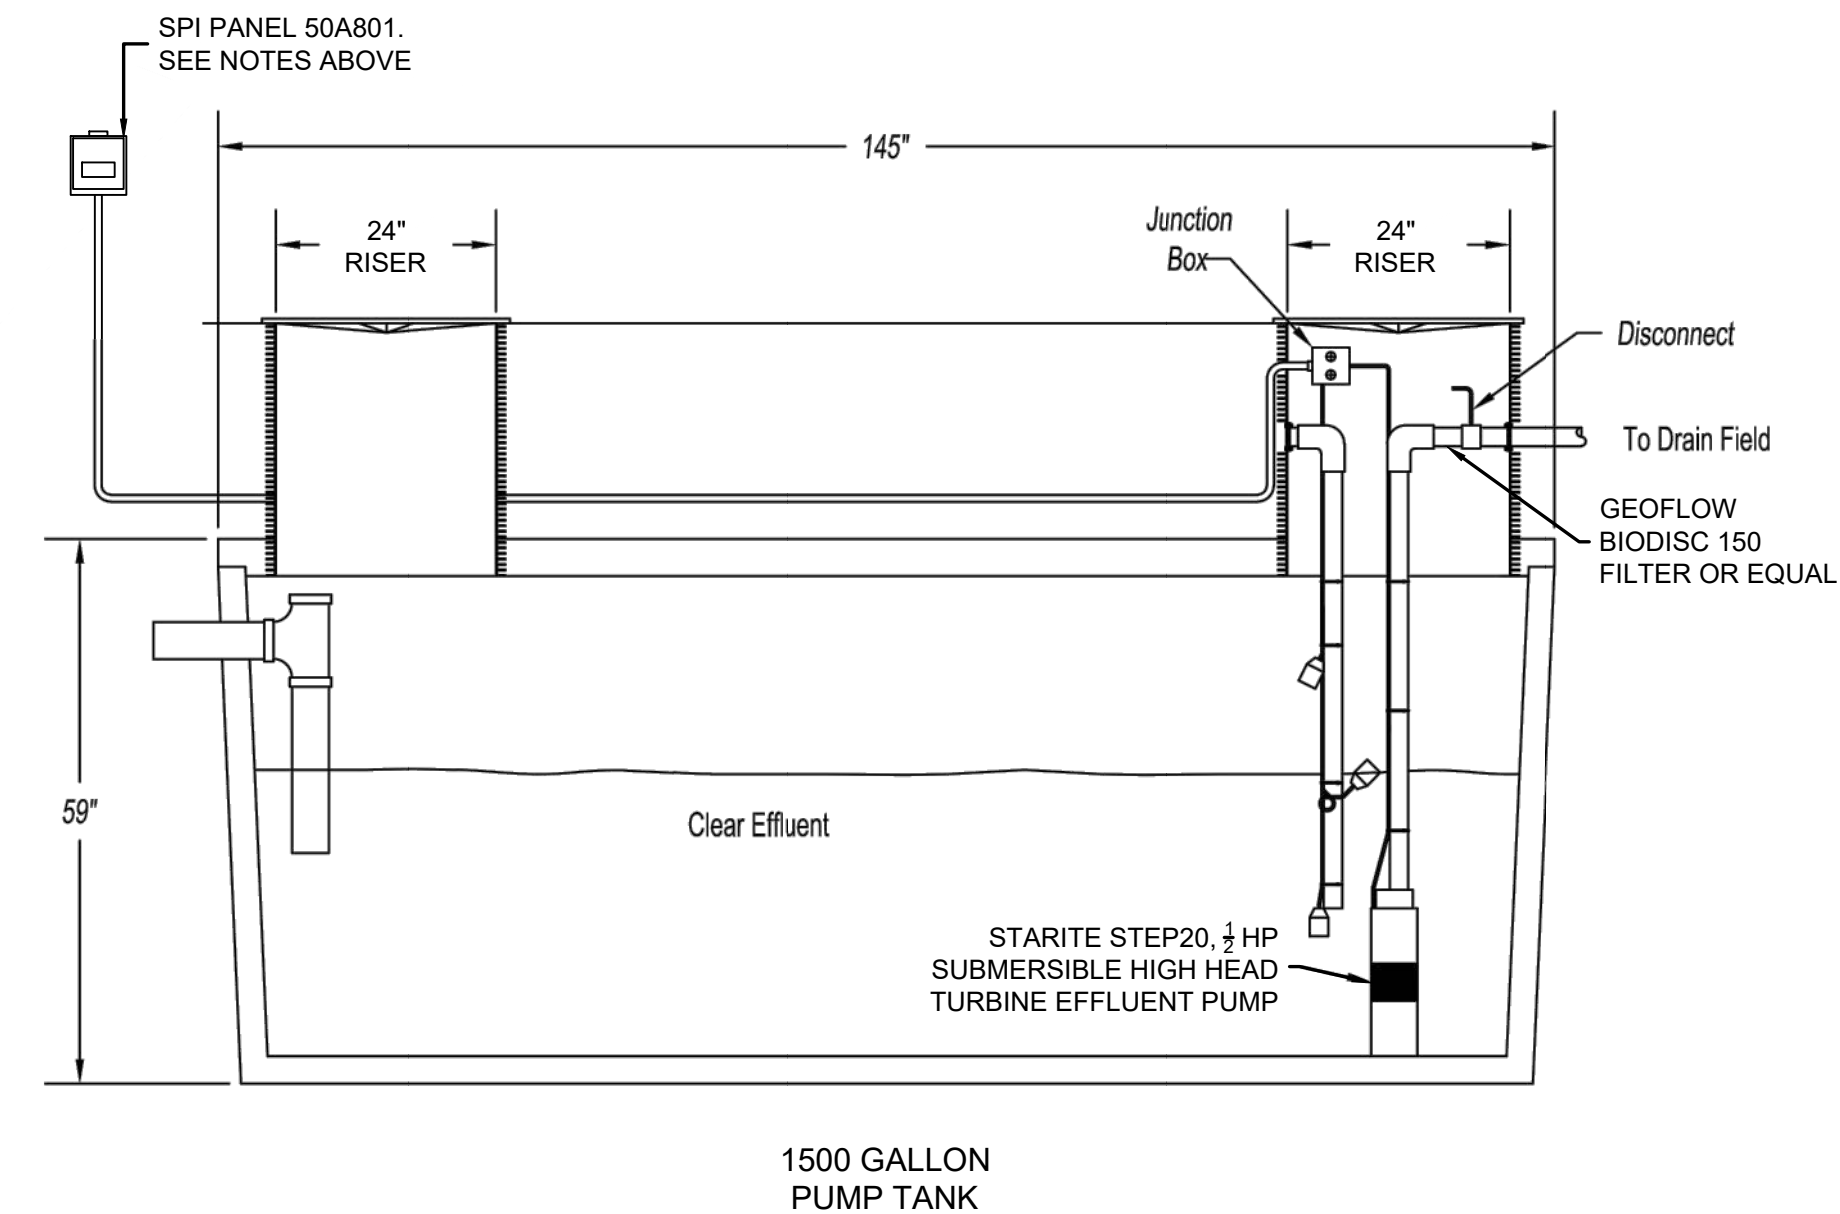
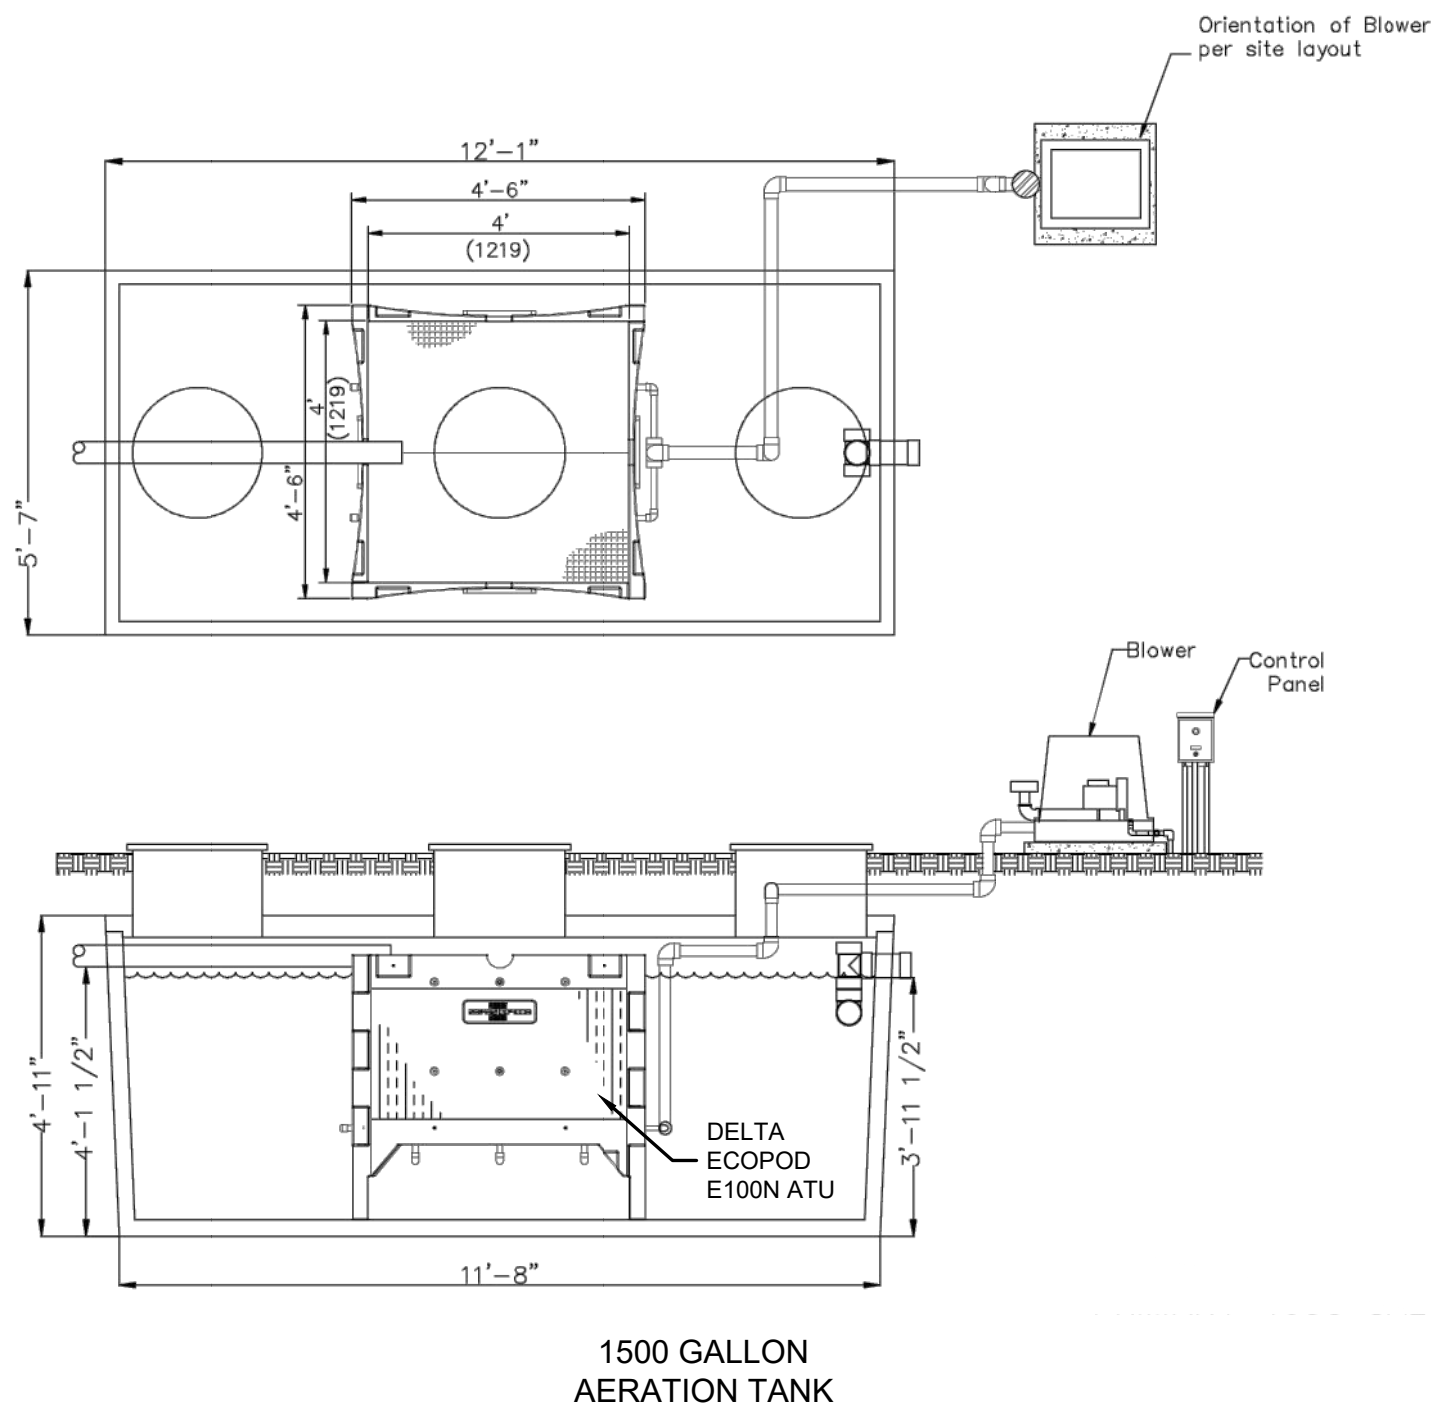
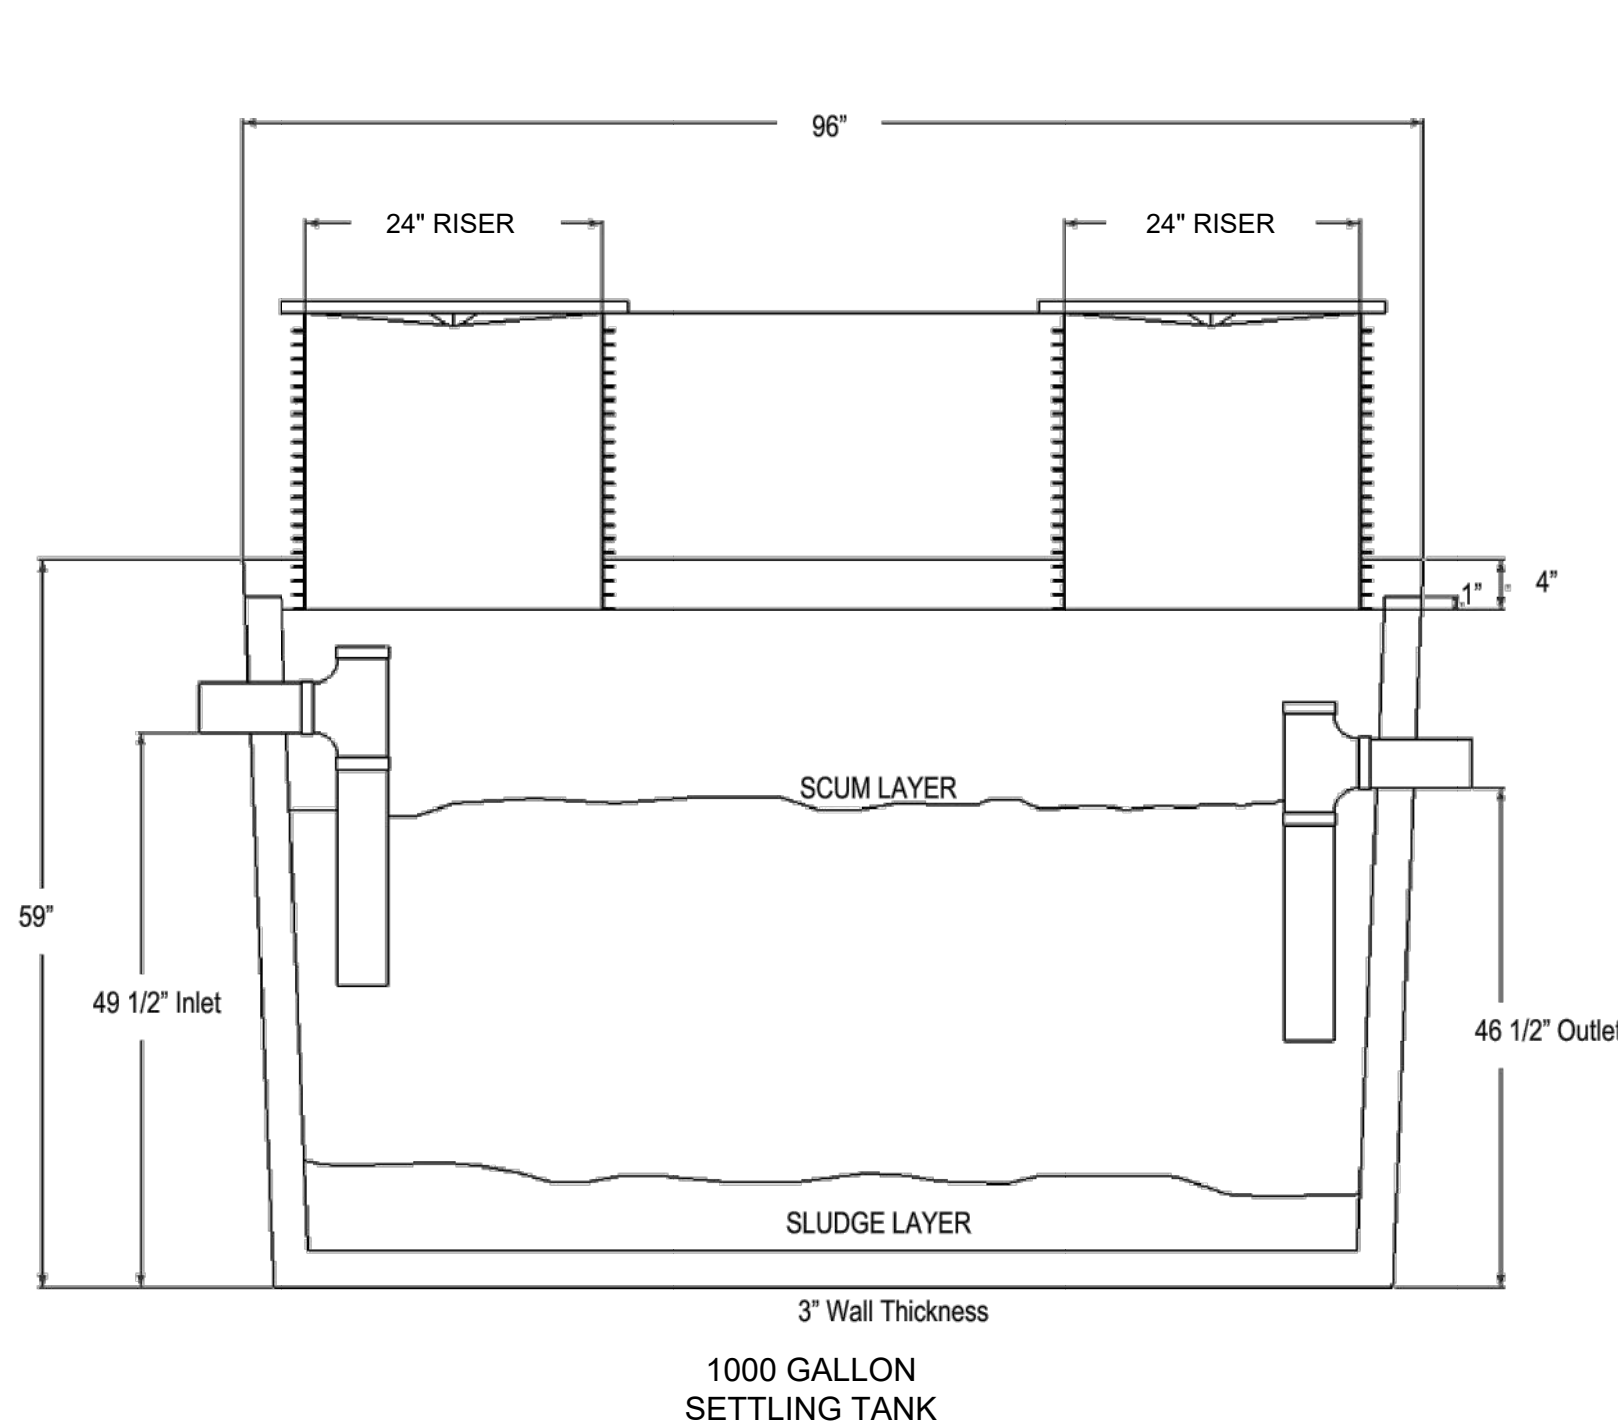
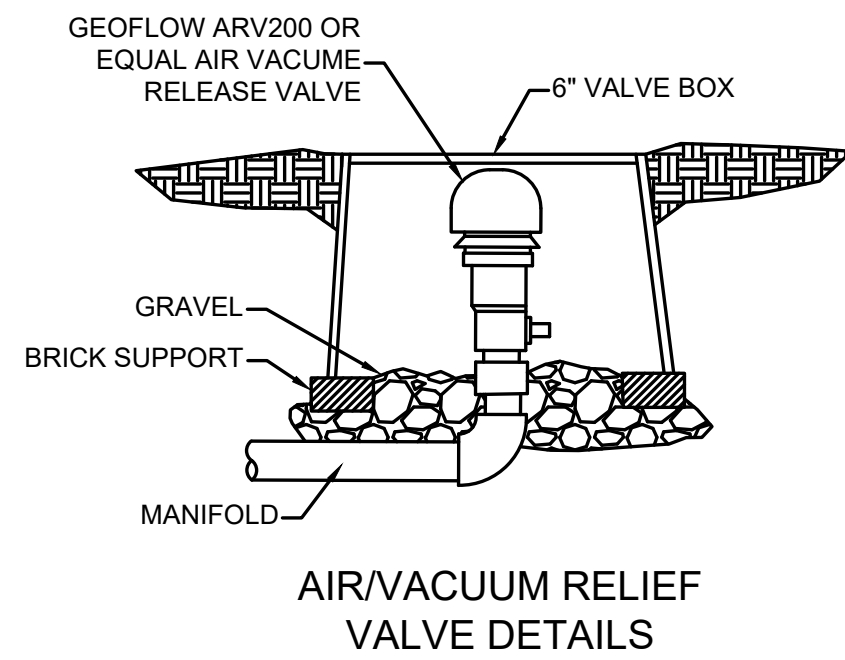
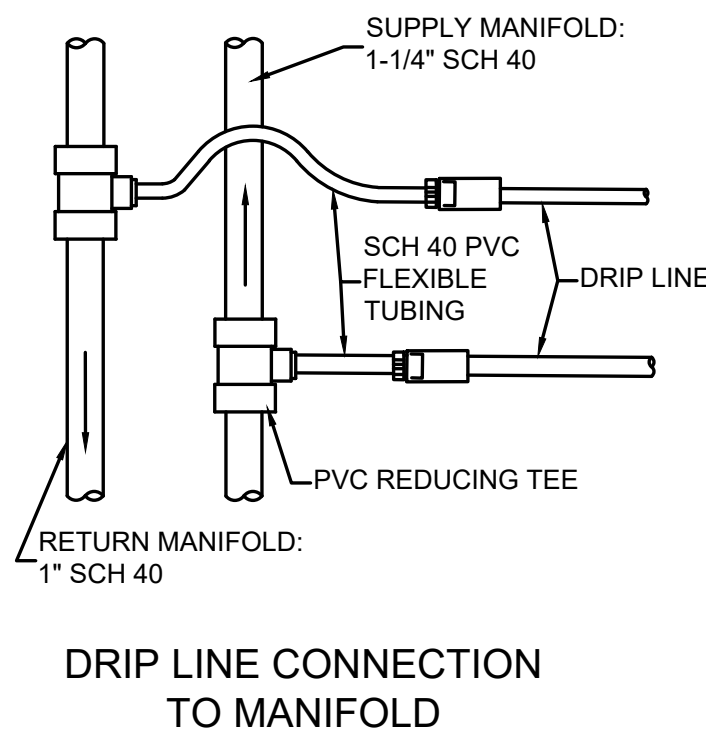
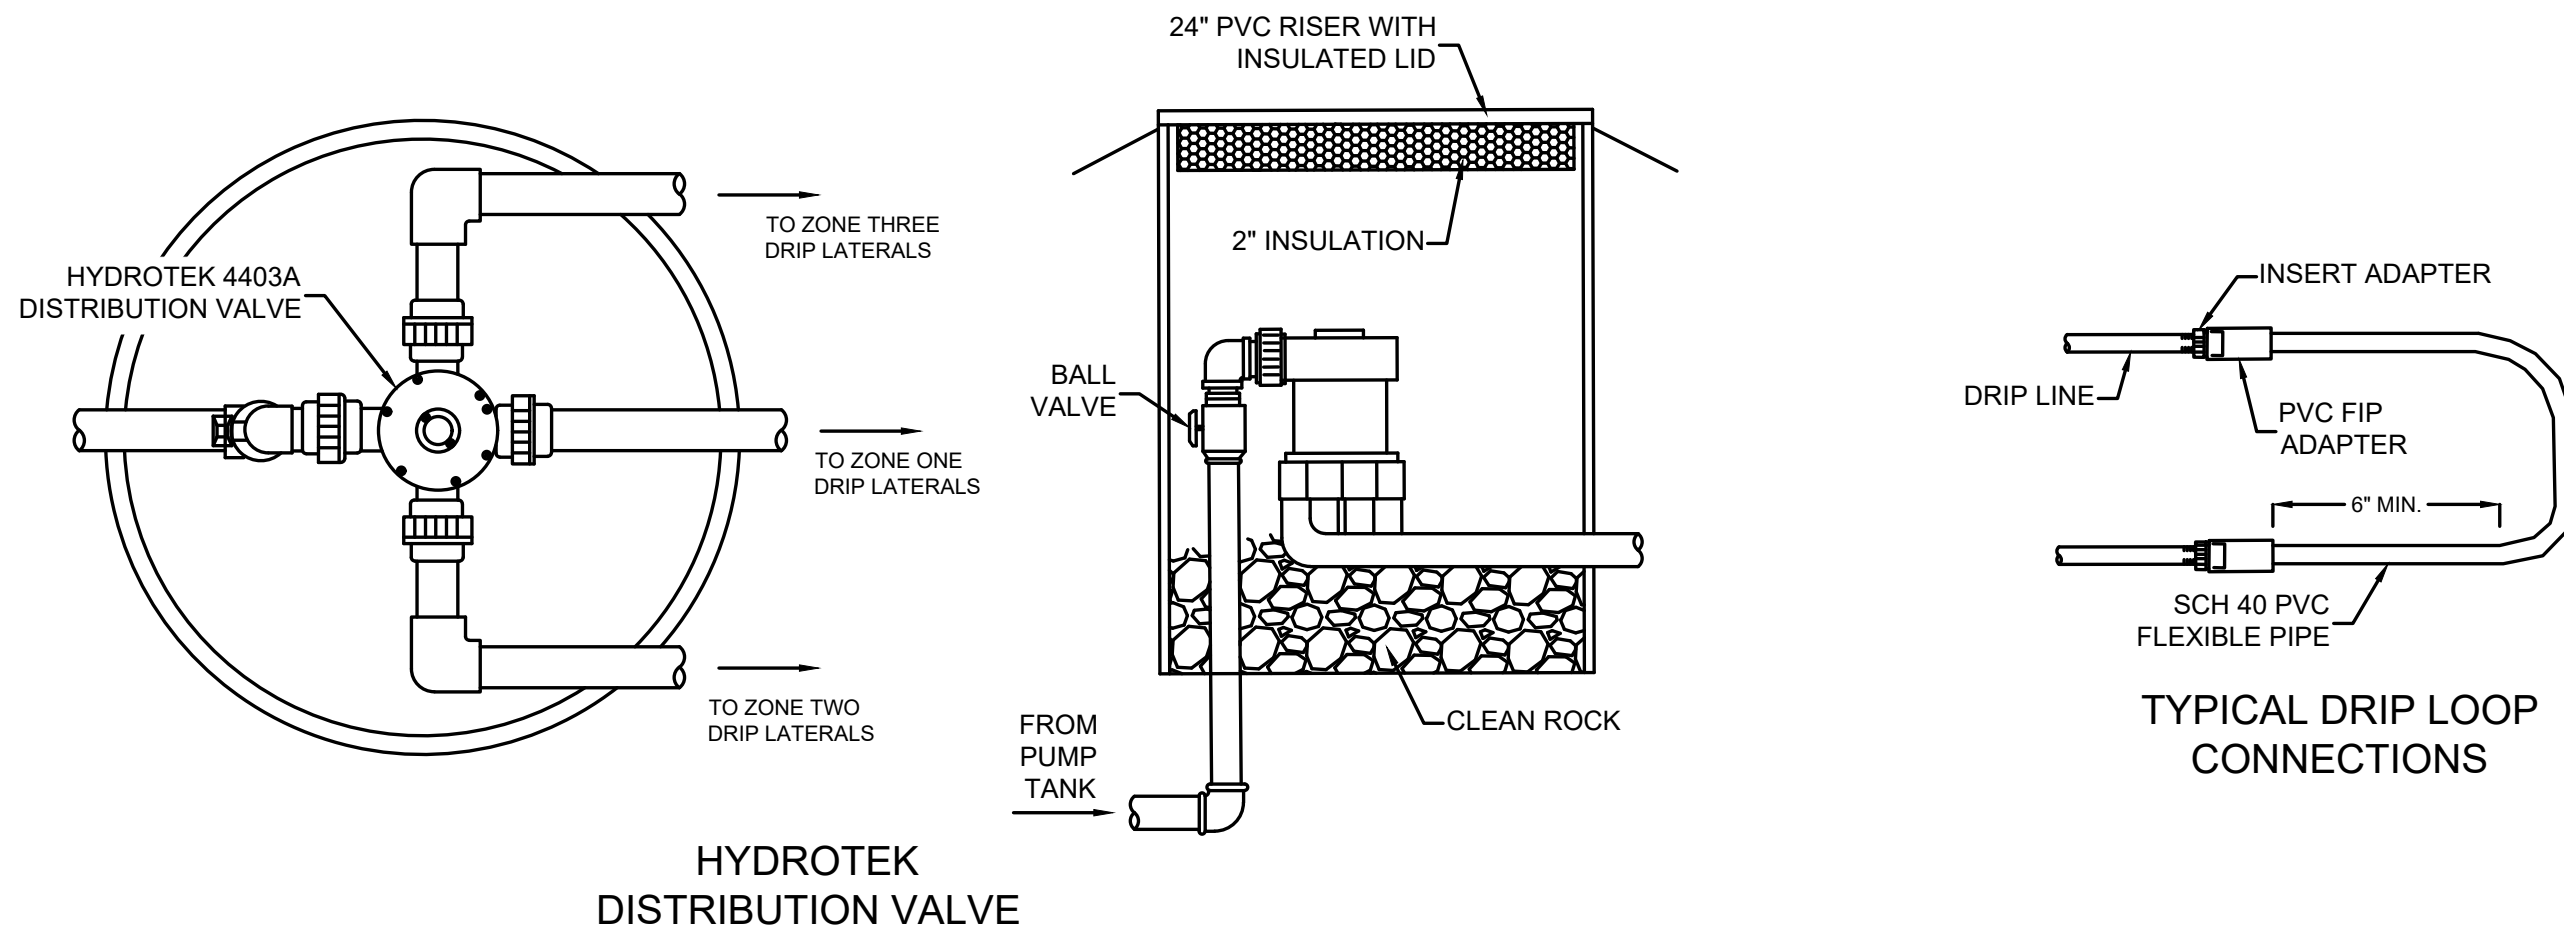
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SEWER PLAN AND PROFILE

D:\210266-000\06-DRAWINGS\CIVIL\CONSTRUCTION DOCS\210266-000 SEWR DWG

DRAWING NO.

C500



TANK AND EQUIPMENT NOTES:

- TANKS SHALL BE PRECAST CONCRETE AS SUPPLIED BY SI PRECAST OR EQUAL.
- TANKS MUST PROVIDE ADEQUATE ACCESS POINTS FOR MAINTENANCE AND CLEANING.
- BEDDING REQUIREMENTS: TANKS SHALL BE PLACED ON SOILS CAPABLE OF BEARING WEIGHT OF TANK AND CONTENTS. SOFT SOILS OR BEDROCK SHALL HAVE A MINIMUM 4" TAMPED BEDDING 100% WHICH SHALL PASS A 1 1/4" SCREEN MADE UP OF CLEAN STONE (CLEAN PEA STONE IS PREFERRED). THE CENTER BEDDING UNDER THE TANK SHOULD BE 1" LOWER THAN THE PERIMETER BEDDING.
- BACKFILL: SIDEWALLS REQUIRE BACKFILL WHICH 100% SHALL PASS A 2" SCREEN MATERIAL MADE UP OF DRY SOIL, SAND OR GRAVEL. MINIMUM 12" ALL SIDES OF TANK, FROM BASE TO TOP. NO PARALLEL BACKFILLING OR COMPACTION ALONG LENGTH OF SIDEWALLS IS PERMITTED. NO WHEEL OR TRACK LOADING ON SIDEWALLS. MATERIAL ON TOP TANK TO PASS 4" SCREEN & DRY. STANDARD TANK DESIGN IS FROM 2'-0" TO 7'-0" BURY DEPTH. OVER 7'-0" BURY DEPTH MAY REQUIRE A CLASS 3 TANK
- CONTRACTOR SHALL PERFORM A HYDROSTATIC LEAKAGE TEST PRIOR TO BACKFILLING OF TANKS.
- ALL INLET AND OUTLET BAFFLES INTERNAL TO TANKS SHALL BE CONSTRUCTED OF SCHEDULE 40 PVC.
- MANHOLE RISERS TO BE 24" TUF-TITE SEPTIC TANK RISERS OR EQUIVALENT.
- AERATION TREATMENT UNIT SHALL BE DELTA ECOPOD E100N FIXED FILM TREATMENT UNIT OR EQUAL WITH 2/3 HP BLOWER. ATU TO BE INSTALLED PER MANUFACTURER RECOMMENDATION. ATU CONTROL PANEL SHALL BE SECURELY MOUNTED ON TREATED WOOD POST.
- DOSING PUMP SHALL BE A SUBMERSIBLE STARITE S20 HIGH HEAD TURBINE PUMP WITH 1/2 HP MOTOR OR EQUAL.
- DOSING PUMP SHALL BE CONTROLLED BY A SEPTIC PRODUCTS INC. TIME DOSING PANEL 50A801 OR EQUAL, INSTALLED PER MANUFACTURER'S RECOMMENDATIONS. PUMP CONTROL PANEL SHALL BE SECURELY MOUNTED TO A WOOD POST, ADJACENT TO BLOWER CONTROL PANEL.
- SEWER CONTRACTOR SHALL INSTALL CONDUIT AND CONDUCTORS FROM DISCONNECT TO CONNECT CONTROL PANELS, BLOWER, AND PUMP PER NATIONAL ELECTRICAL CODE REQUIREMENTS.



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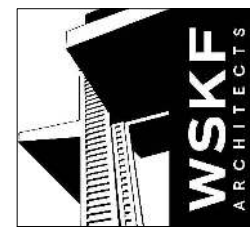
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210266-000

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SEWER DETAILS

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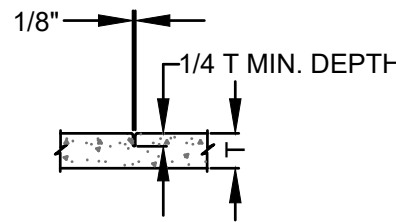
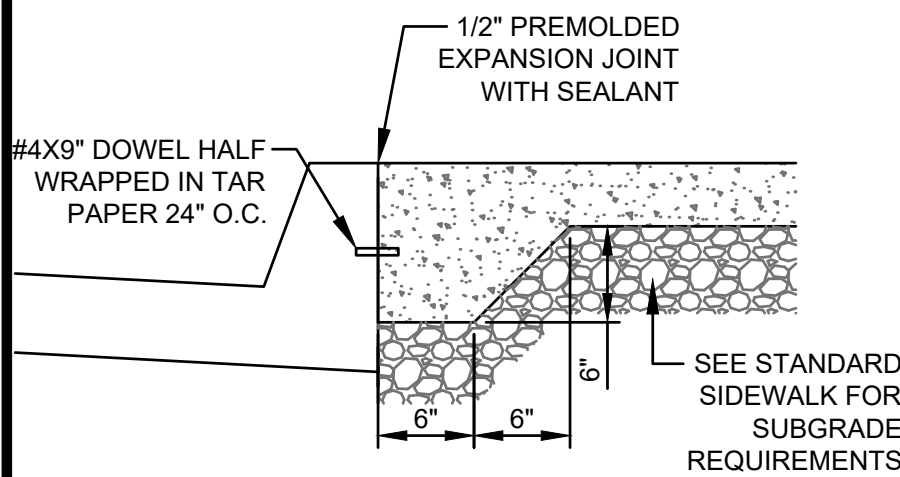
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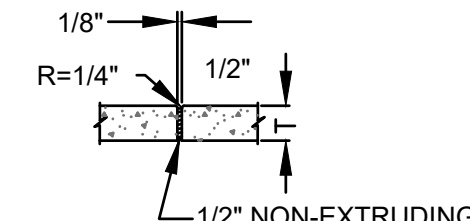
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DETAILS



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C600



CONTROL JOINT



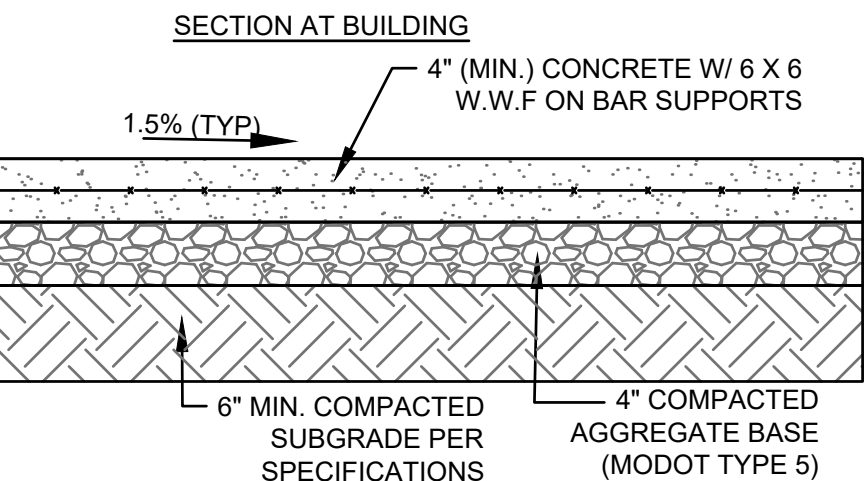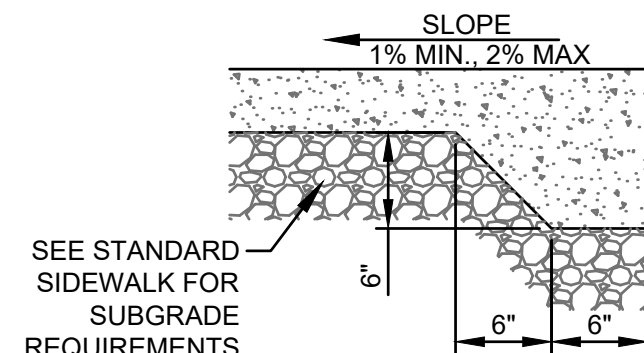
EXPANSION JOINT




NOTES

1. CONCRETE SHALL CONFORM TO KCMO SPECIFICATIONS. (KCMMB4K)
2. 1/2" RUBBER EXPANSION JOINTS SHALL BE PLACED WHERE WALK ABUTS JUNCTION OF EXISTING WALK, CONCRETE CURBS, DRIVEWAYS AND SIMILAR STRUCTURES, AND AS SHOWN IN THE DRAWINGS.
3. CONTROL JOINTS SHALL BE PLACED AS SHOWN ON THE DRAWINGS OR AT DISTANCE NOT EXCEEDING THE WIDTH OF THE SIDEWALK, IF NOT SHOWN.
4. SAWCUT ALL CONTROL JOINTS.
5. ALL JOINTS SHALL BE SEALED WITH VULCAN 45 OR DOW CORNING 888 SILICON JOINT SEALANT.

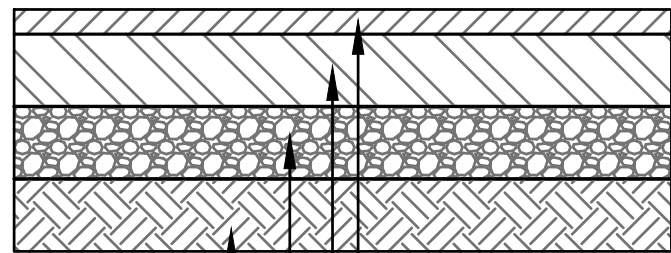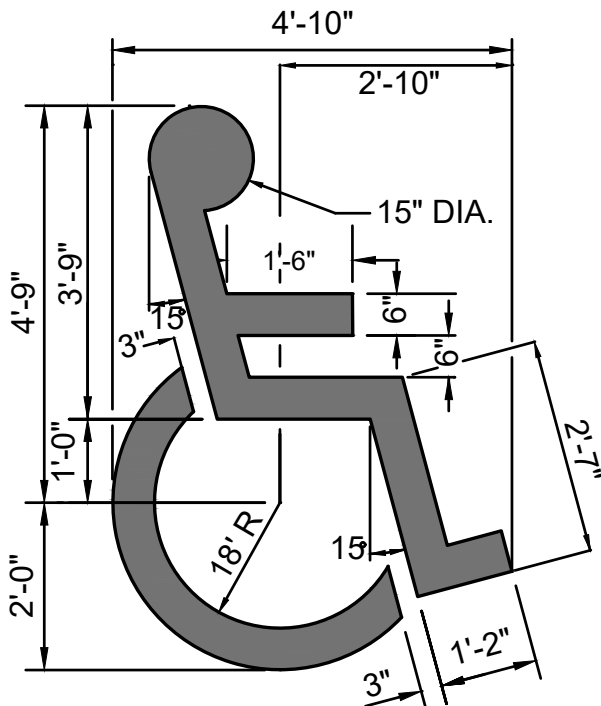SIDEWALK DETAILS
NOT TO SCALE

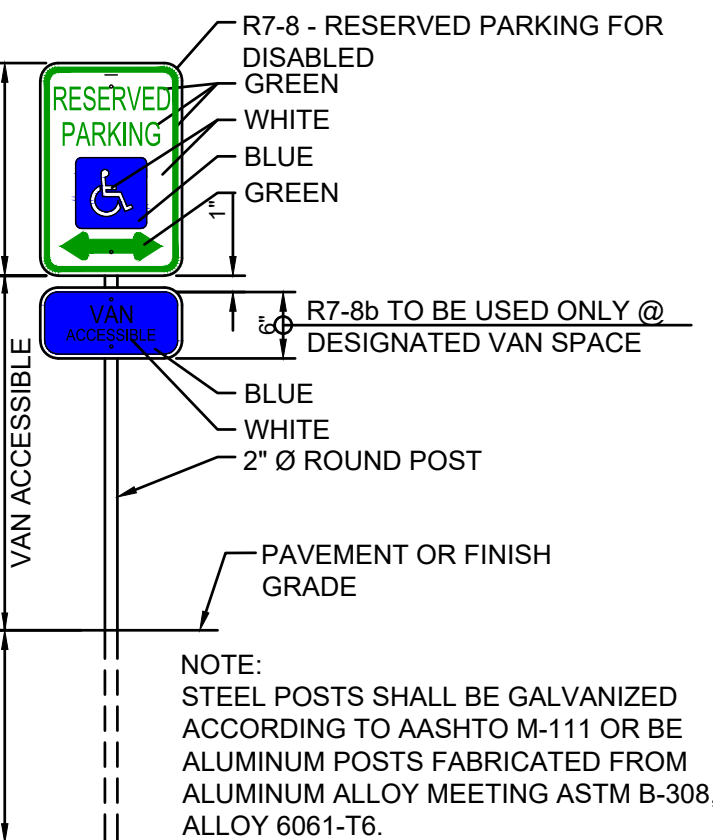


ASPHALT PAVEMENT DETAIL
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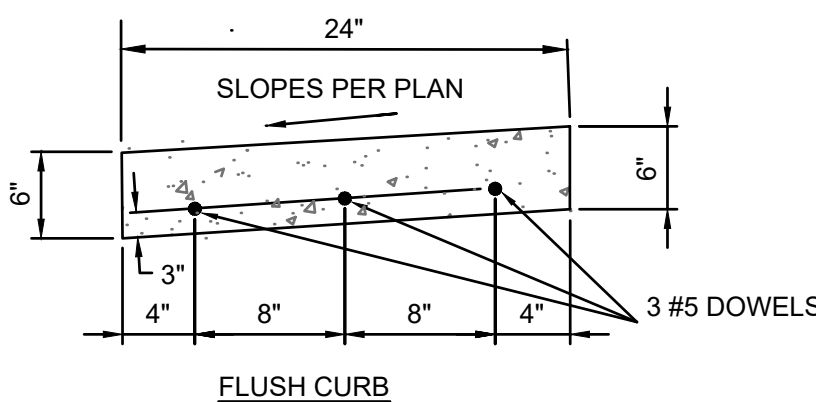
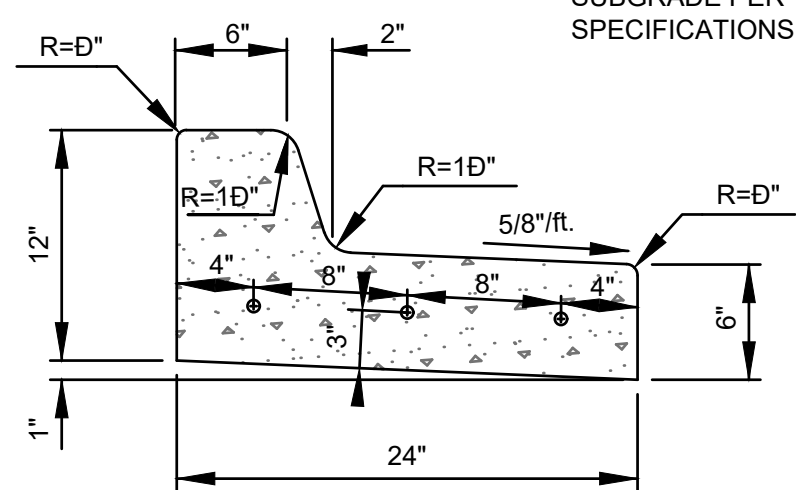
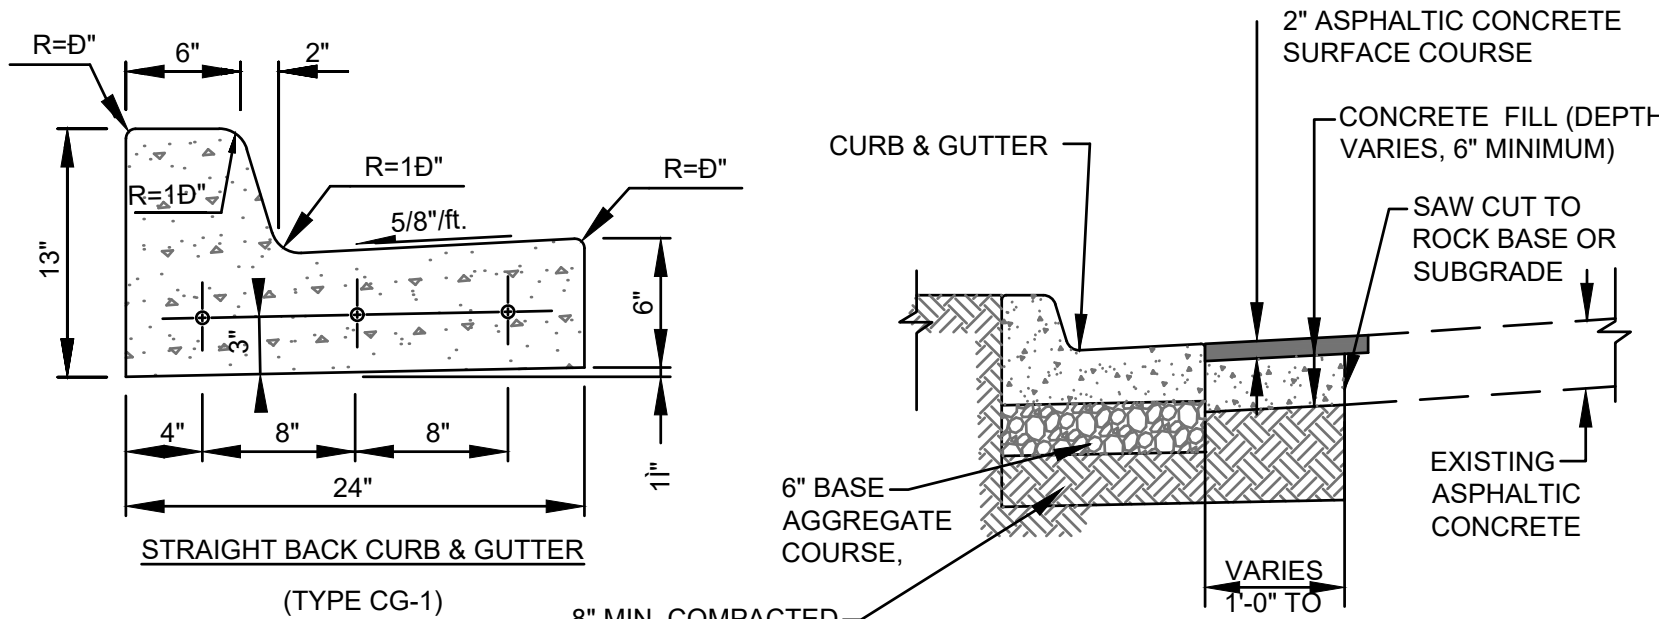


- NOTE:
1. ACCESSIBLE SYMBOL TO BE 6" WHITE LINE
 2. ACCESSIBLE PARKING STALLS SHALL HAVE 4" SOLID BLUE LINES FOR STALL LINES, AND ACCESS AISLES.

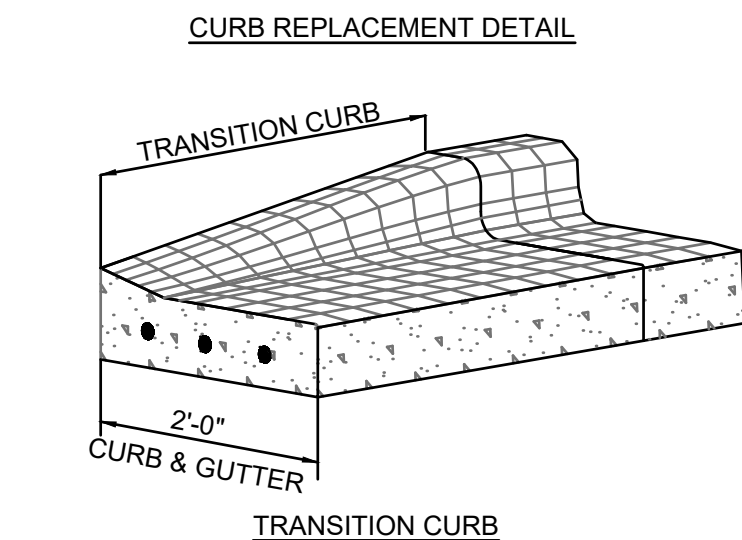
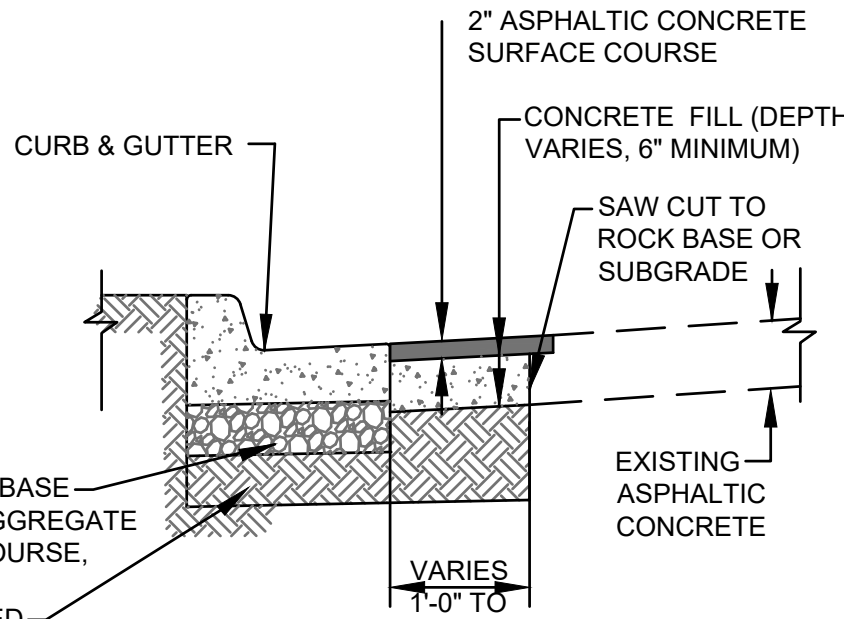
ACCESSIBLE PARKING SYMBOL
NOT TO SCALE



ACCESSIBLE PARKING SIGN
NOT TO SCALE

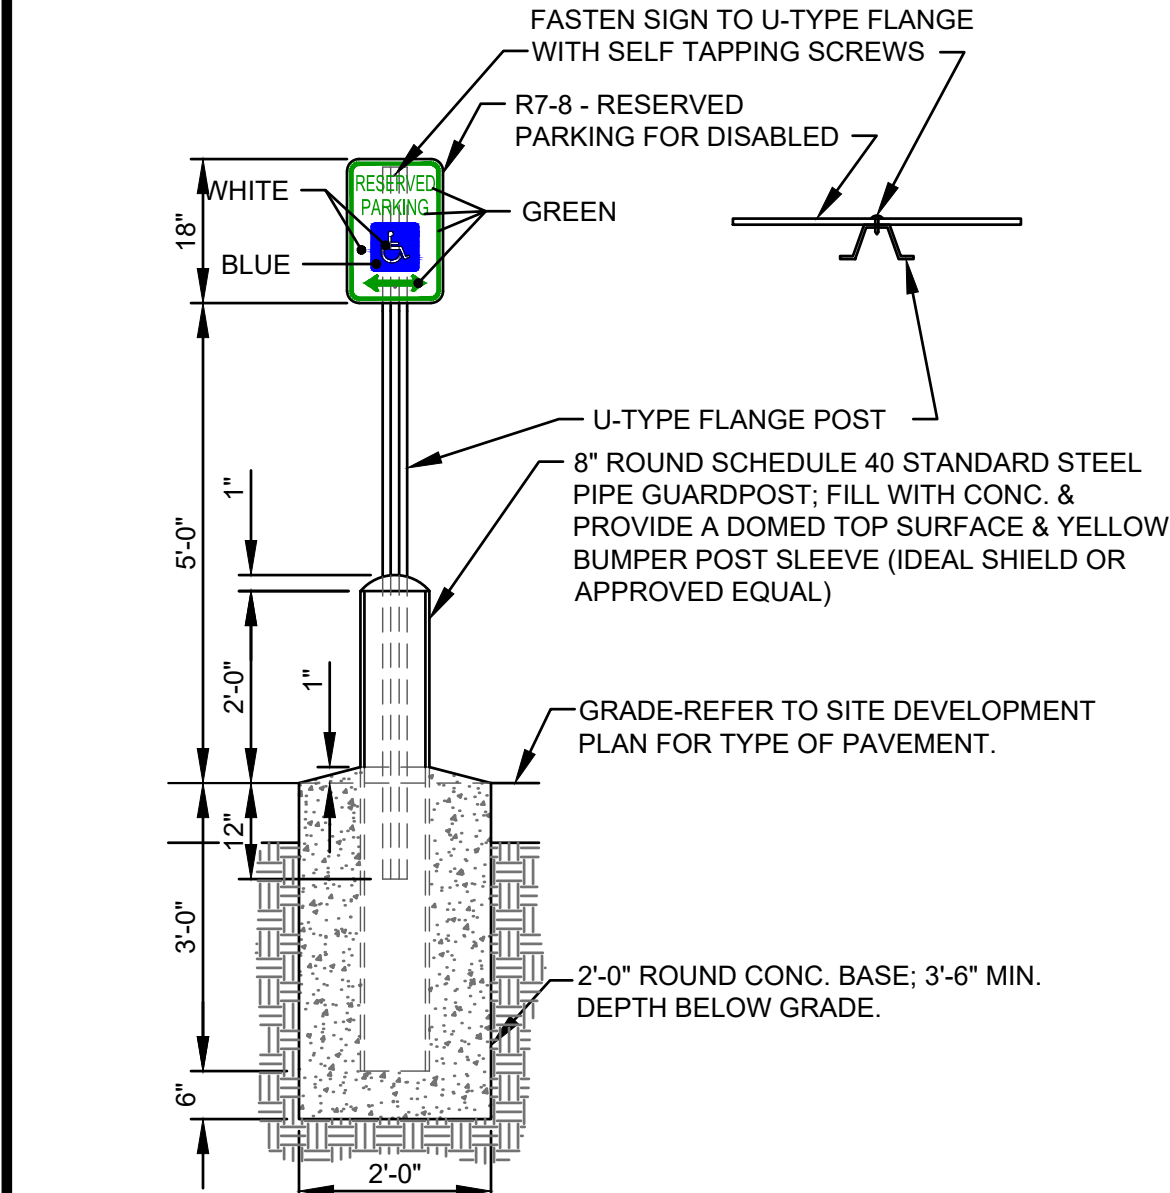


CURB DETAILS
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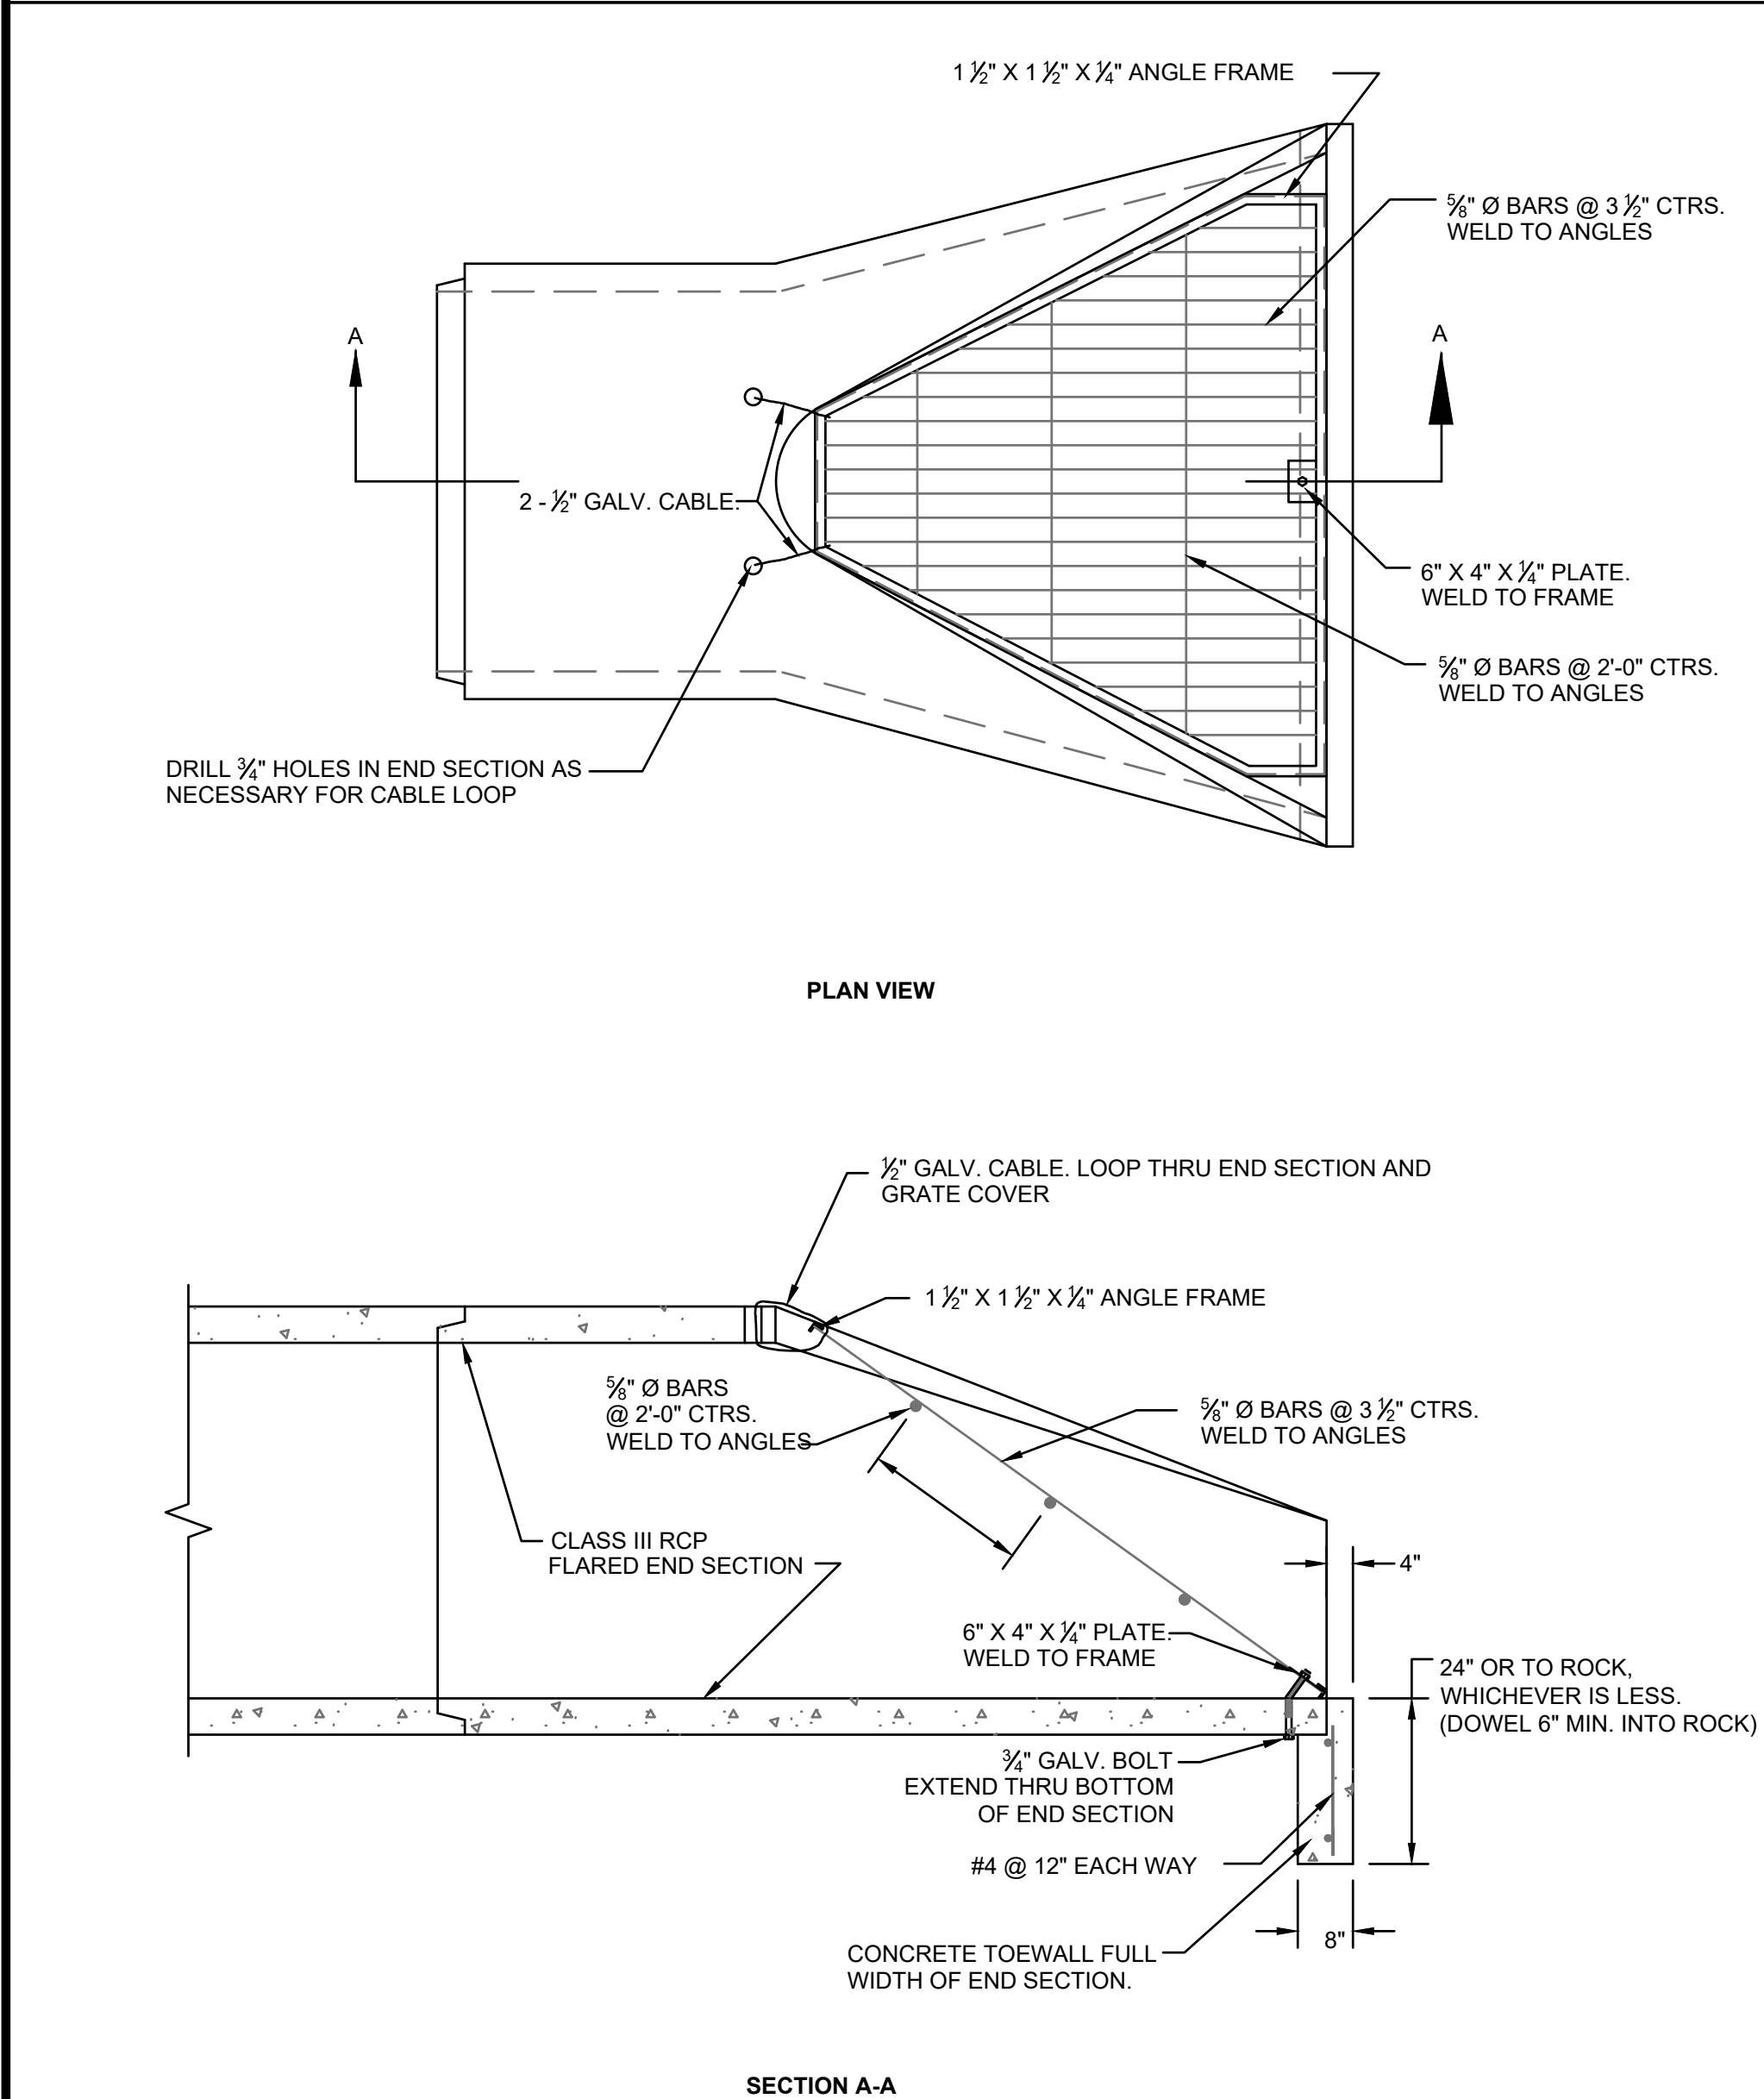


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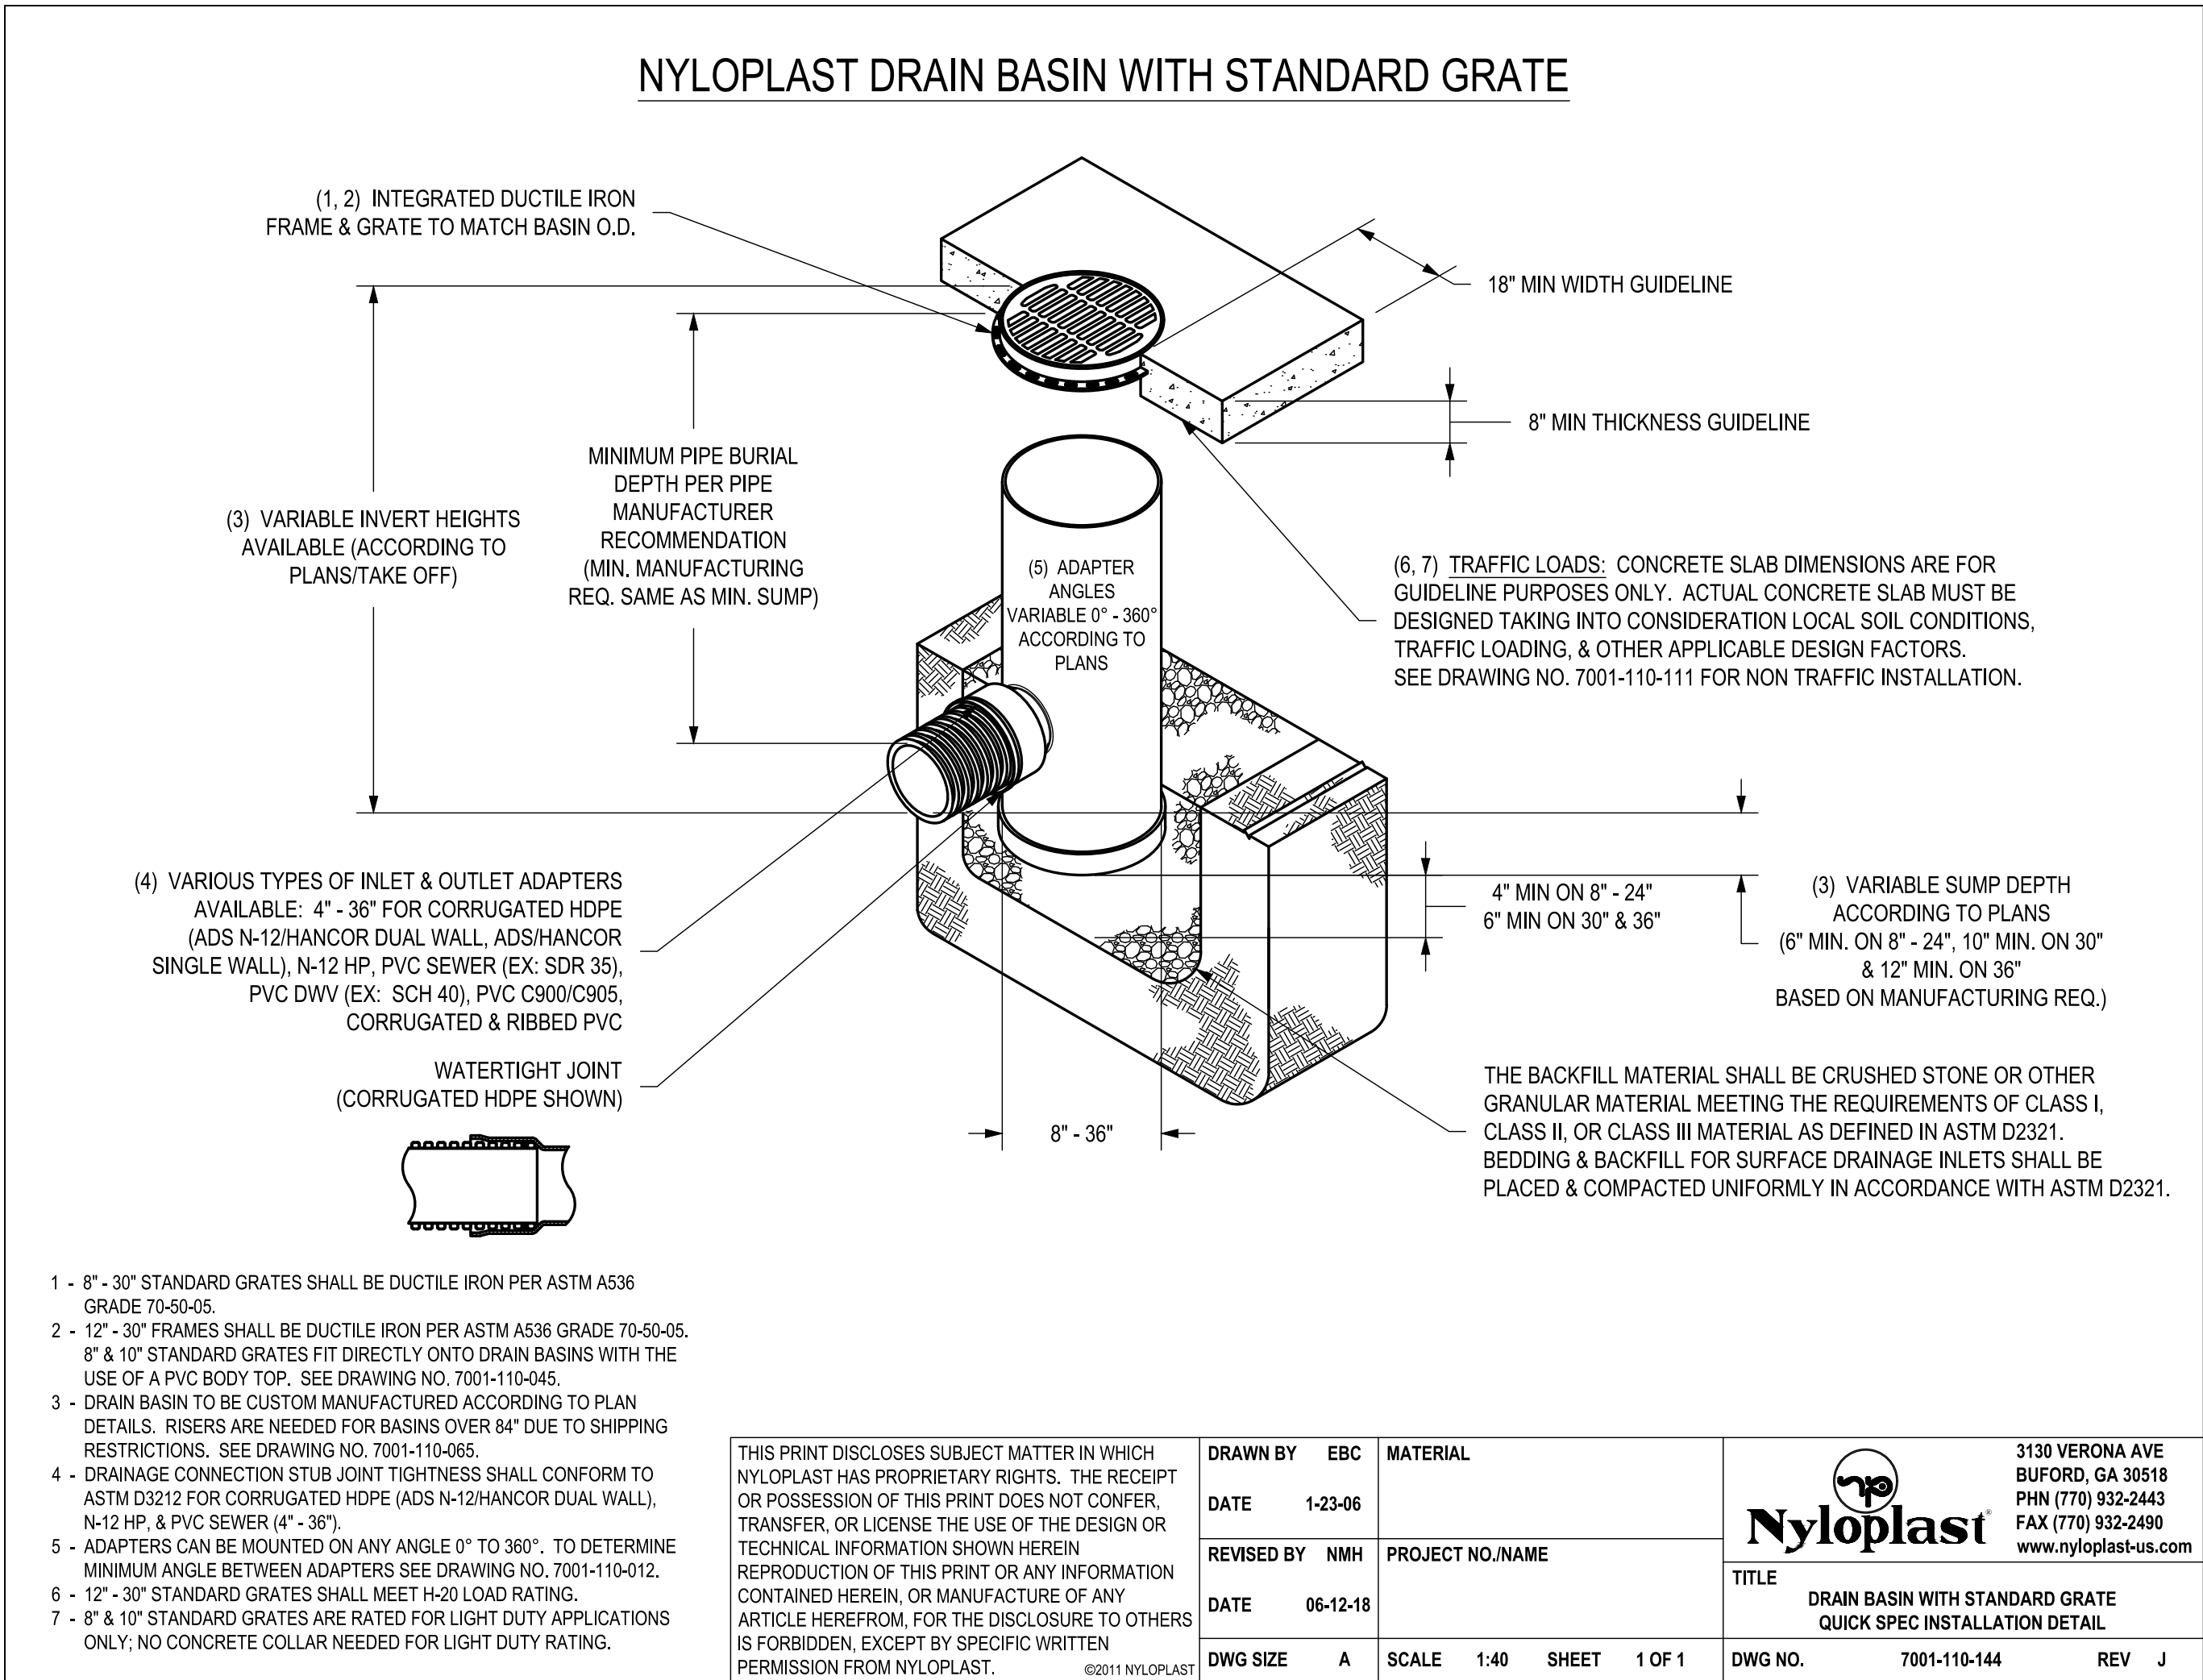
DISABLED SIGN ON 8" BOLLARD
NOT TO SCALE



END SECTION TOEWALL & GRATE
NOT TO SCALE

END SECTION NOTES

1. GRATE COVER DETAIL SHALL BE ADJUSTED AS NECESSARY TO FIT END SECTION PROVIDED.
2. MAXIMUM OPENING THRU END SECTION SHALL BE NO GREATER THAN 6". ADJUST DETAIL AS NECESSARY.
3. ALL METAL SURFACES SHALL BE HOT DIP ZINC COATED IN ACCORDANCE WITH ASTM A-123.
4. USE KCMMB4K CONCRETE THROUGHOUT.
5. ALL CONCRETE USED IN THIS WORK SHALL MEET THE REQUIREMENTS OF THE SHAWNEE TECHNICAL SPECIFICATIONS.
6. REINFORCING STEEL SHALL BE NEW BILLET, MINIMUM GRADE 40 AS PER ASTM A615, AND SHALL BE BENT COLD.
7. ALL DIMENSIONS RELATIVE TO REINFORCING STEEL ARE TO CENTERLINE OF BARS. 2" CLEARANCE SHALL BE PROVIDED THROUGHOUT UNLESS NOTED OTHERWISE. TOLERANCE OF +/- 1/8" SHALL BE PERMITTED.
8. ALL LAP SPLICES NOT SHOWN SHALL BE A MINIMUM OF 40 BAR DIAMETERS IN LENGTH.
9. ALL CONCRETE CONSTRUCTION SHALL MEET THE APPLICABLE REQUIREMENTS OF STANDARD SPECIFICATIONS FOR STATE ROAD AND BRIDGE CONSTRUCTION. KANSAS DEPARTMENT OF TRANSPORTATION, LATEST EDITION, AND SPECIAL PROVISIONS.
10. ALL DOWELS SHALL BE ACCURATELY PLACED AND SECURELY TIED IN PLACE PRIOR TO PLACEMENT OF BOTTOM SLAB CONCRETE. STICKING OF DOWELS INTO FRESH OR PARTIALLY HARDENED CONCRETE WILL NOT BE ACCEPTABLE.
11. ALL REINFORCING STEEL SHALL BE SUPPORTED ON FABRICATED STEEL BAR SUPPORTS @ 3'-0" MAXIMUM SPACING.
12. DO NOT SCALE THESE DRAWINGS FOR DIMENSIONS OR CLEARANCES. SEE PLANS FOR PROPER DIMENSIONS.
13. INCLUSION OF ALL GRATES SHALL BE PRE APPROVED BY CITY ENGINEER.



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13300 W 88TH STREET
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MO State Certificate of Authority #E-2002020886

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DETAILS

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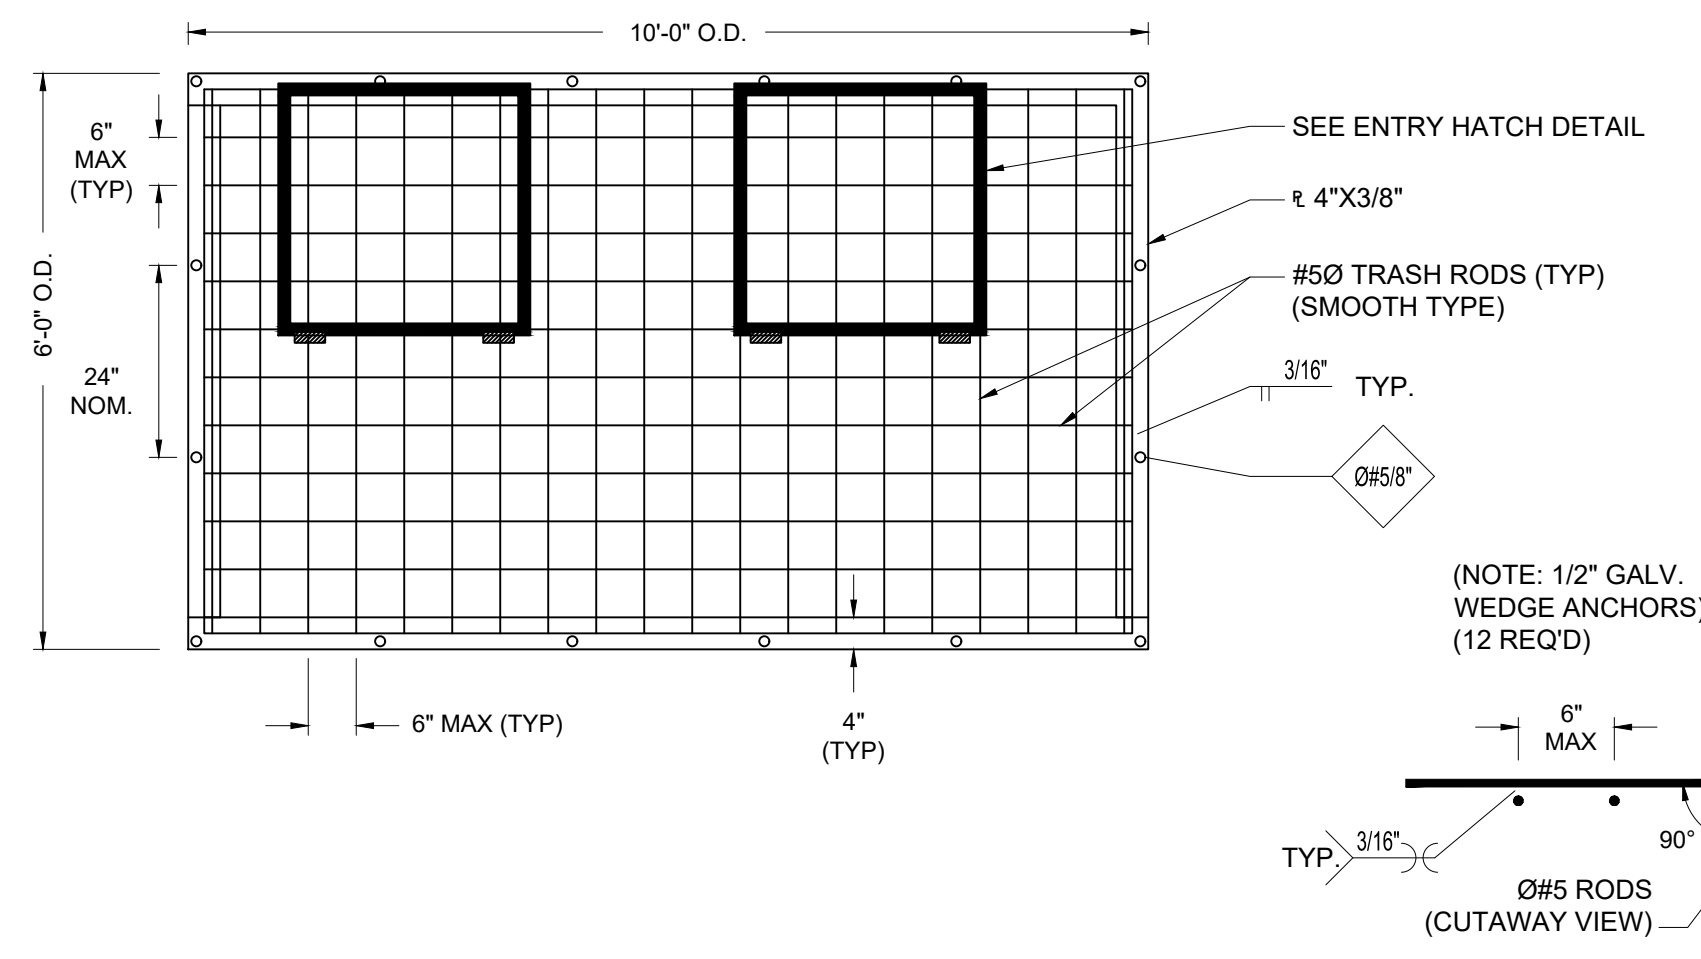
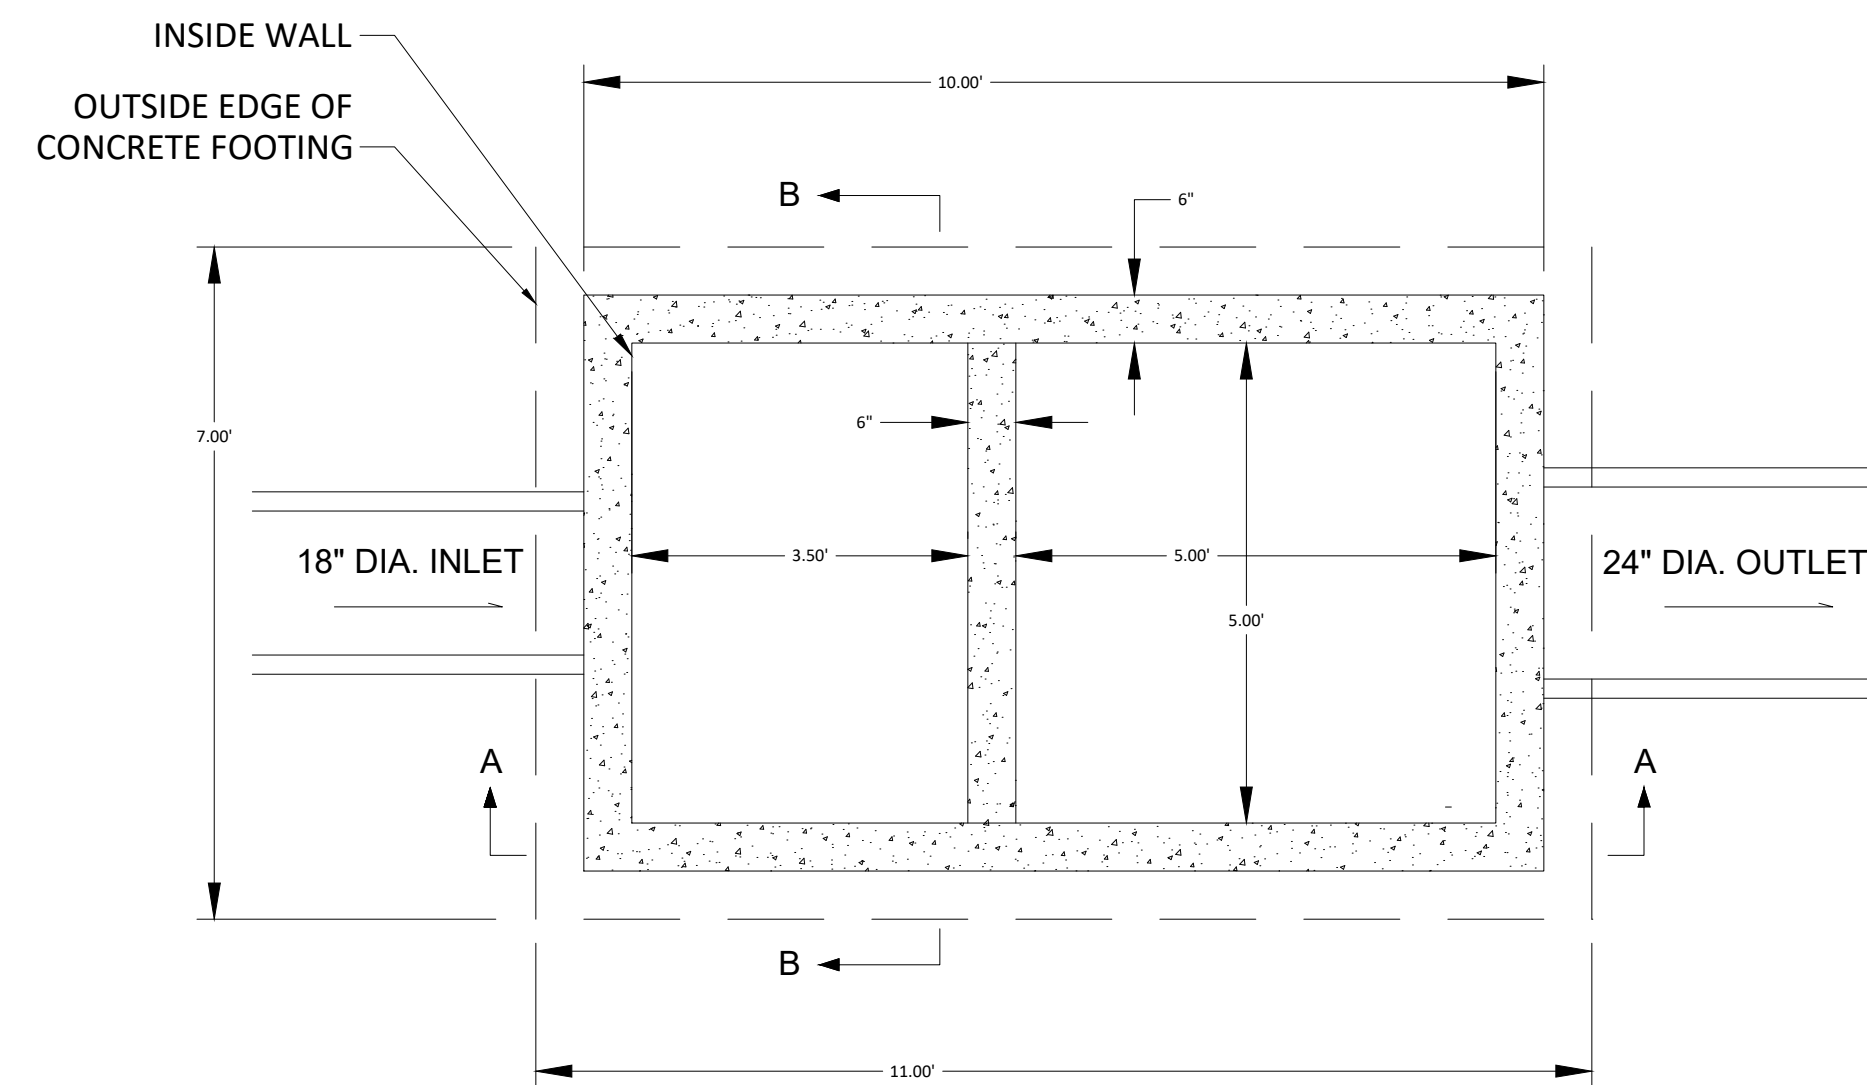
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DETENTION DETAILS

DRAWING NO.

C603

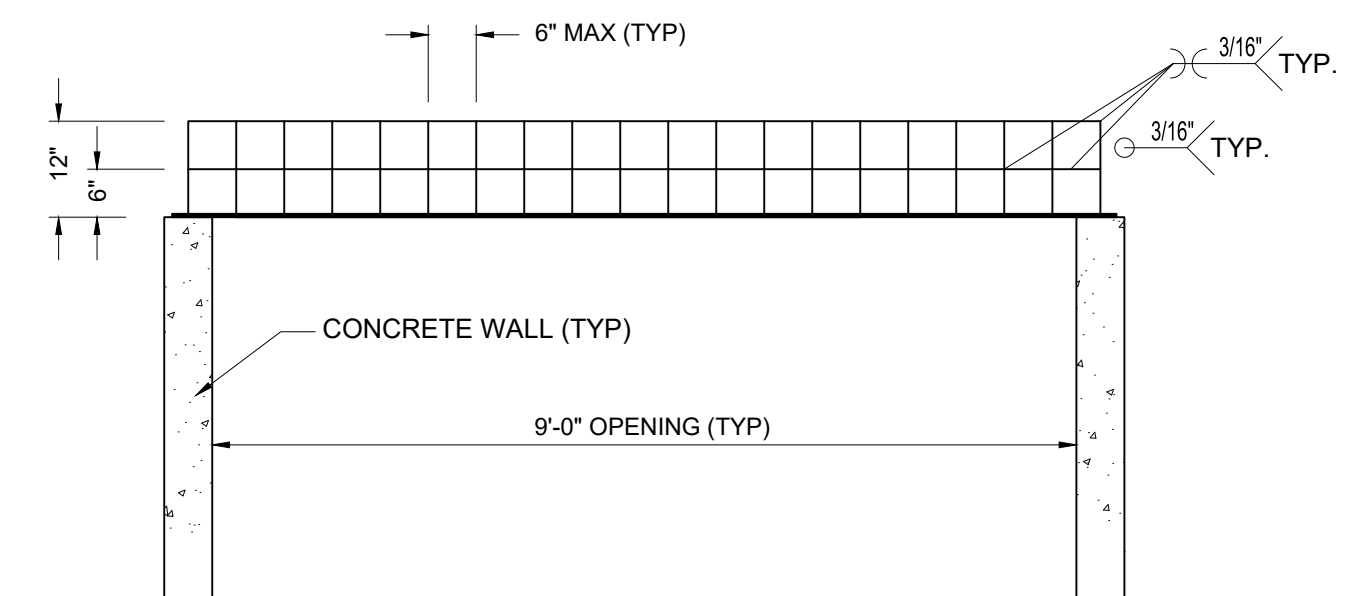


TRASH RACK - PLAN VIEW

SCALE: NONE


ROD INTERSECT DETAIL

SCALE: NONE




TRASH RACK - SIDE VIEW

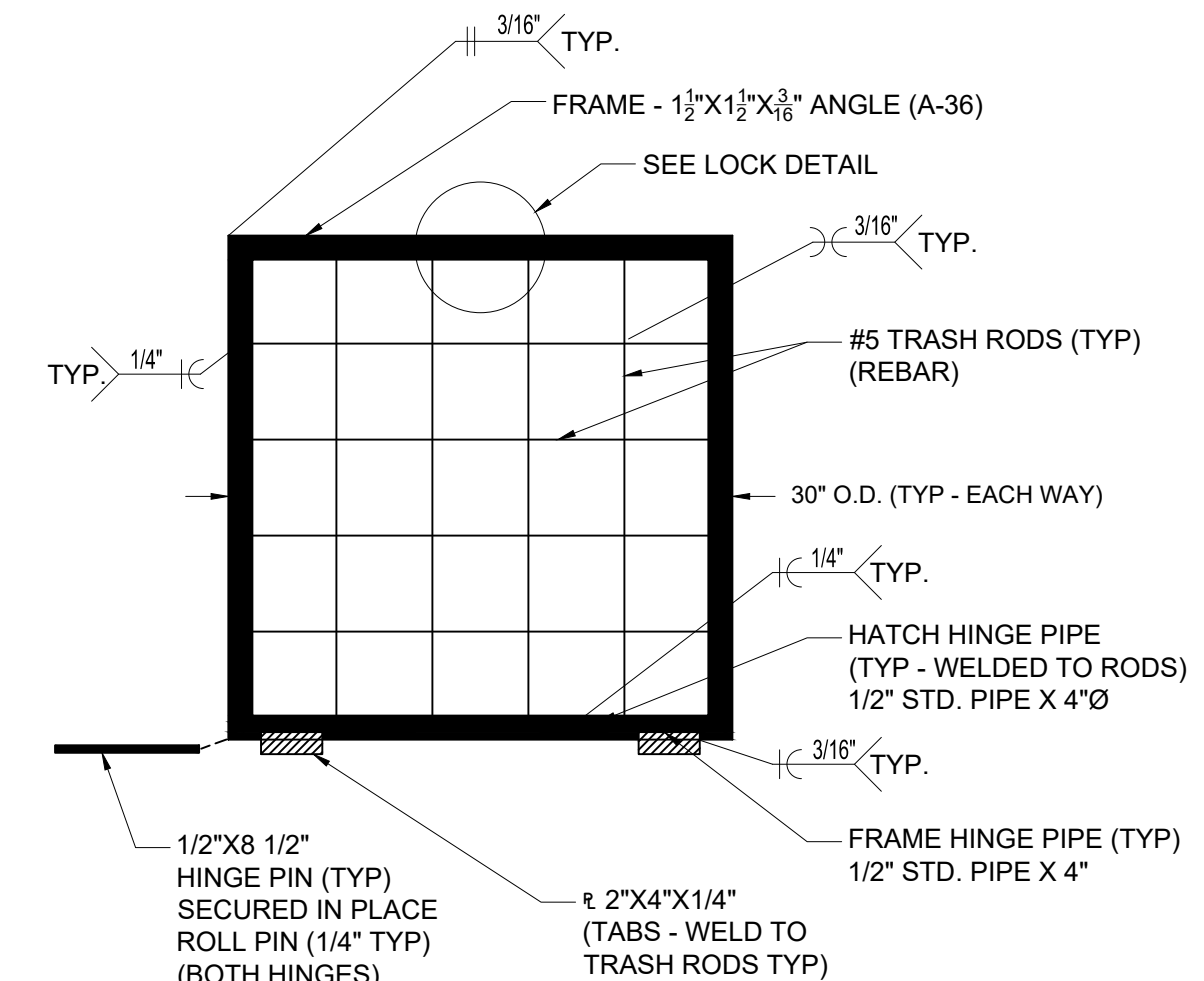SCALE: NONE





LOCKING HATCH (PLAN)

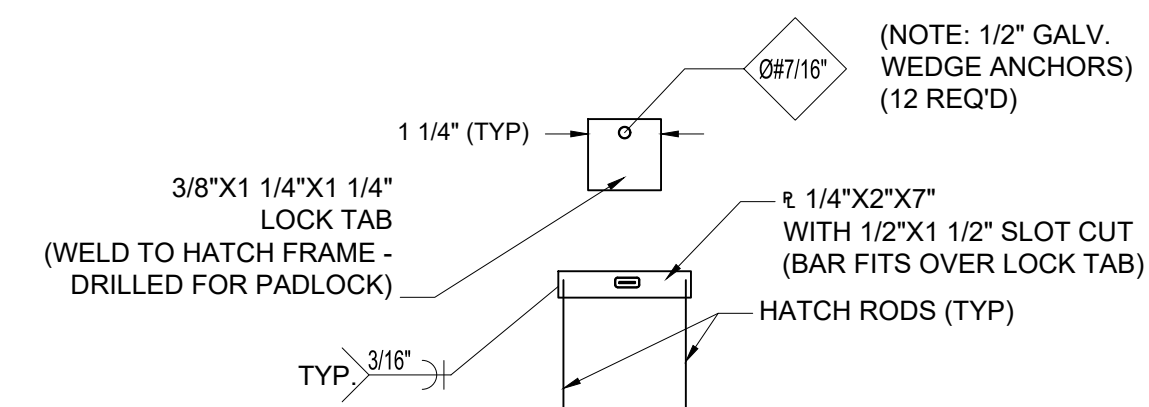SCALE: NONE




LOCK DETAIL (PLAN)

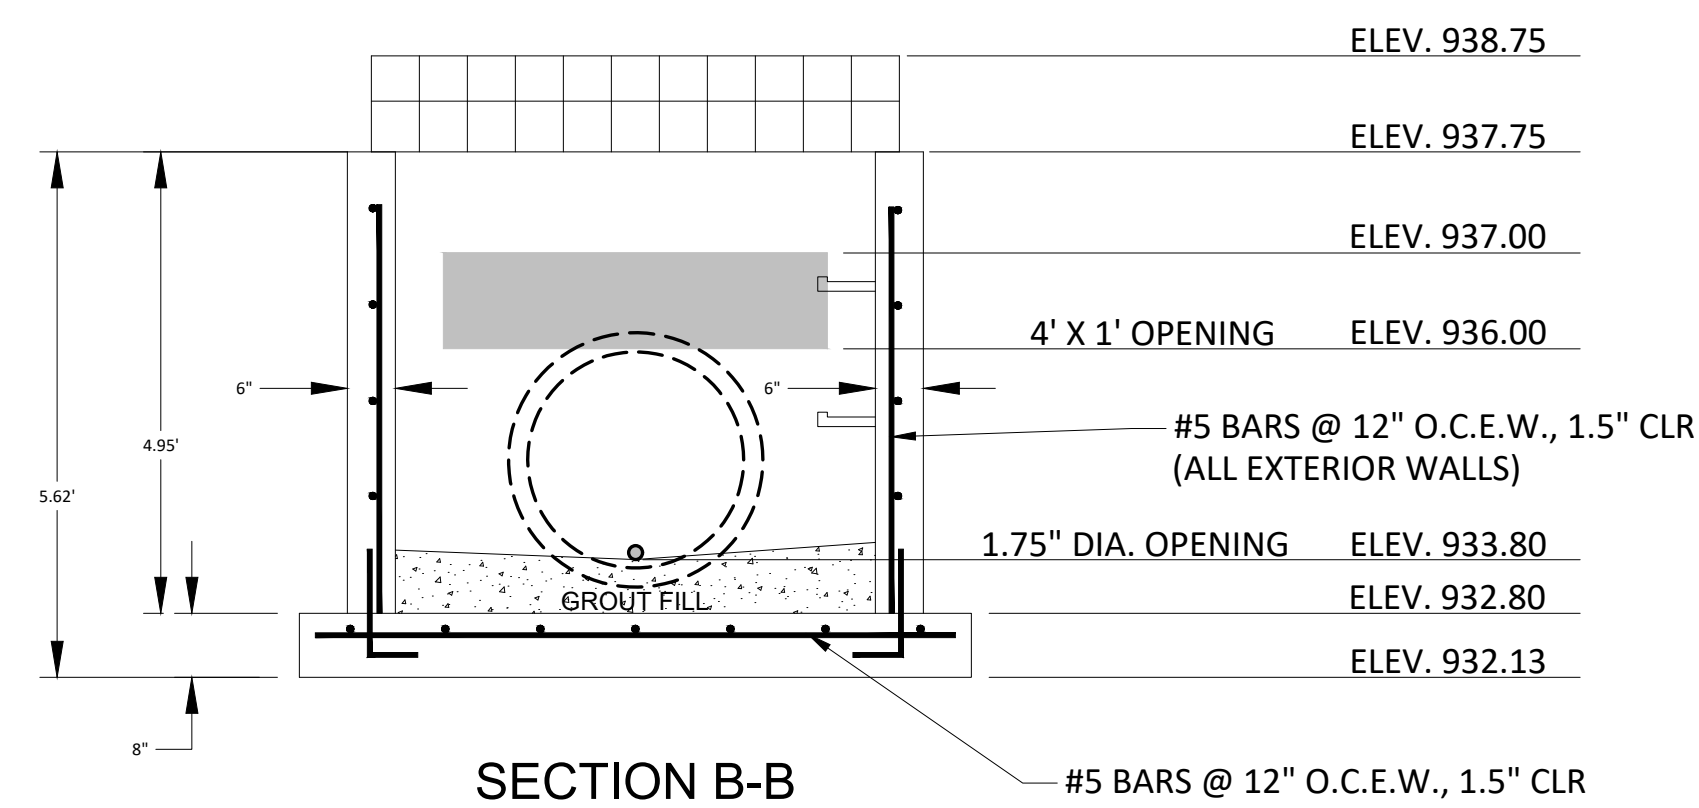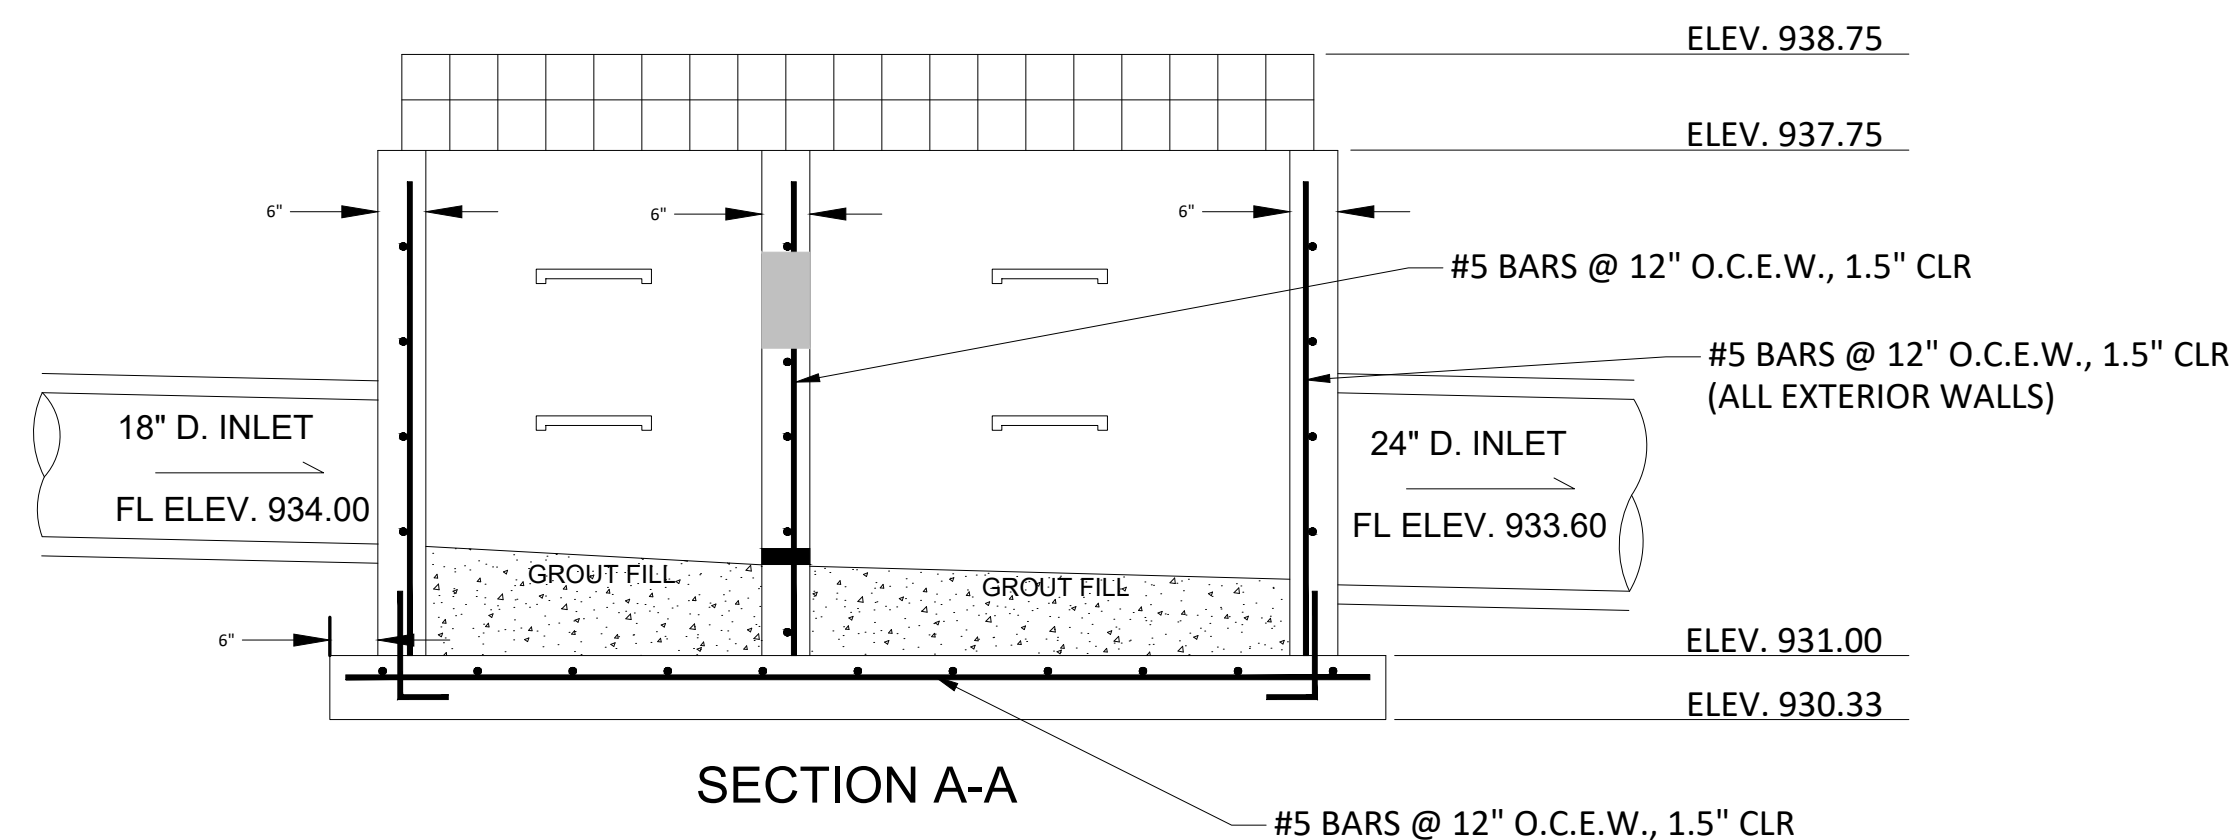SCALE: NONE



DRAINAGE BASIN A-1
E2: CONTROL STRUCTURE DETAIL
N.T.S.

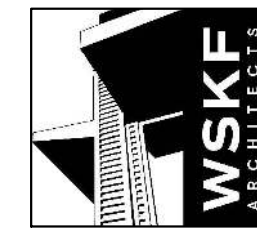NOTE:
SEE SHEET C001 FOR GENERAL NOTES.



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MISSOURI CERTIFICATE OF AUTHORITY NO. E-2006023253
EXPIRES: DECEMBER 31, 2022



REVISIONS

PROJECT INFO
210266-000

ENGINEER DRAWN BY CHECKED BY
AVD AVD

PLATTE RIDGE PARK
FOOTBALL COMPLEX IMPROVEMENTS
17130 HIGHWAY 371, PLATTE CITY, MO 64079

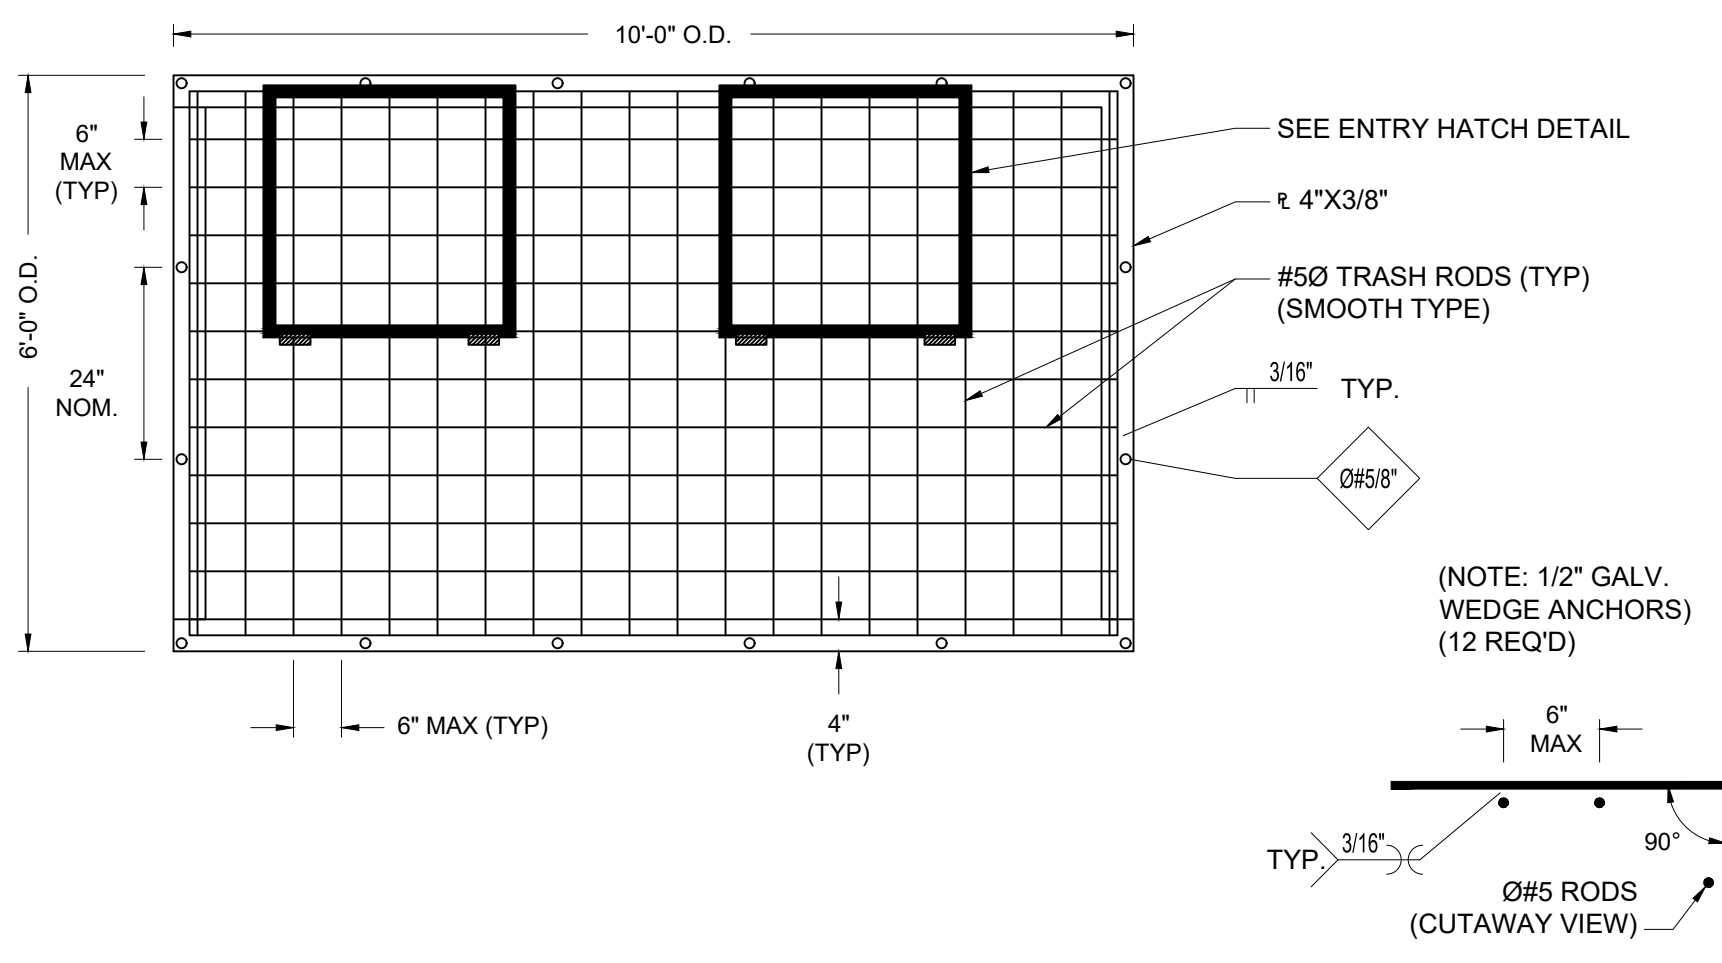
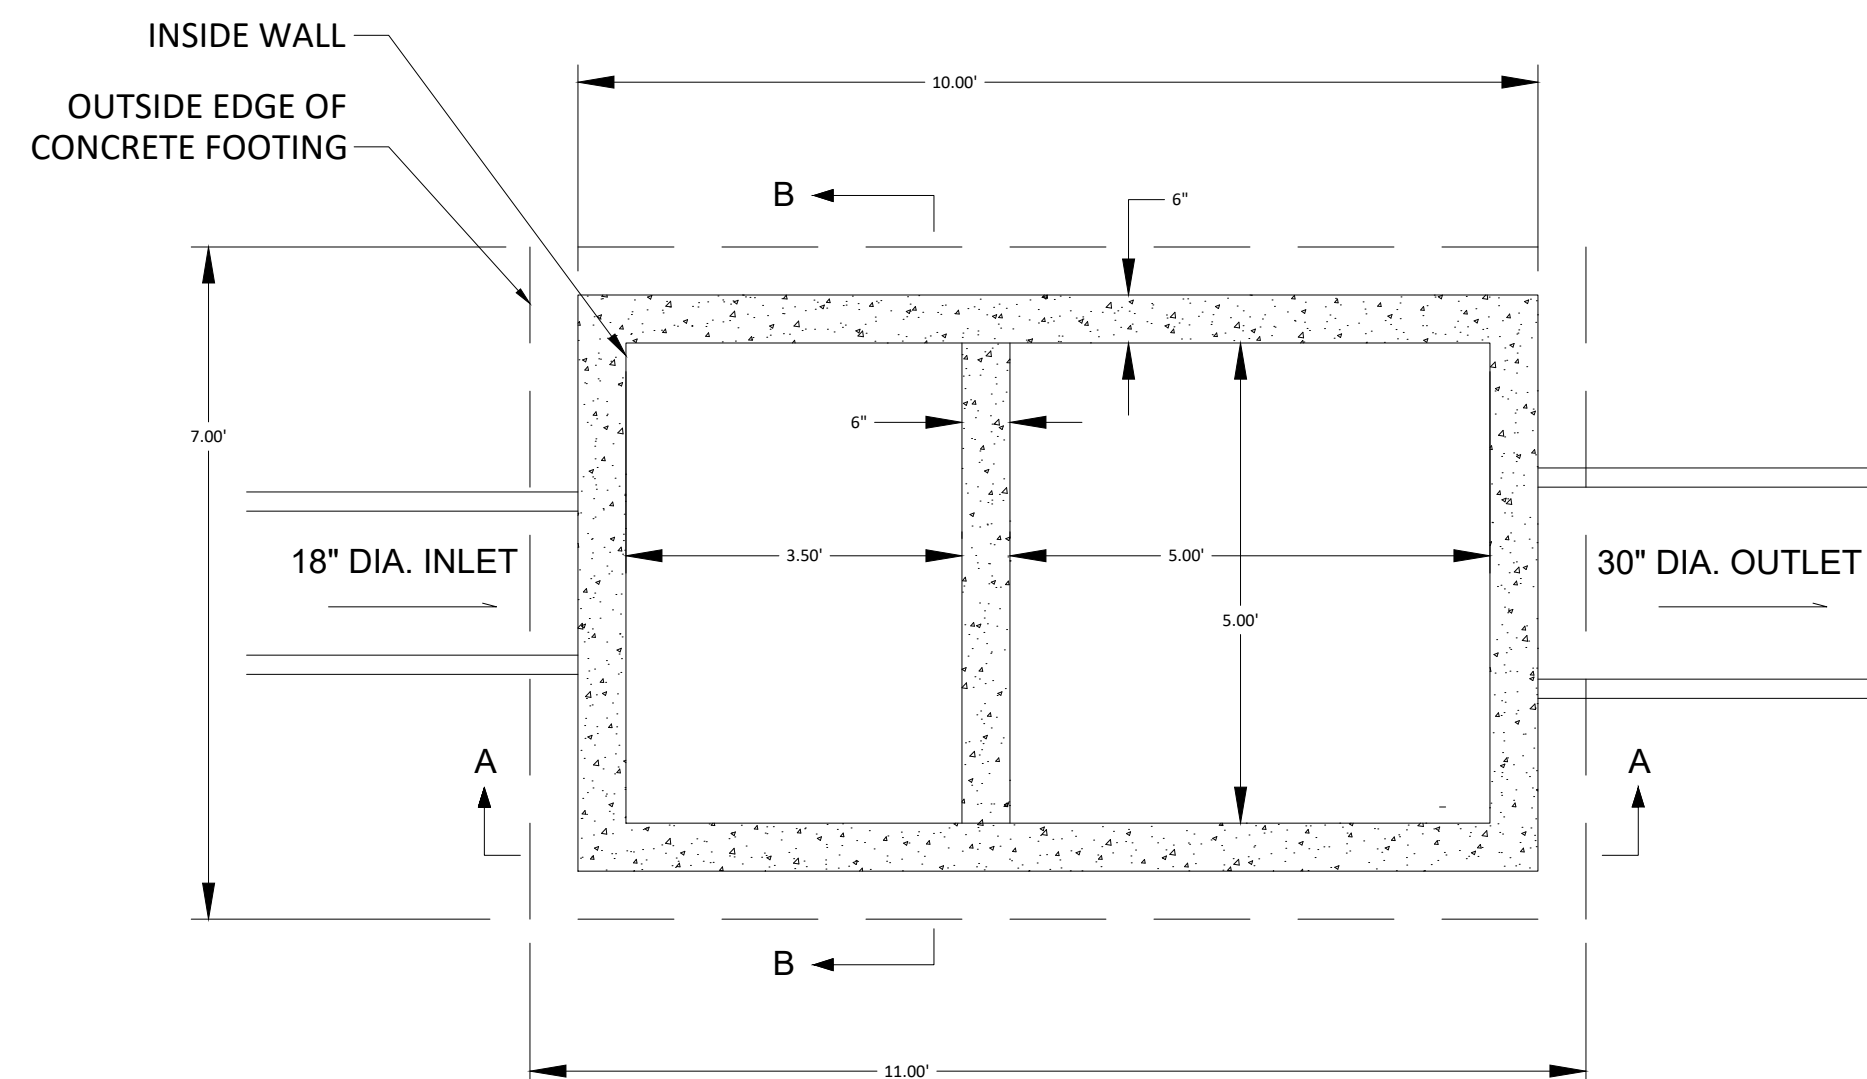
DETENTION DETAILS

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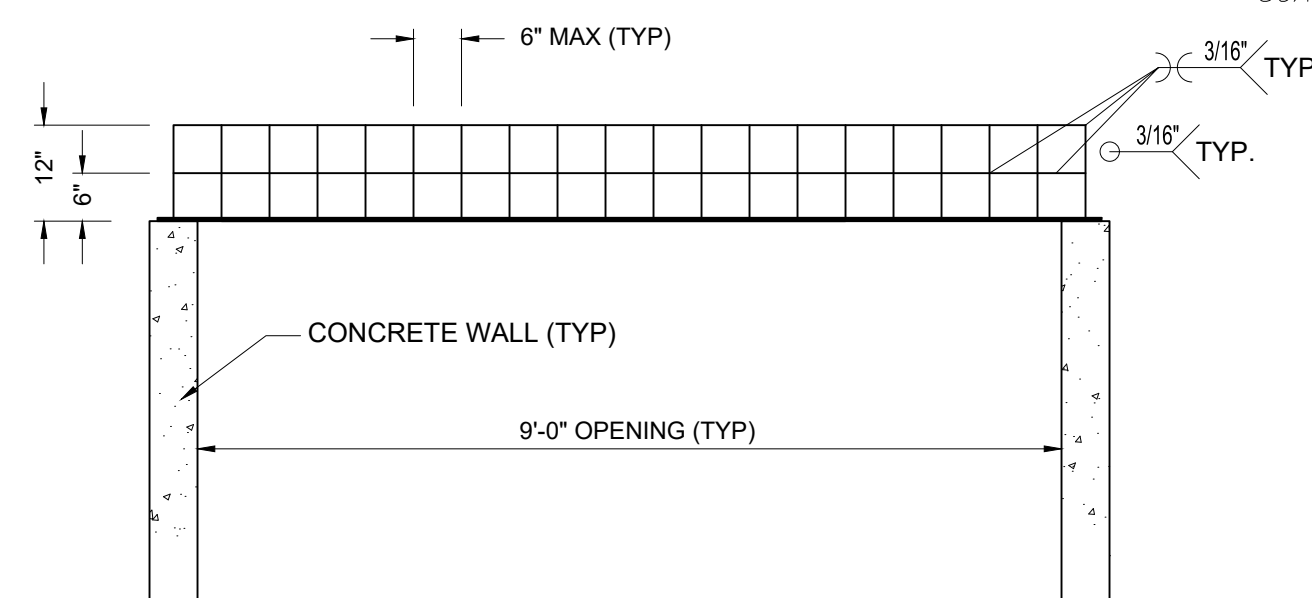
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NOTE:
SEE SHEET C001 FOR GENERAL NOTES.




TRASH RACK - PLAN VIEW

SCALE: NONE




TRASH RACK - SIDE VIEW

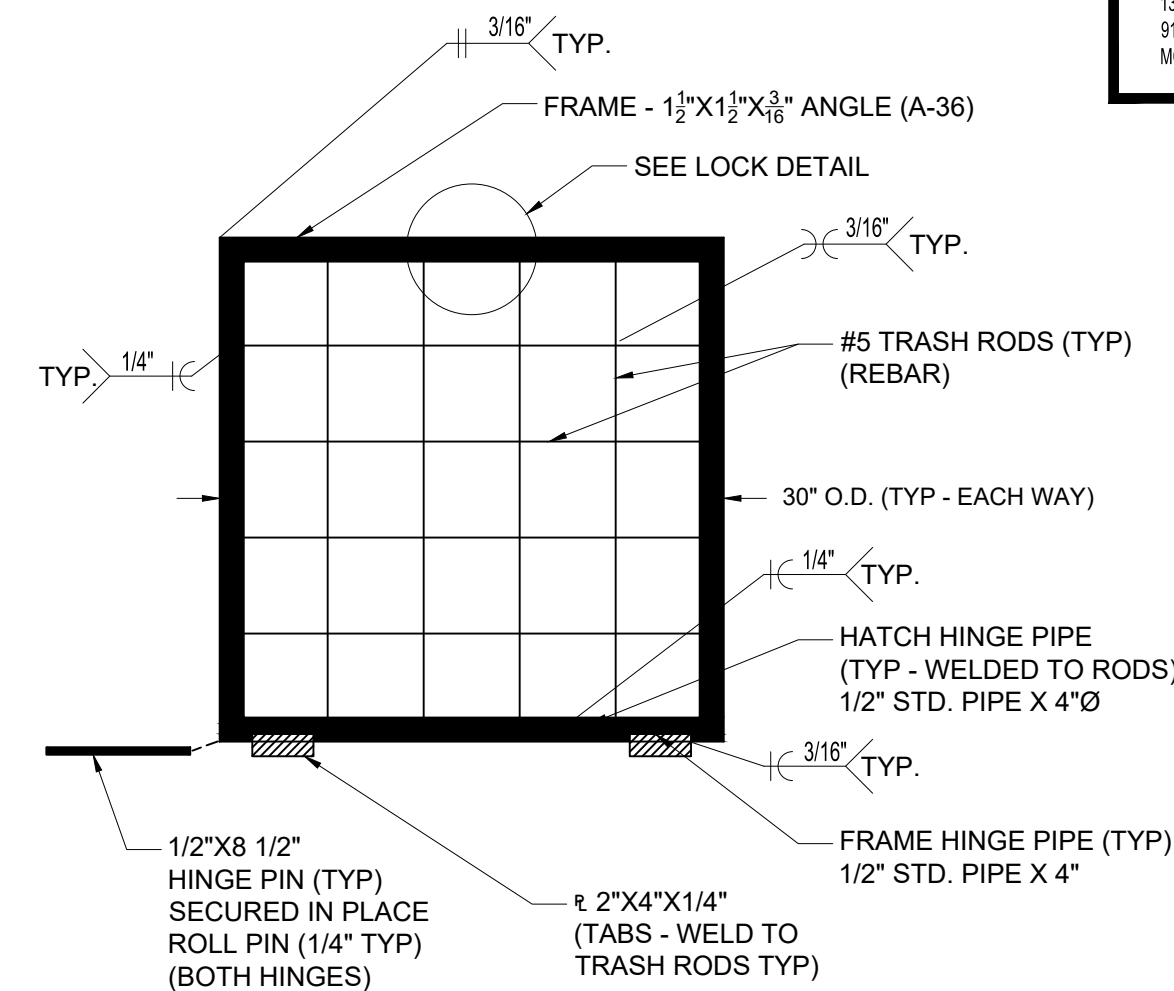SCALE: NONE




LOCKING HATCH (PLAN)

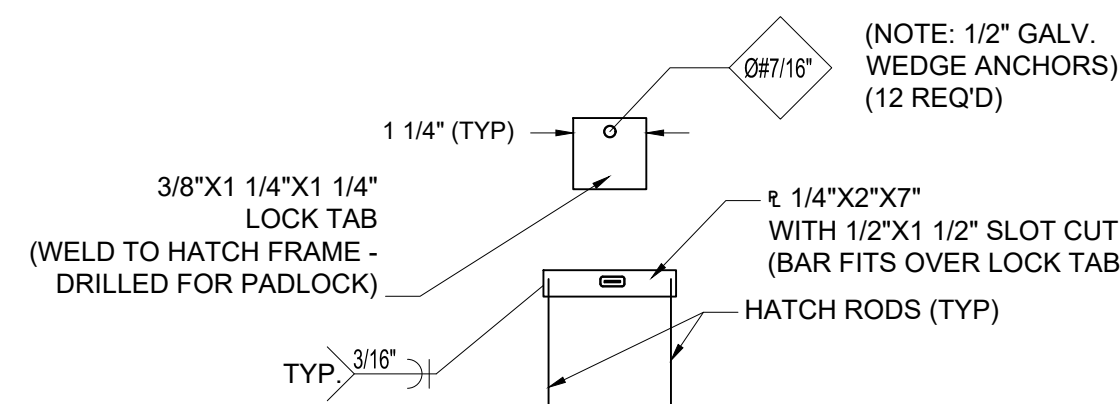SCALE: NONE




LOCK DETAIL (PLAN)

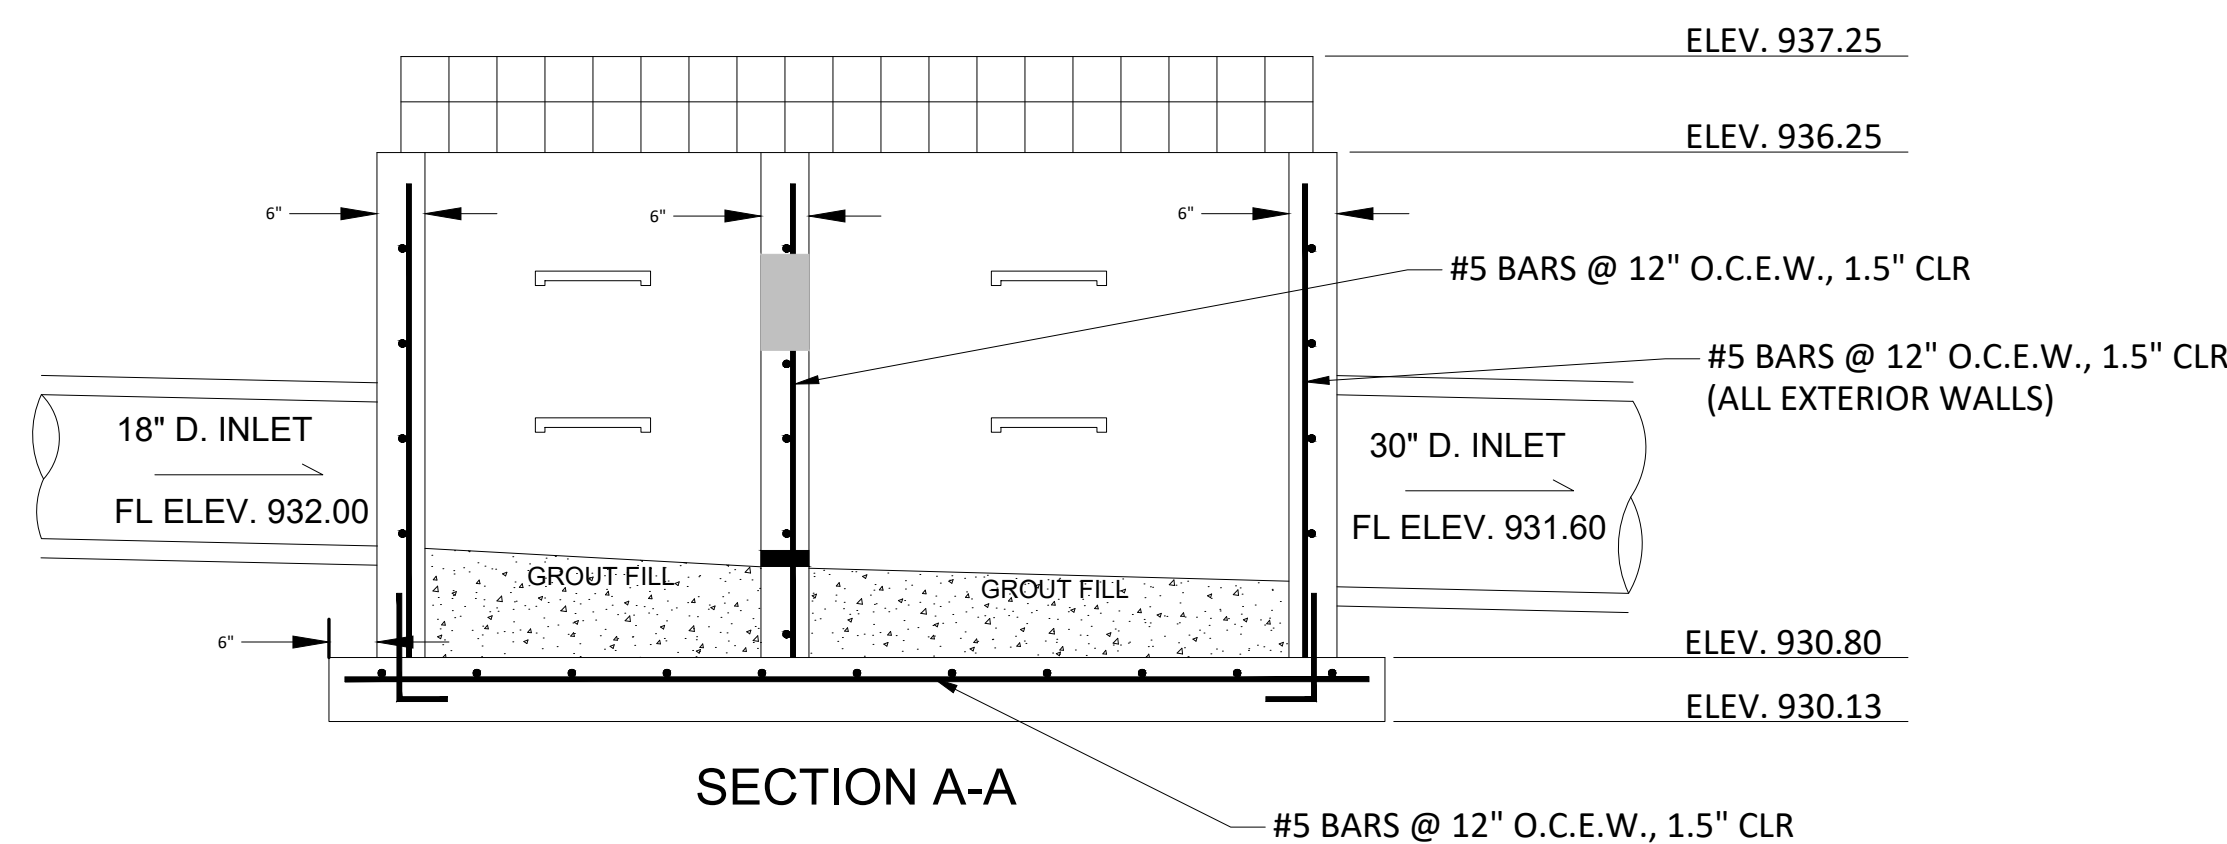SCALE: NONE




SECTION A-A

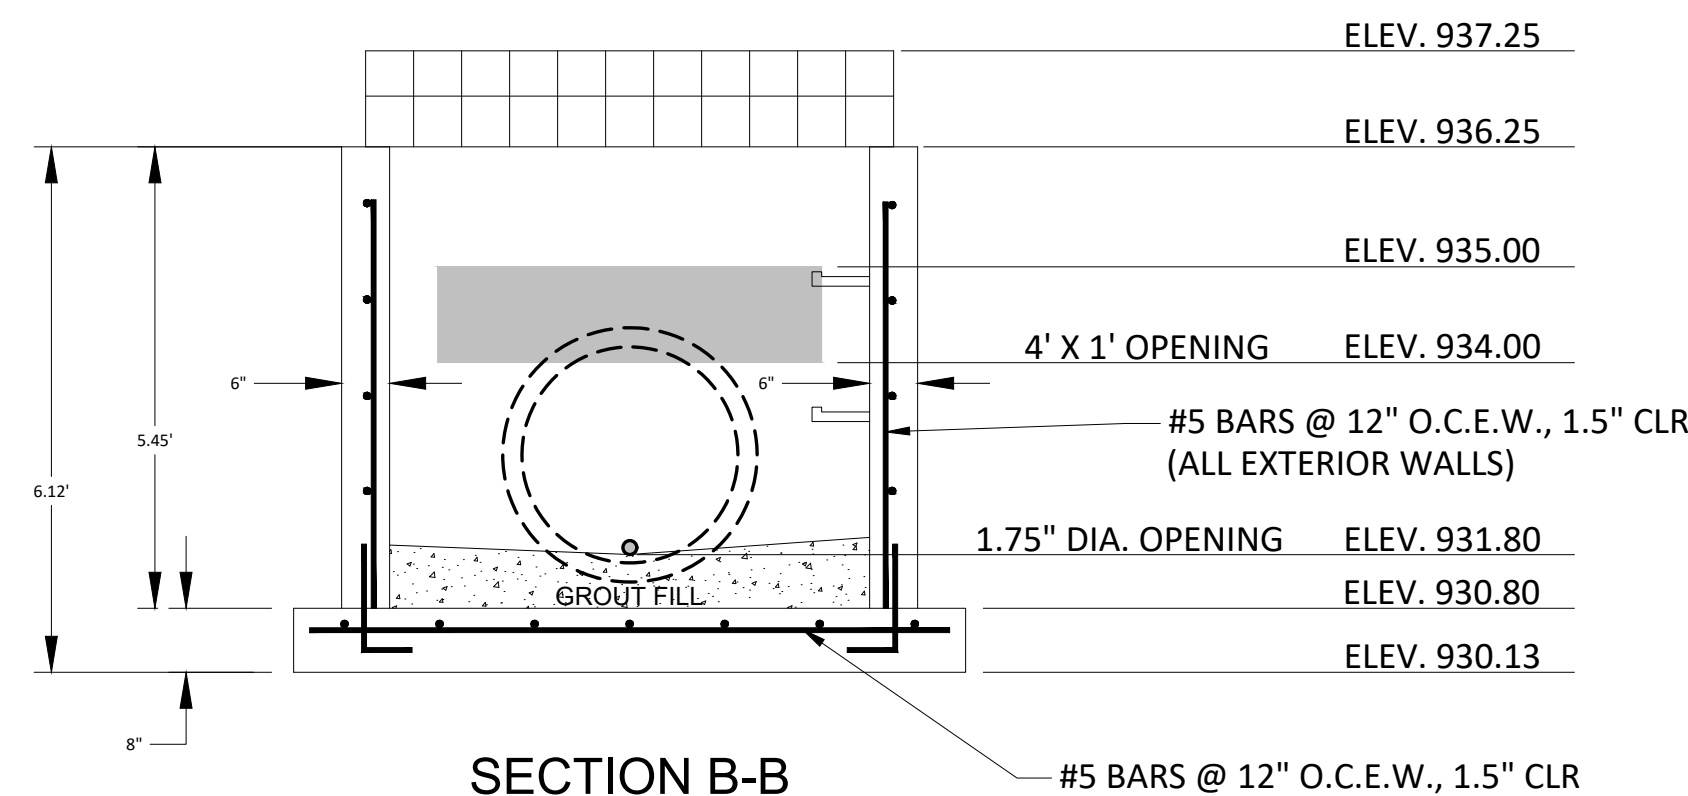

SECTION B-B

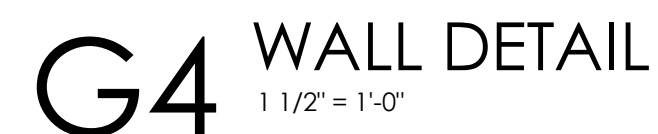
DRAINAGE BASIN A-2
D2: CONTROL STRUCTURE DETAIL
N.T.S.



- 1 OUTLINE OF BLDG BELOW
- 2 PREFINISHED MTL GUTTER; COLOR TO BE SELECTED BY ARCHITECT
- 3 PREFINISHED MTL DOWNSPOUT; COLOR TO BE SELECTED BY ARCHITECT
- 4 CONTINUOUS ROOF VENT W/ ASPHALT SHINGLES
- 5 EXHAUST FAN; REMEP



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Dalyn Novak - Architect
MO # A-2011006178
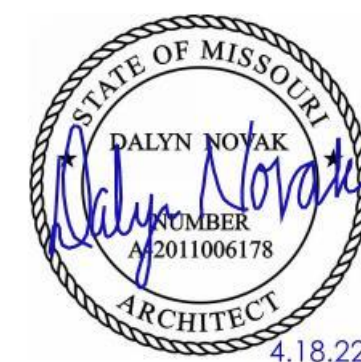
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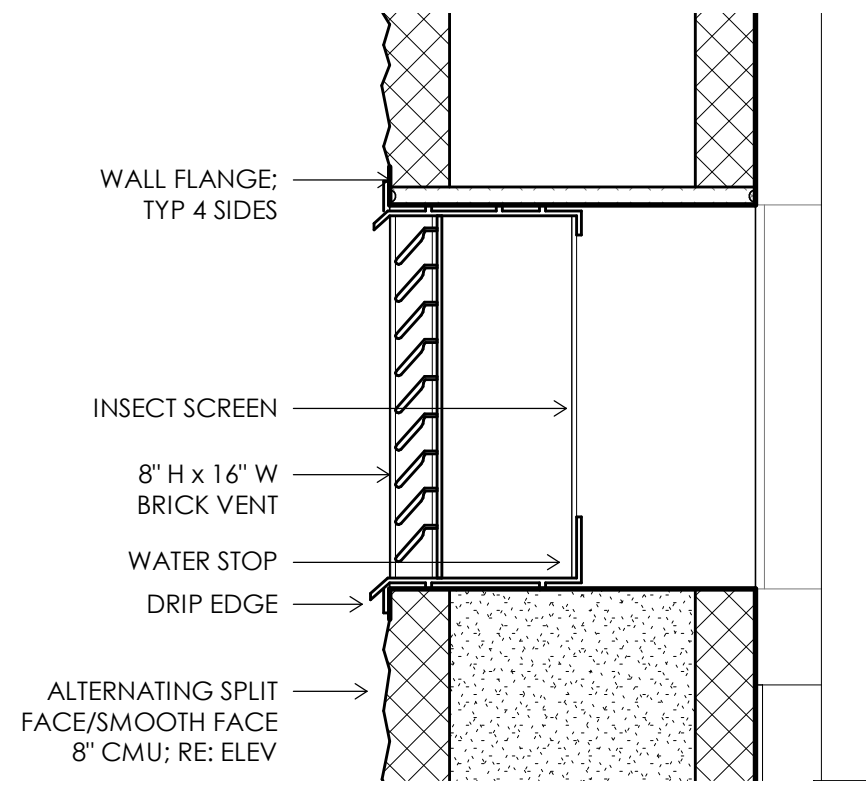
PROJECT NUMBER	SET ISSUE DATE
210266-000	04/13/2022
ENGINEER	DRAWN BY
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PLATTE RIDGE PARK - FOOTBALL
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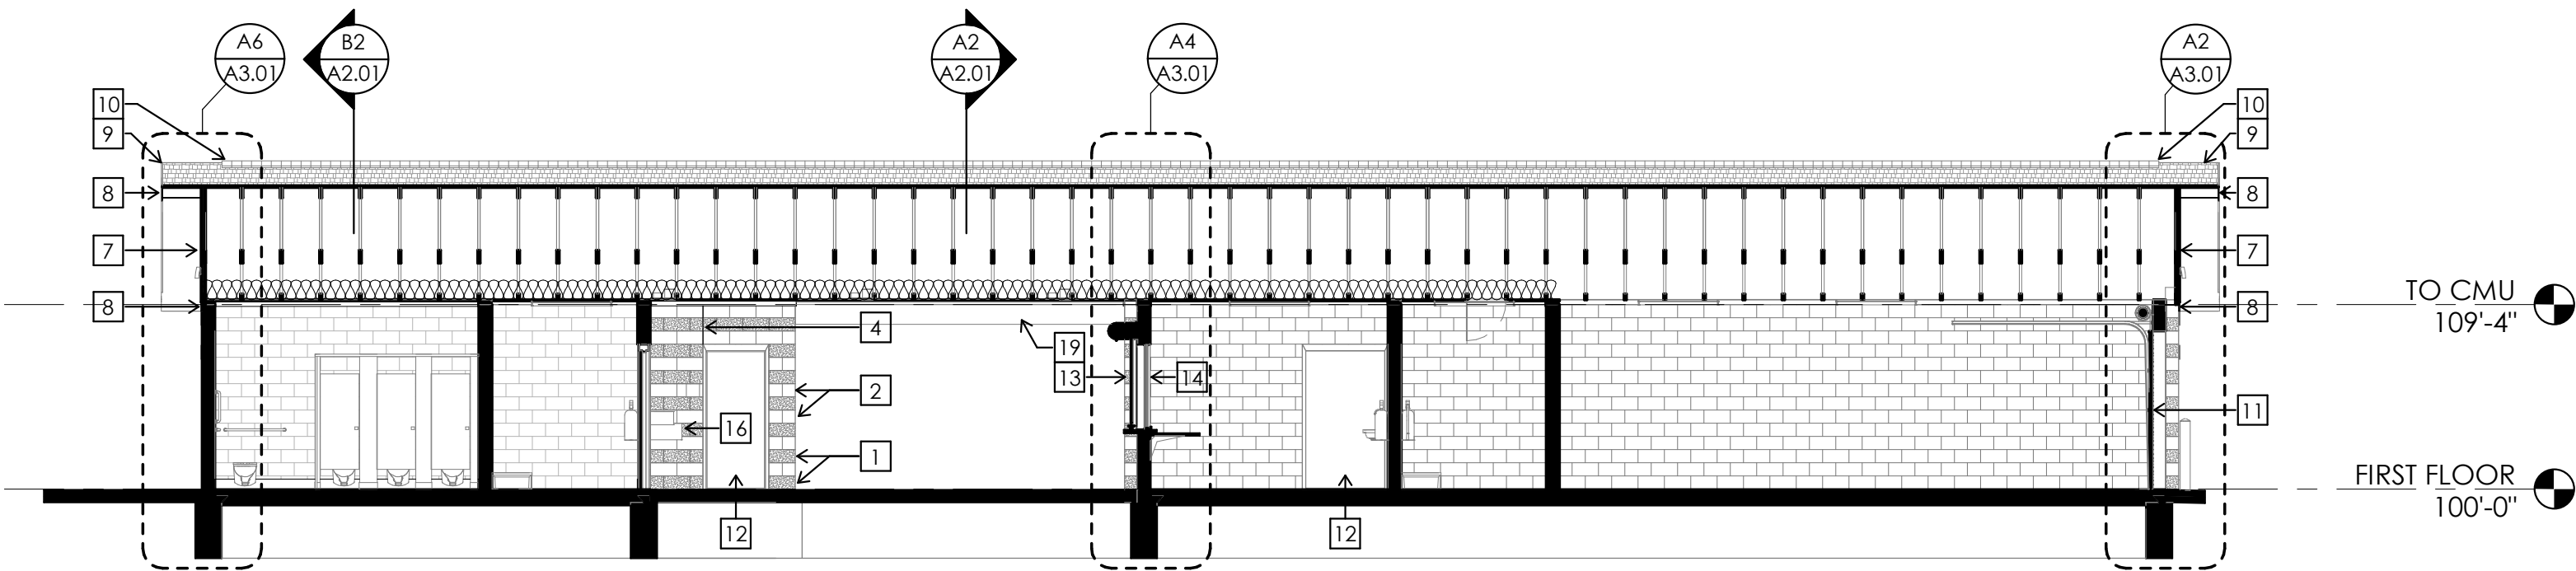
FIRST FLOOR PLAN

C:\Users\JamesLukacovic\Desktop\Revit local\21066 - Platte Ridge Park CENTRAL |lukacovic@wskfarch.com.nv

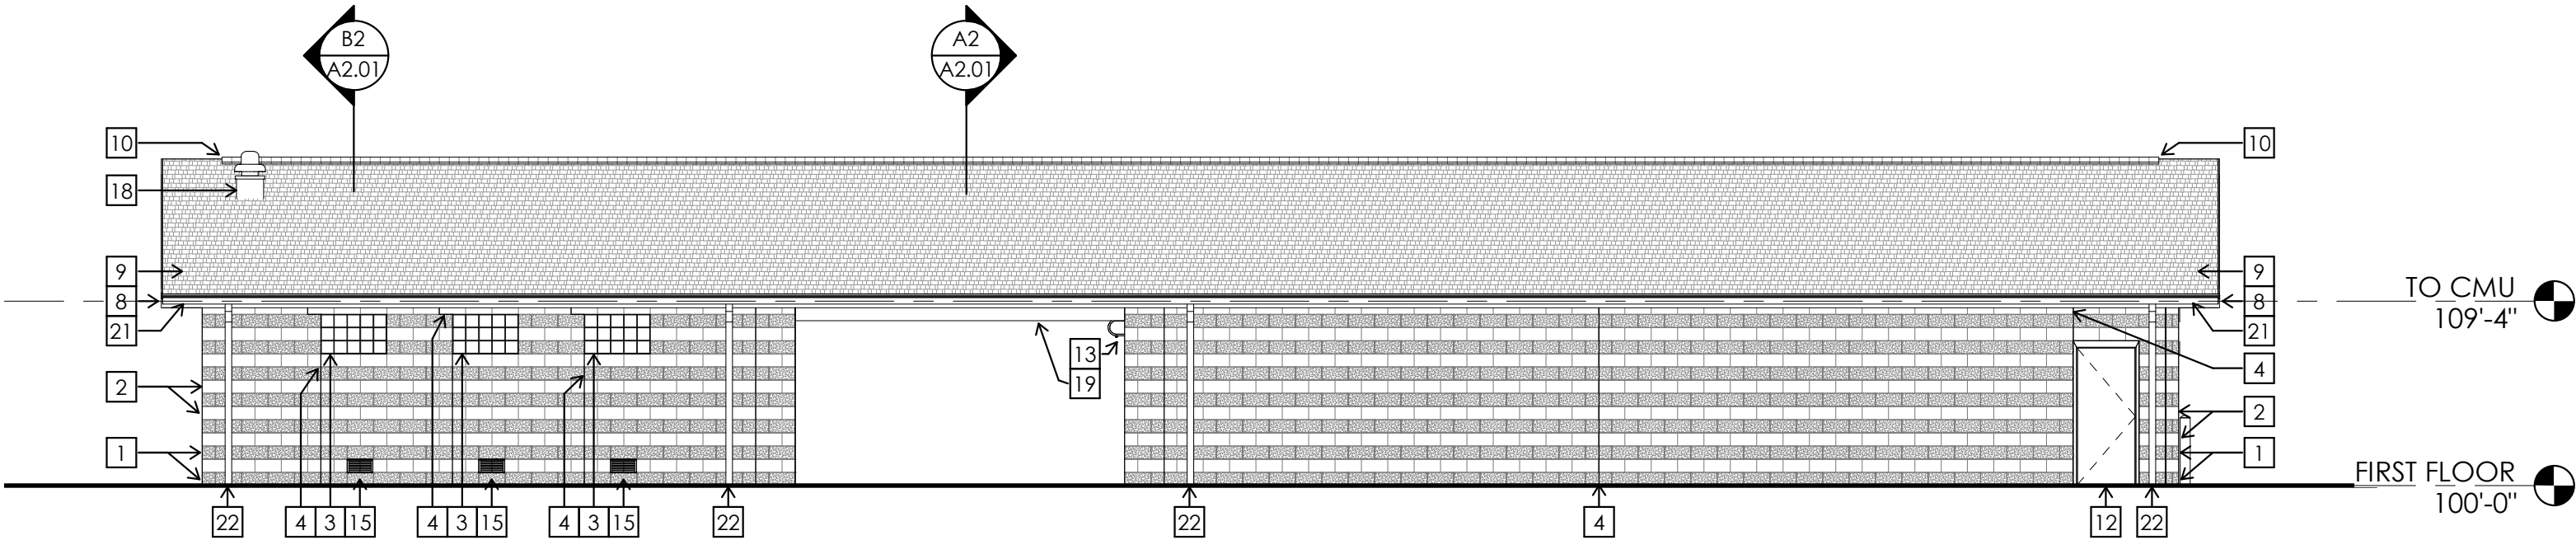
DRAWING NO
A1.01




G8 WALL DETAIL
3" = 1'-0"




D10 Section N/S
1/8" = 1'-0"




B10 Exterior - West
1/8" = 1'-0"

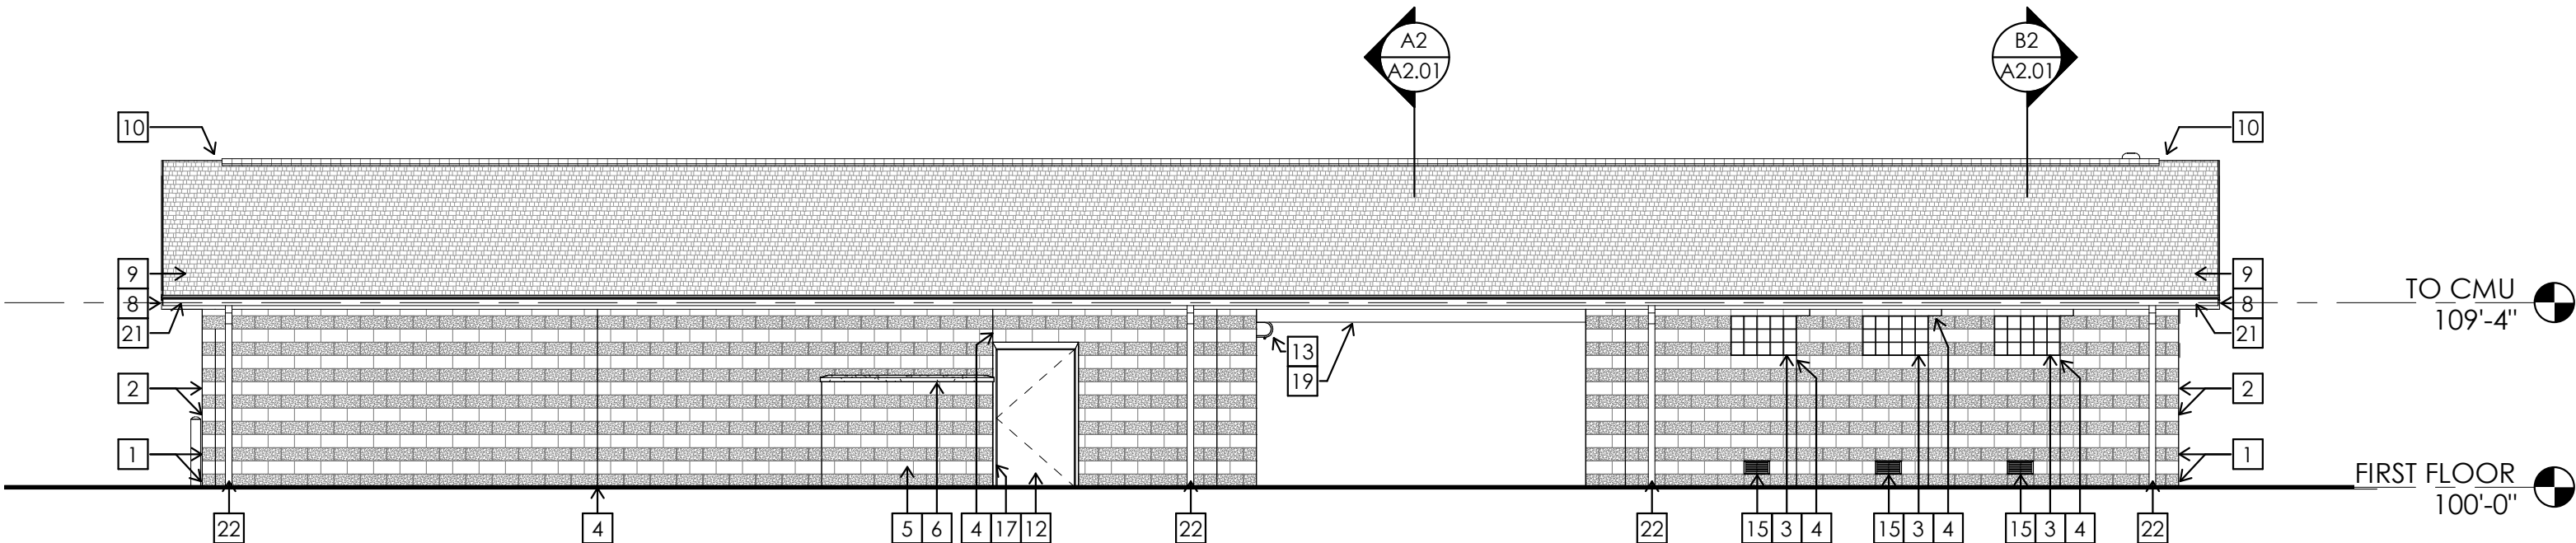


A10 Exterior - East
1/8" = 1'-0"

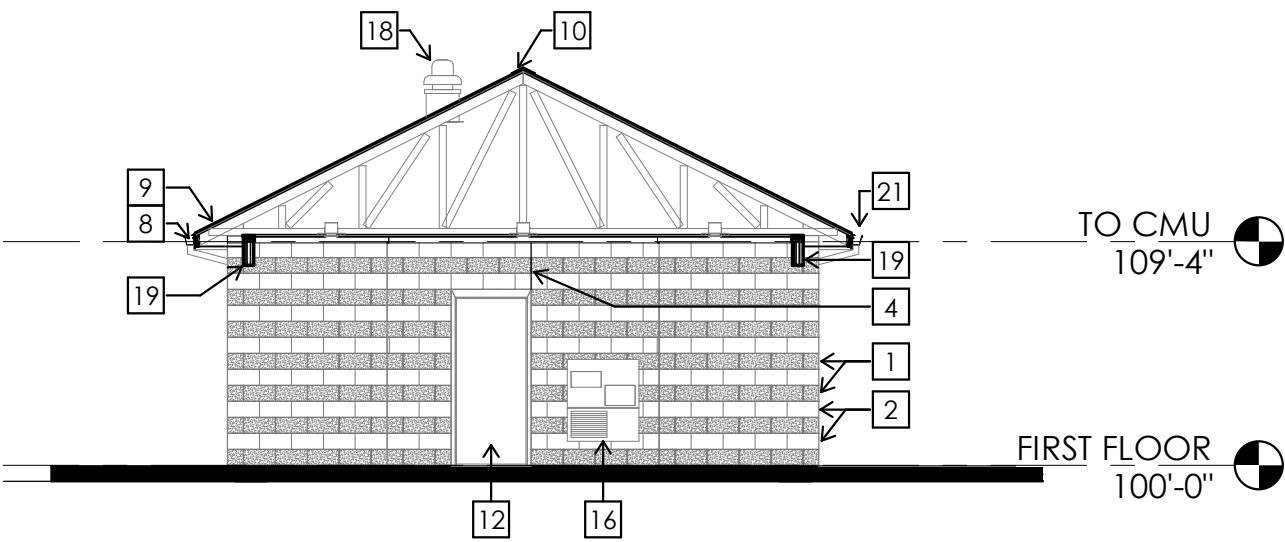

D5 102 - S
1/8" = 1'-0"

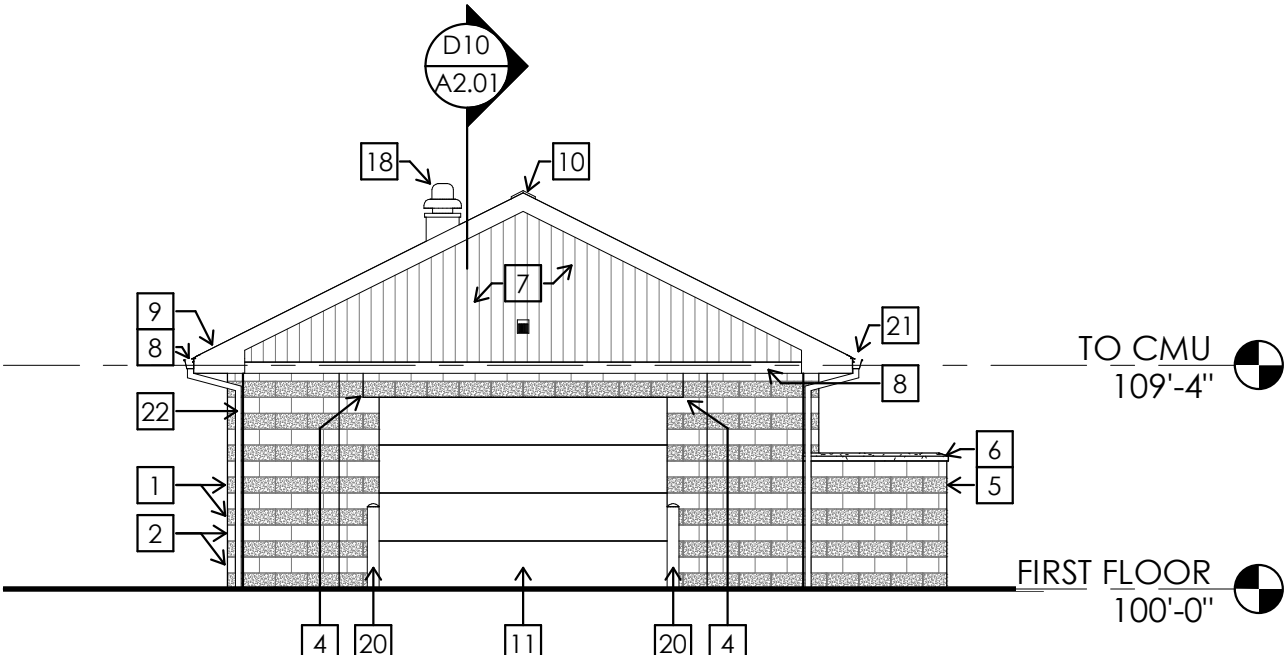

B5 Exterior - South
1/8" = 1'-0"

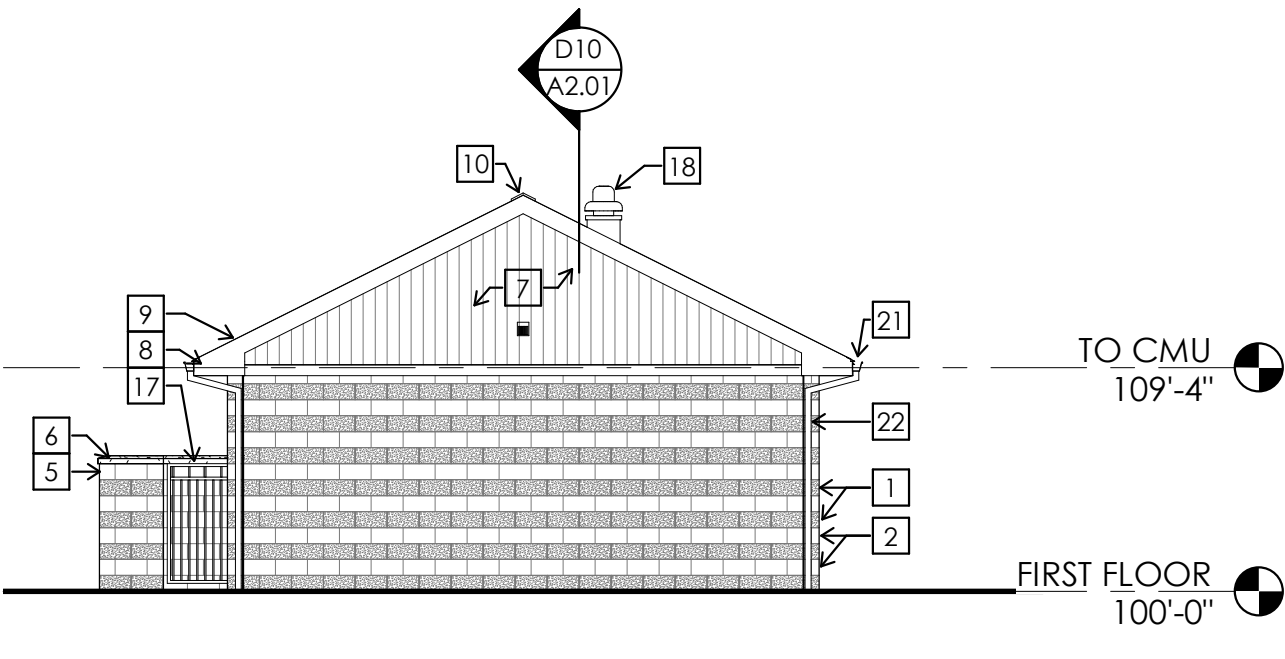


A5 Exterior - North
1/8" = 1'-0"

GENERAL NOTES:


1. CONTRACTOR SHALL BE RESPONSIBLE FOR VERIFYING ALL DIMENSIONS AND EXISTING CONDITIONS. ANY DISCREPANCIES WHICH WILL PREVENT THE ACCOMPLISHMENT OF INTENT SHOWN ON DRAWINGS SHALL BE BROUGHT TO THE IMMEDIATE ATTENTION OF THE ARCHITECT.
2. WHERE A CONDITION IS NOTED 'TYPICAL' (TYP.), IT IS UNDERSTOOD THAT ALL SIMILAR CONDITIONS BE CONSTRUCTED OF THE SAME MATERIALS AND/OR DIMENSIONS.

ELEVATION NOTES:

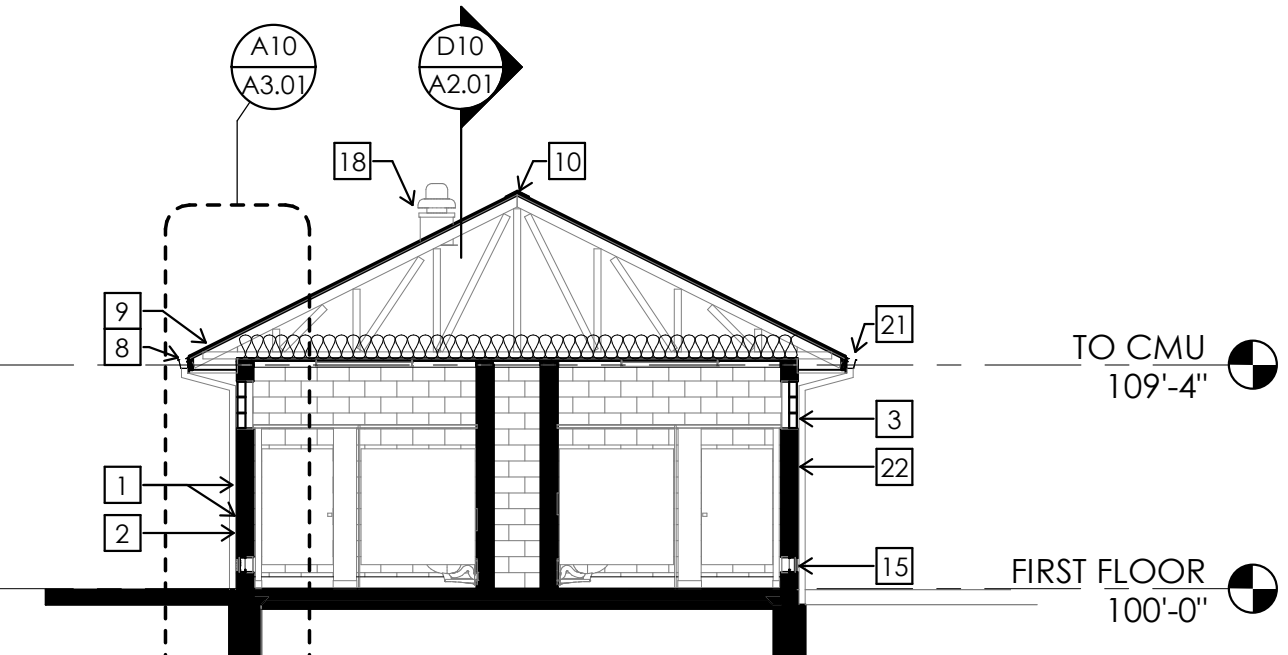- 1 8" SPLIT FACE CMU; COLOR TO MATCH EXISTING BUILDINGS; ARCHITECT TO MAKE SELECTION FROM MANUFACTURER'S FULL RANGE OF COLORS
- 2 8" SMOOTH FACE CMU; COLOR TO MATCH EXISTING BUILDINGS; ARCHITECT TO MAKE SELECTION FROM MANUFACTURER'S FULL RANGE OF COLORS
- 3 8"x8"x4" GLASS MASONRY UNIT
- 4 CMU CONTROL JOINT
- 5 CMU SCREEN WALL
- 6 CAST STONE CAP; COLOR TO MATCH EXISTING; ARCHITECT TO MAKE SELECTION FROM MANUFACTURER'S FULL RANGE OF COLORS
- 7 FIBER CEMENT SIDING; PAINT, COLOR: MATCH EXISTING BUILDING
- 8 FIBER CEMENT FASCIA/TRIM; PAINT COLOR: MATCH EXISTING BUILDING
- 9 ASPHALT COMPOSITION SHINGLES
- 10 RIDGE VENT
- 11 PREFINISHED OVERHEAD DOOR; ARCHITECT TO MAKE SELECTION FROM MANUFACTURER'S FULL RANGE OF COLORS
- 12 HM DOOR AND FRAME; PAINT, COLOR: MATCH EXISTING BUILDING
- 13 COILING COUNTER DOOR W/ STAINLESS STEEL TRANSACTION COUNTER
- 14 SLIDING TRANSACTION WINDOW W/ CLEAR ANNOIDIZED ALUMINUM FRAME
- 15 8x16 LOUVER W/ INSECT SCREEN; PAINT, COLOR: MATCH ADJACENT WALL RE: G8/A3.01
- 16 DRINKING FOUNTAIN; RE: MEP
- 17 STEEL GATE AND LATCH; COLOR: BLACK
- 18 EXHAUST FAN; RE: MEP
- 19 LVL BEAM; RE: STRUCTURAL
- 20 6" STL BOLLARD W/ CAP; RE: E4/A1.01
- 21 PREFINISHED MTL GUTTER; COLOR TO BE SELECTED BY ARCHITECT
- 22 PREFINISHED MTL DOWNSPOUT; COLOR TO BE SELECTED BY ARCHITECT



B2 Section E/W
1/8" = 1'-0"

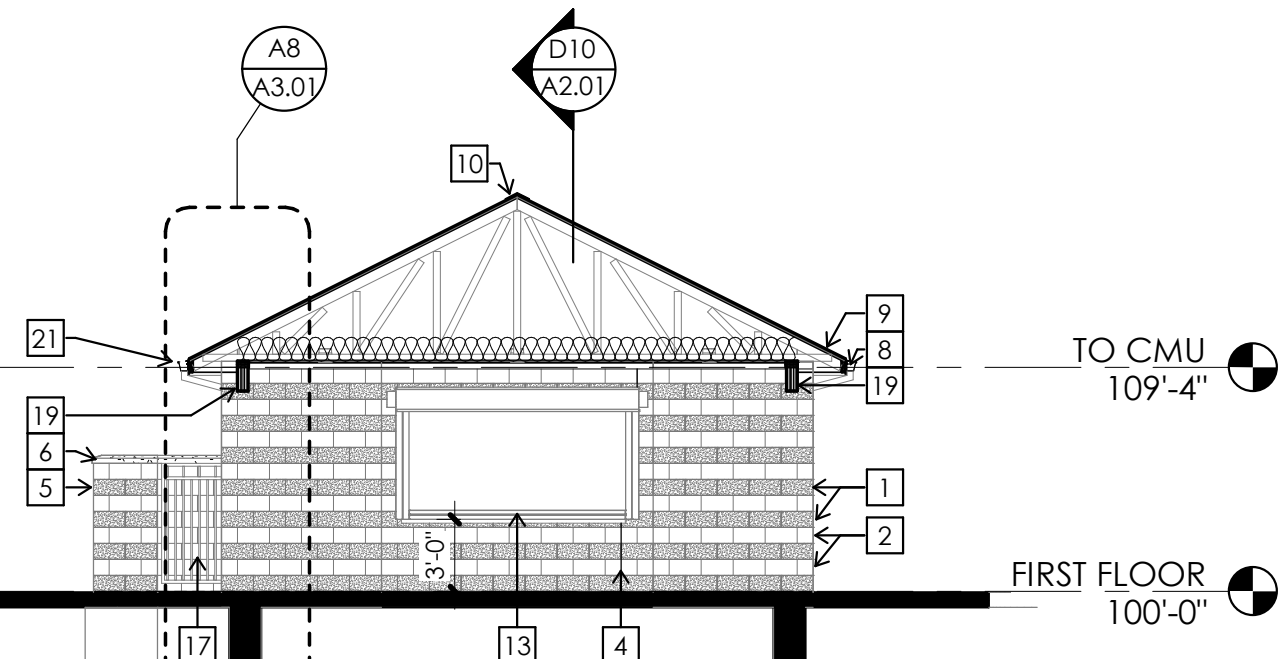

A2 Section E/W
1/8" = 1'-0"

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Dalyn Novak - Architect
MO # A-2011006178

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No.	Description	Date

PROJECT NUMBER
210266-000

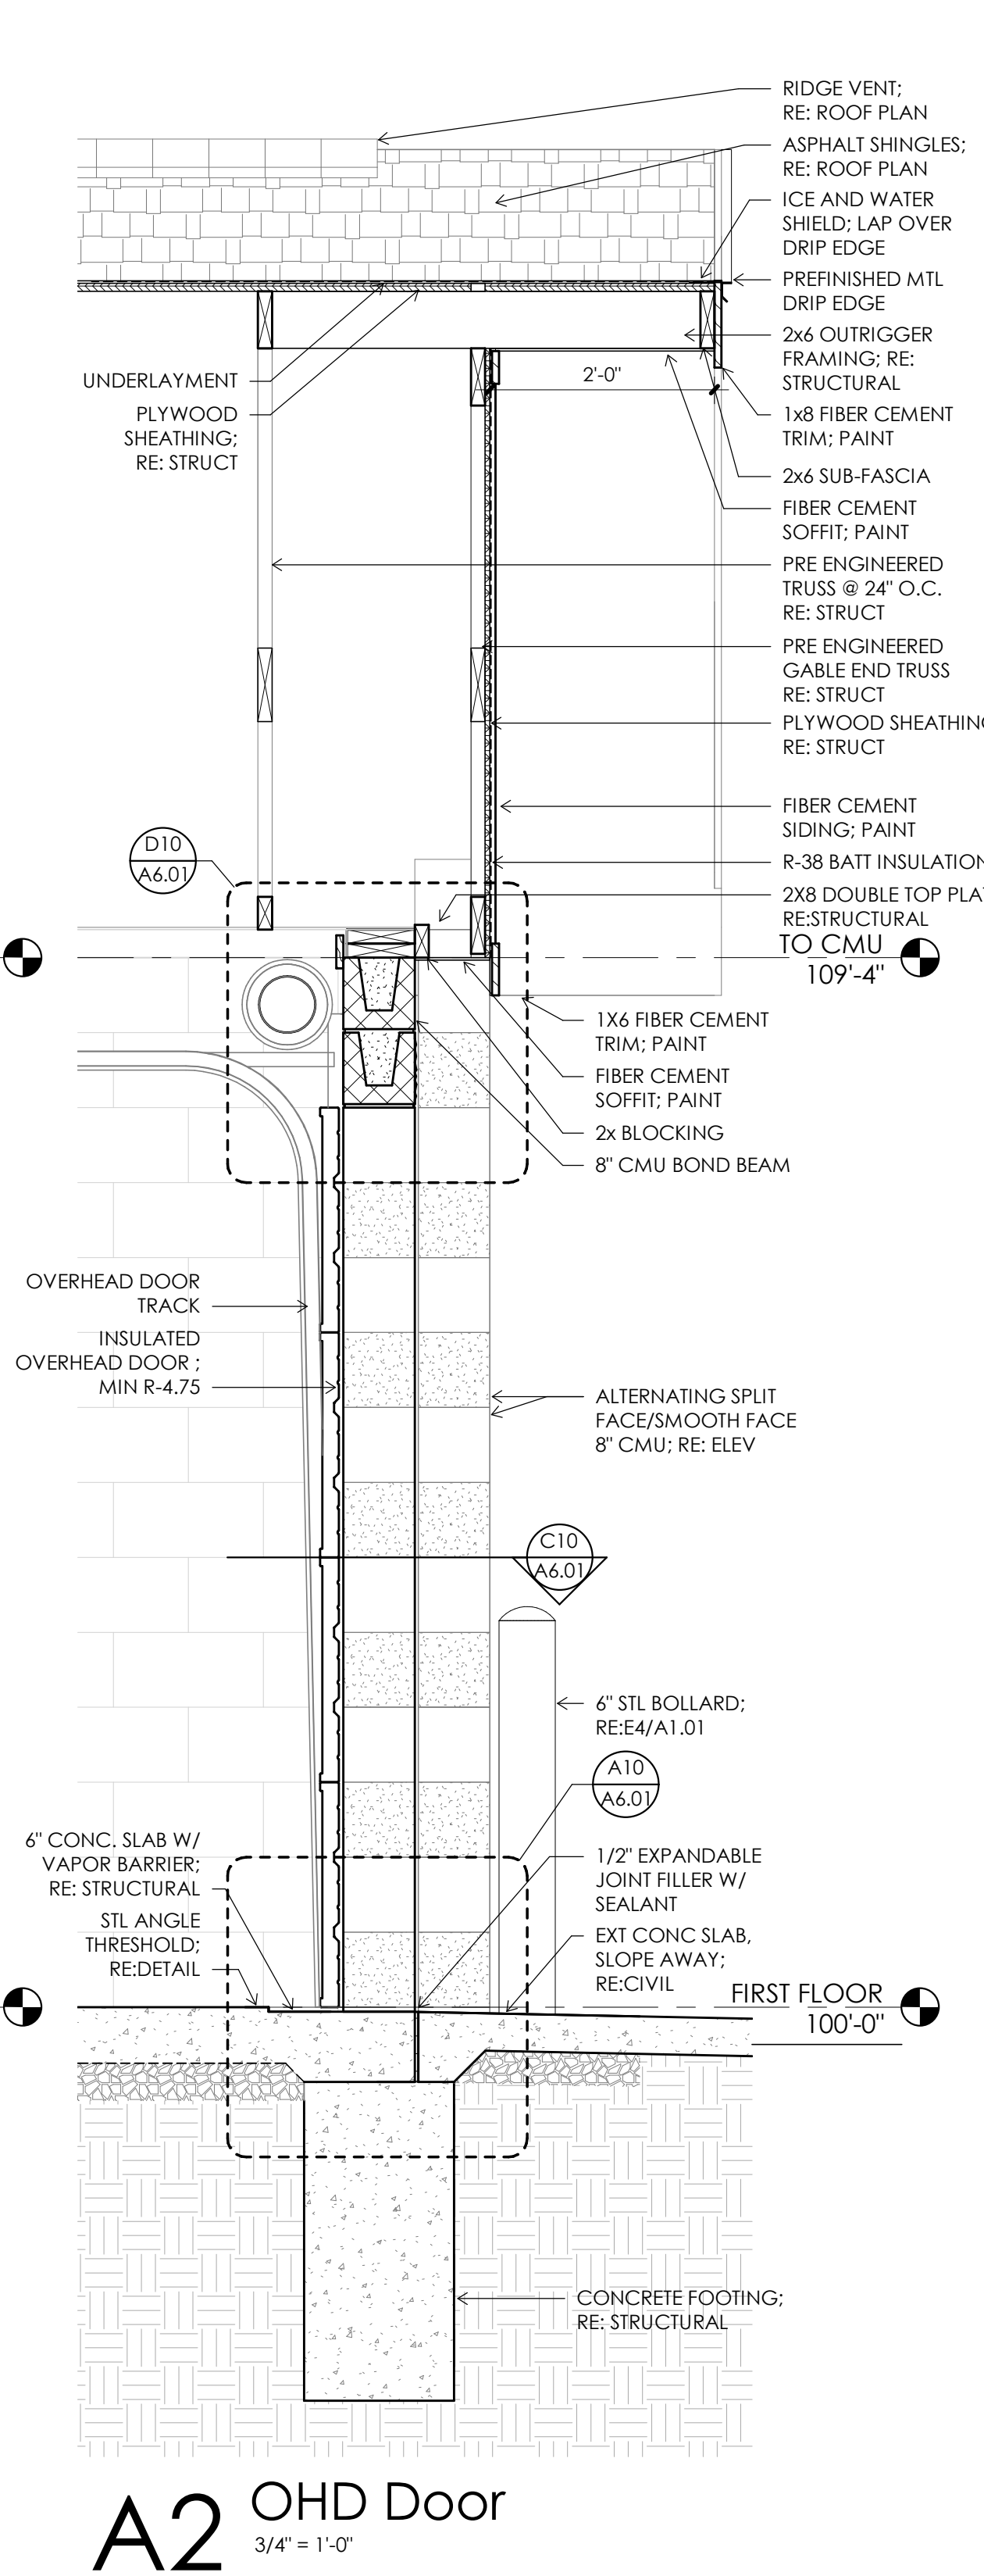
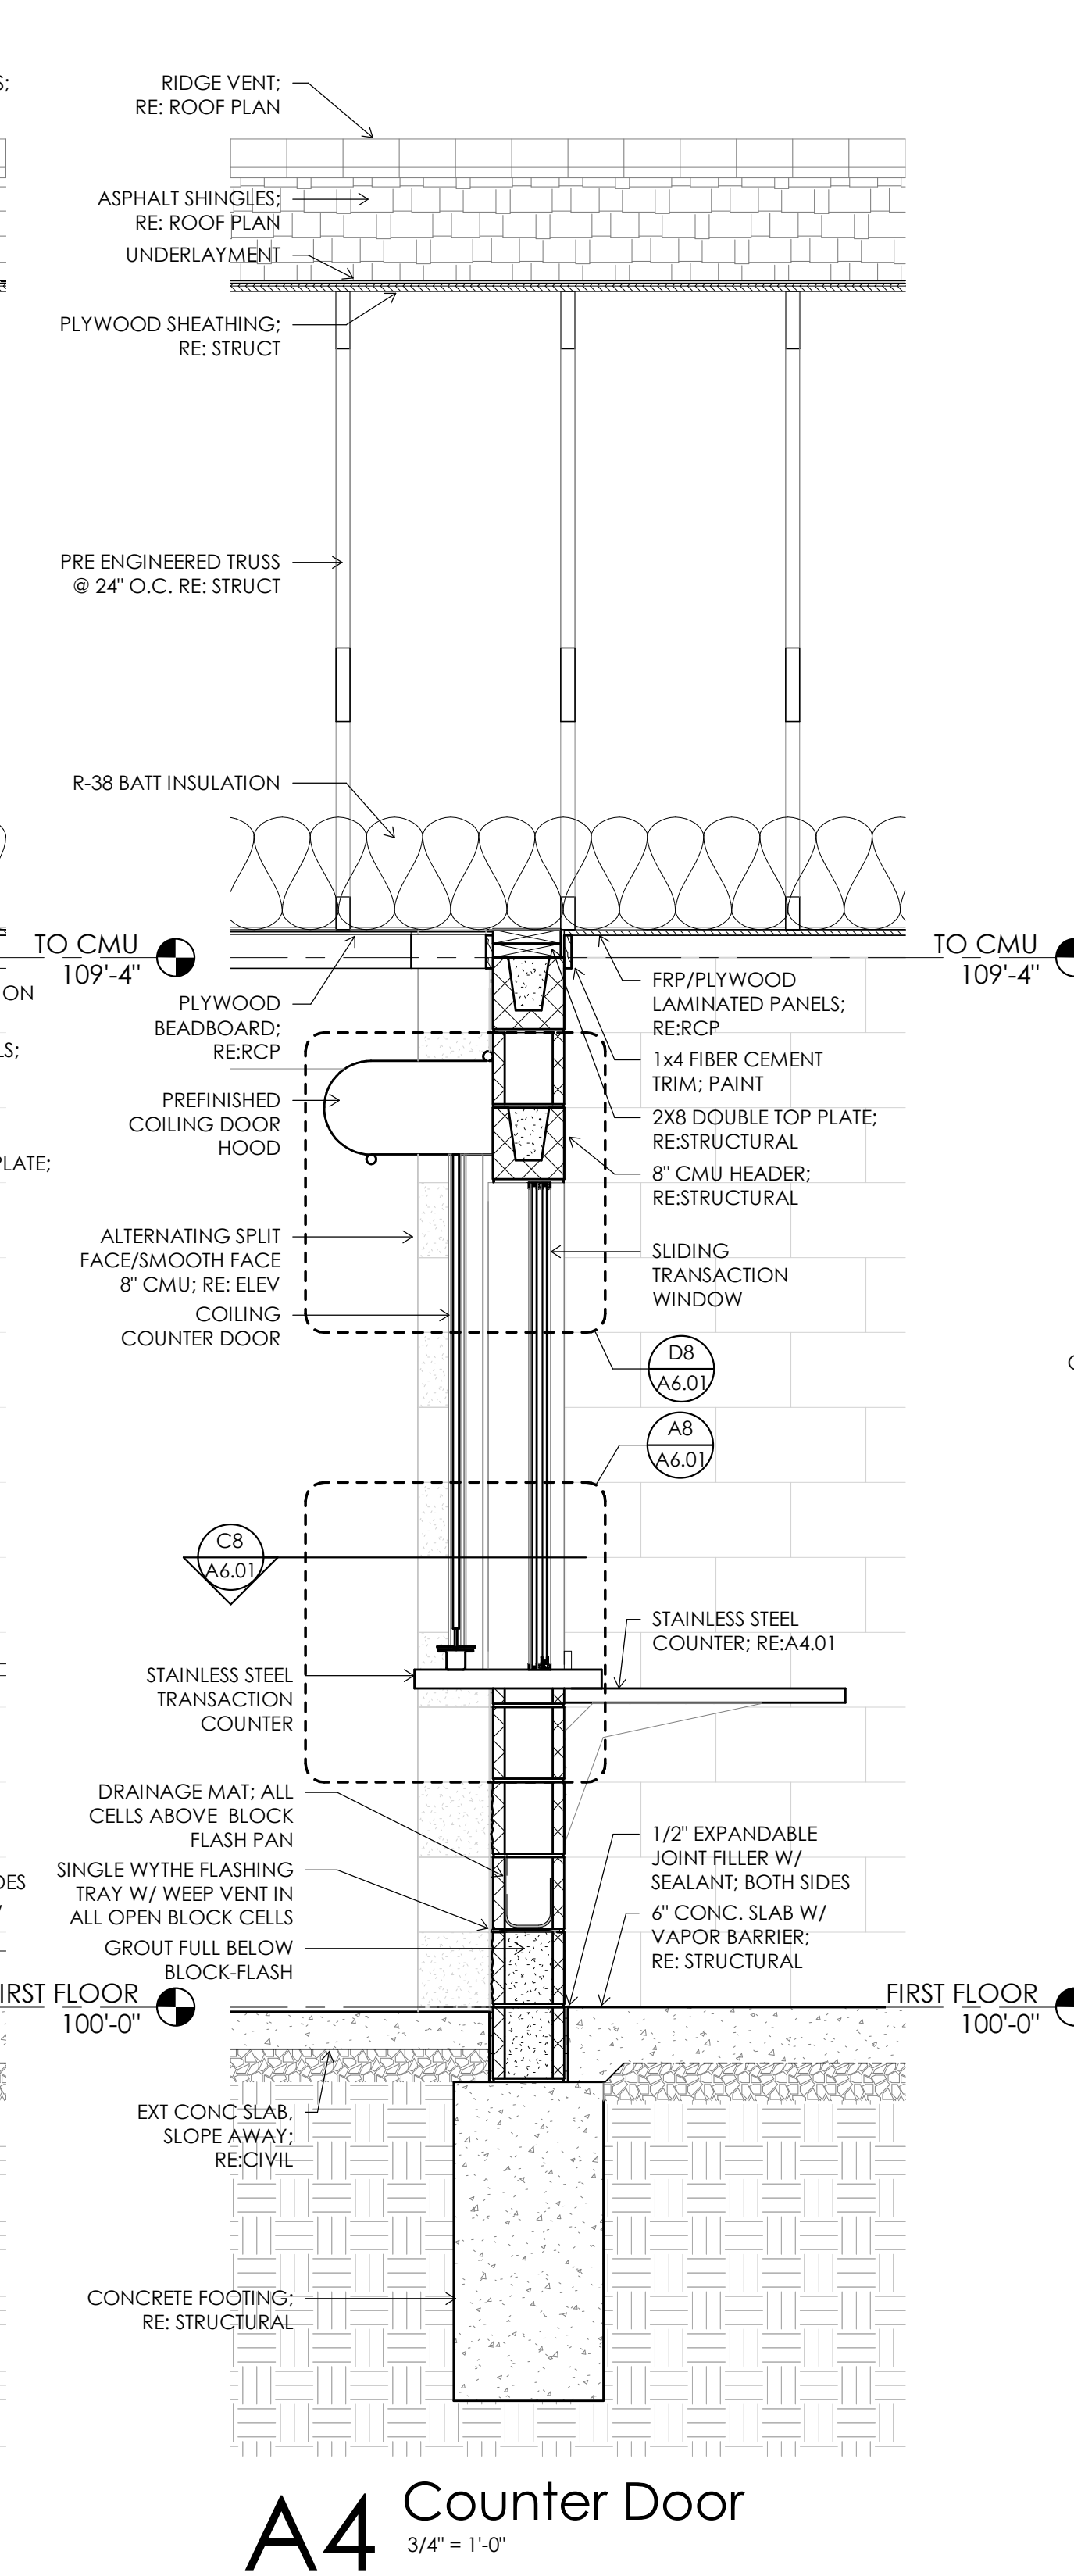
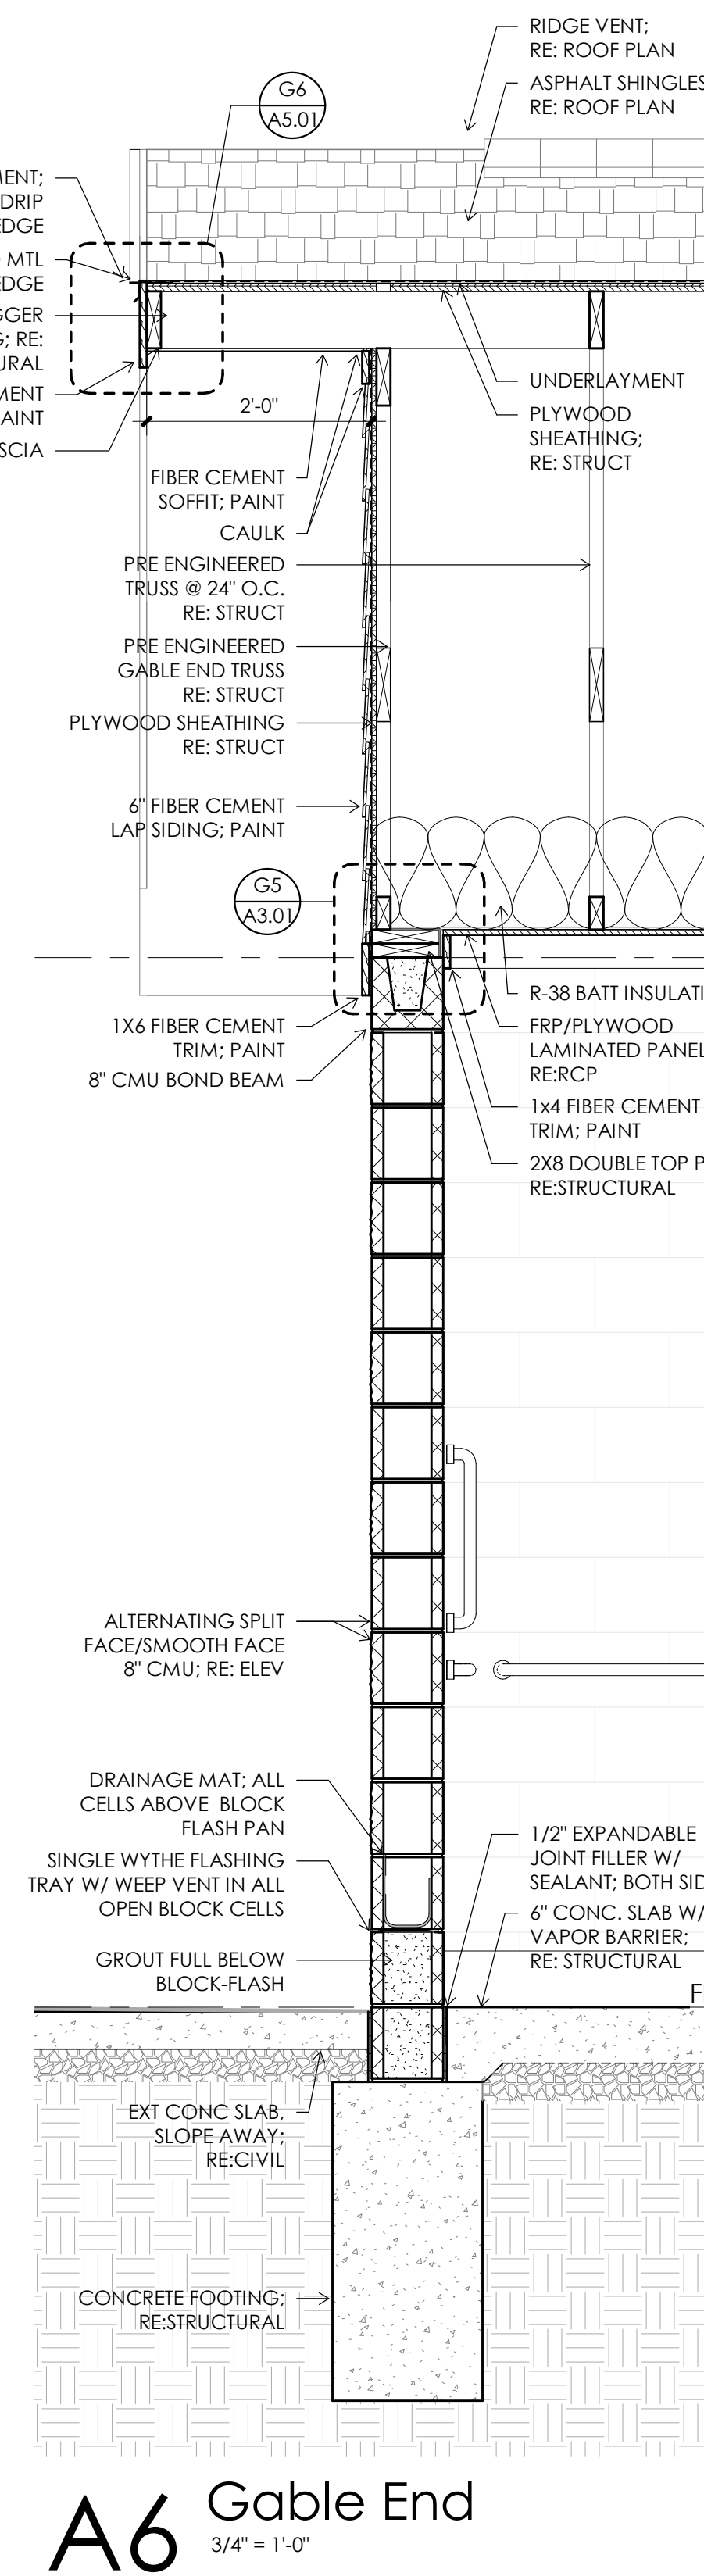
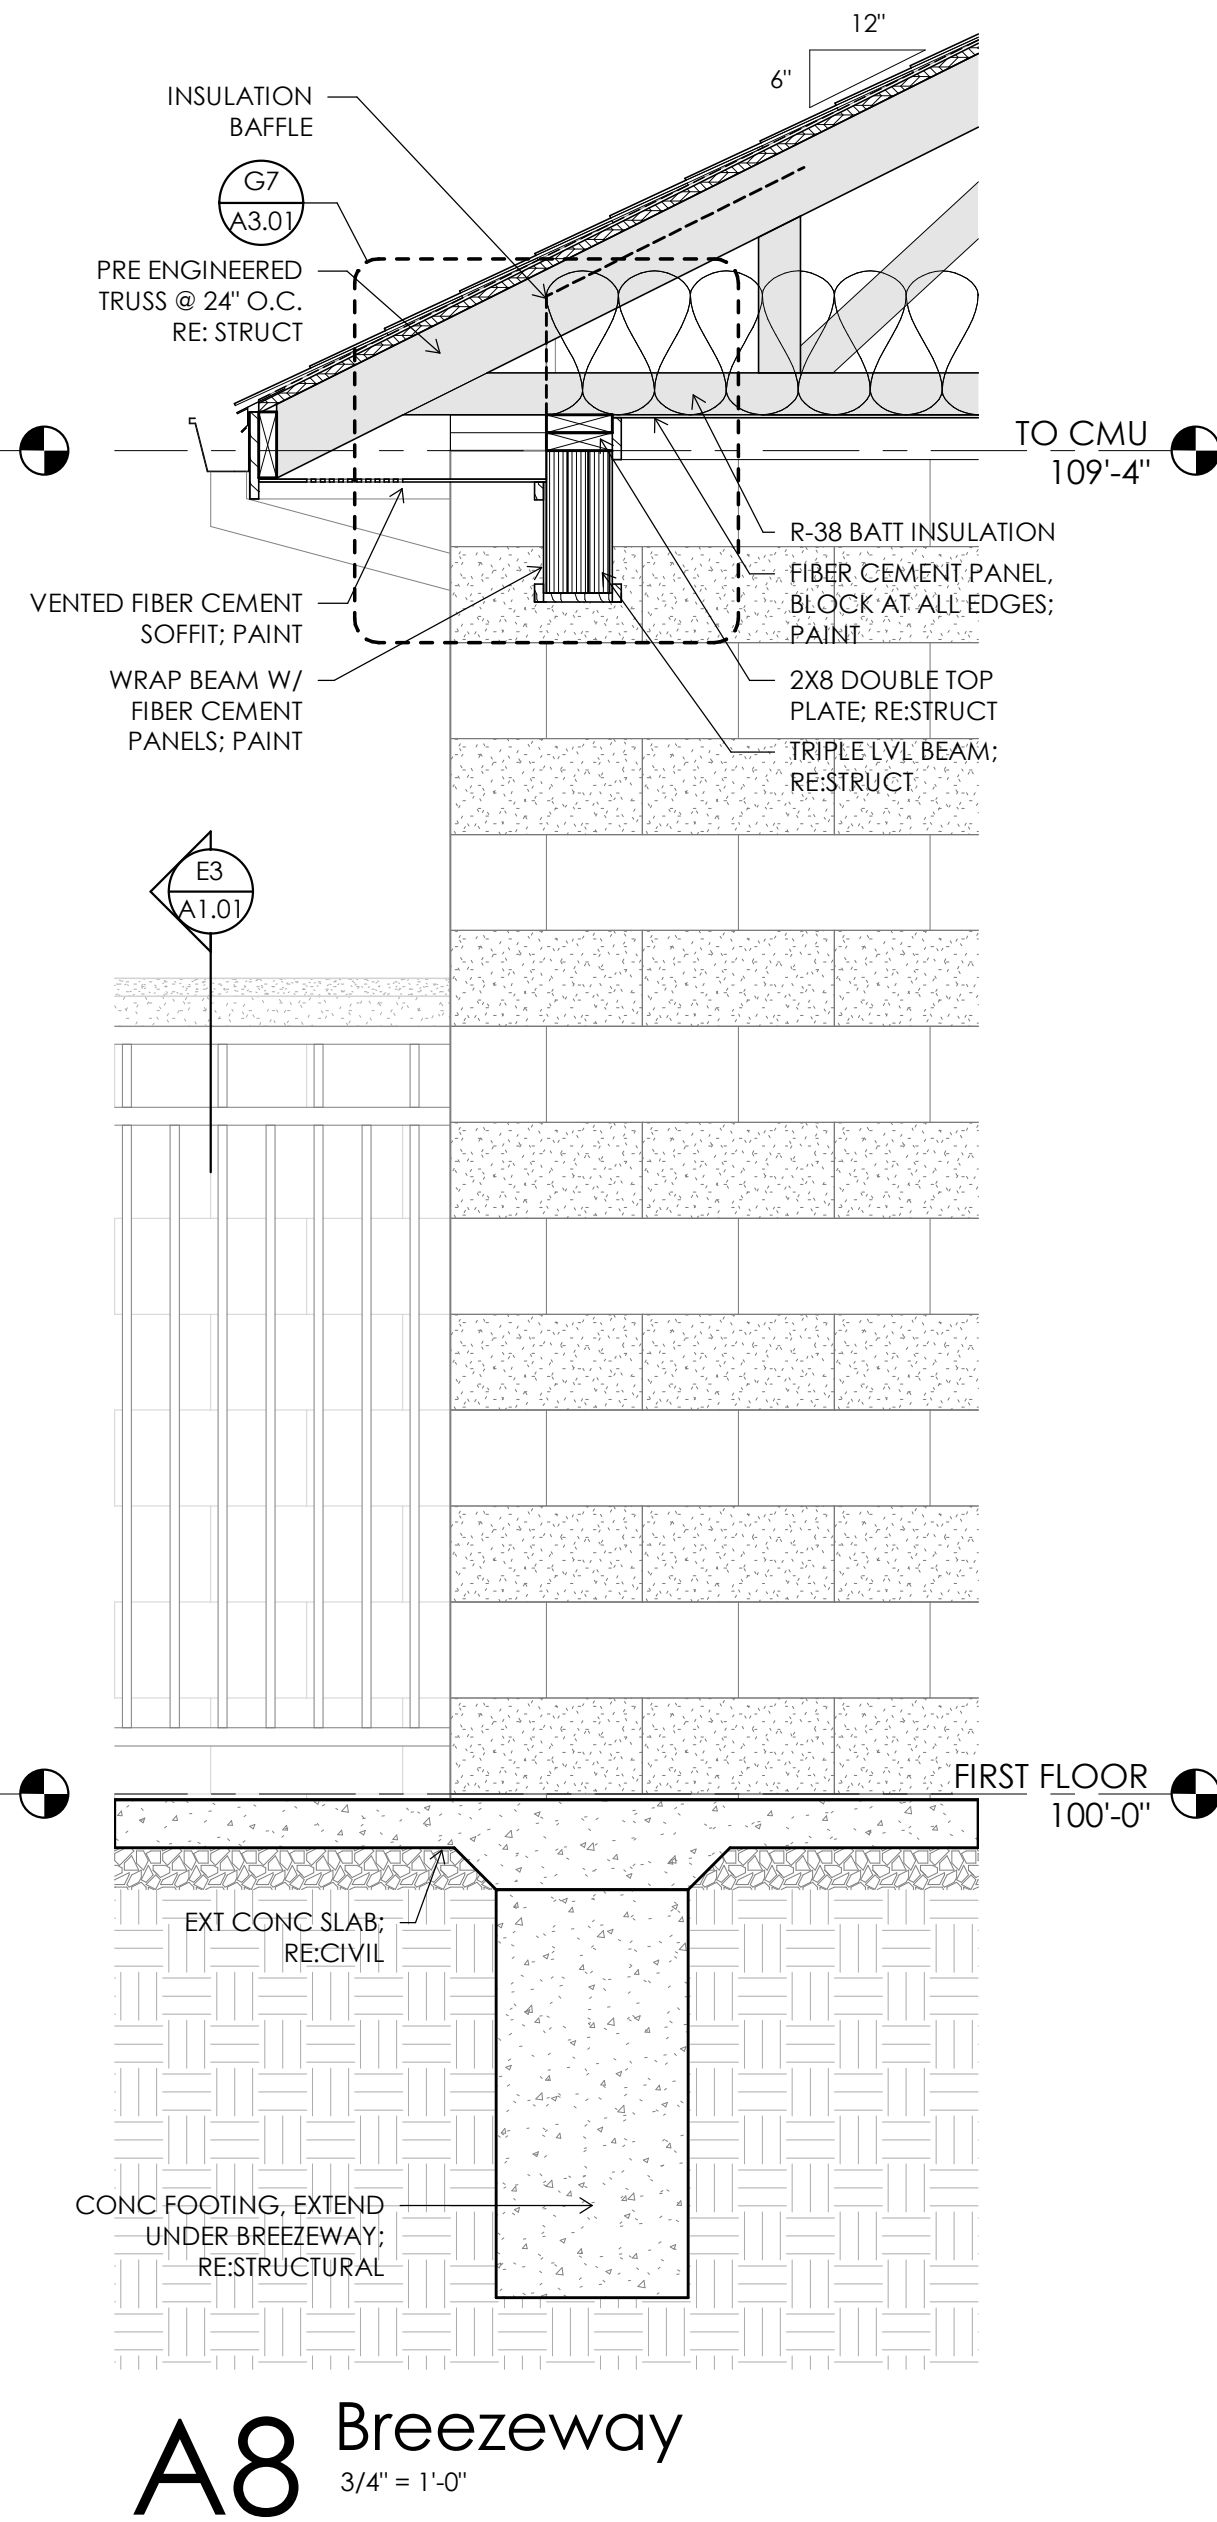
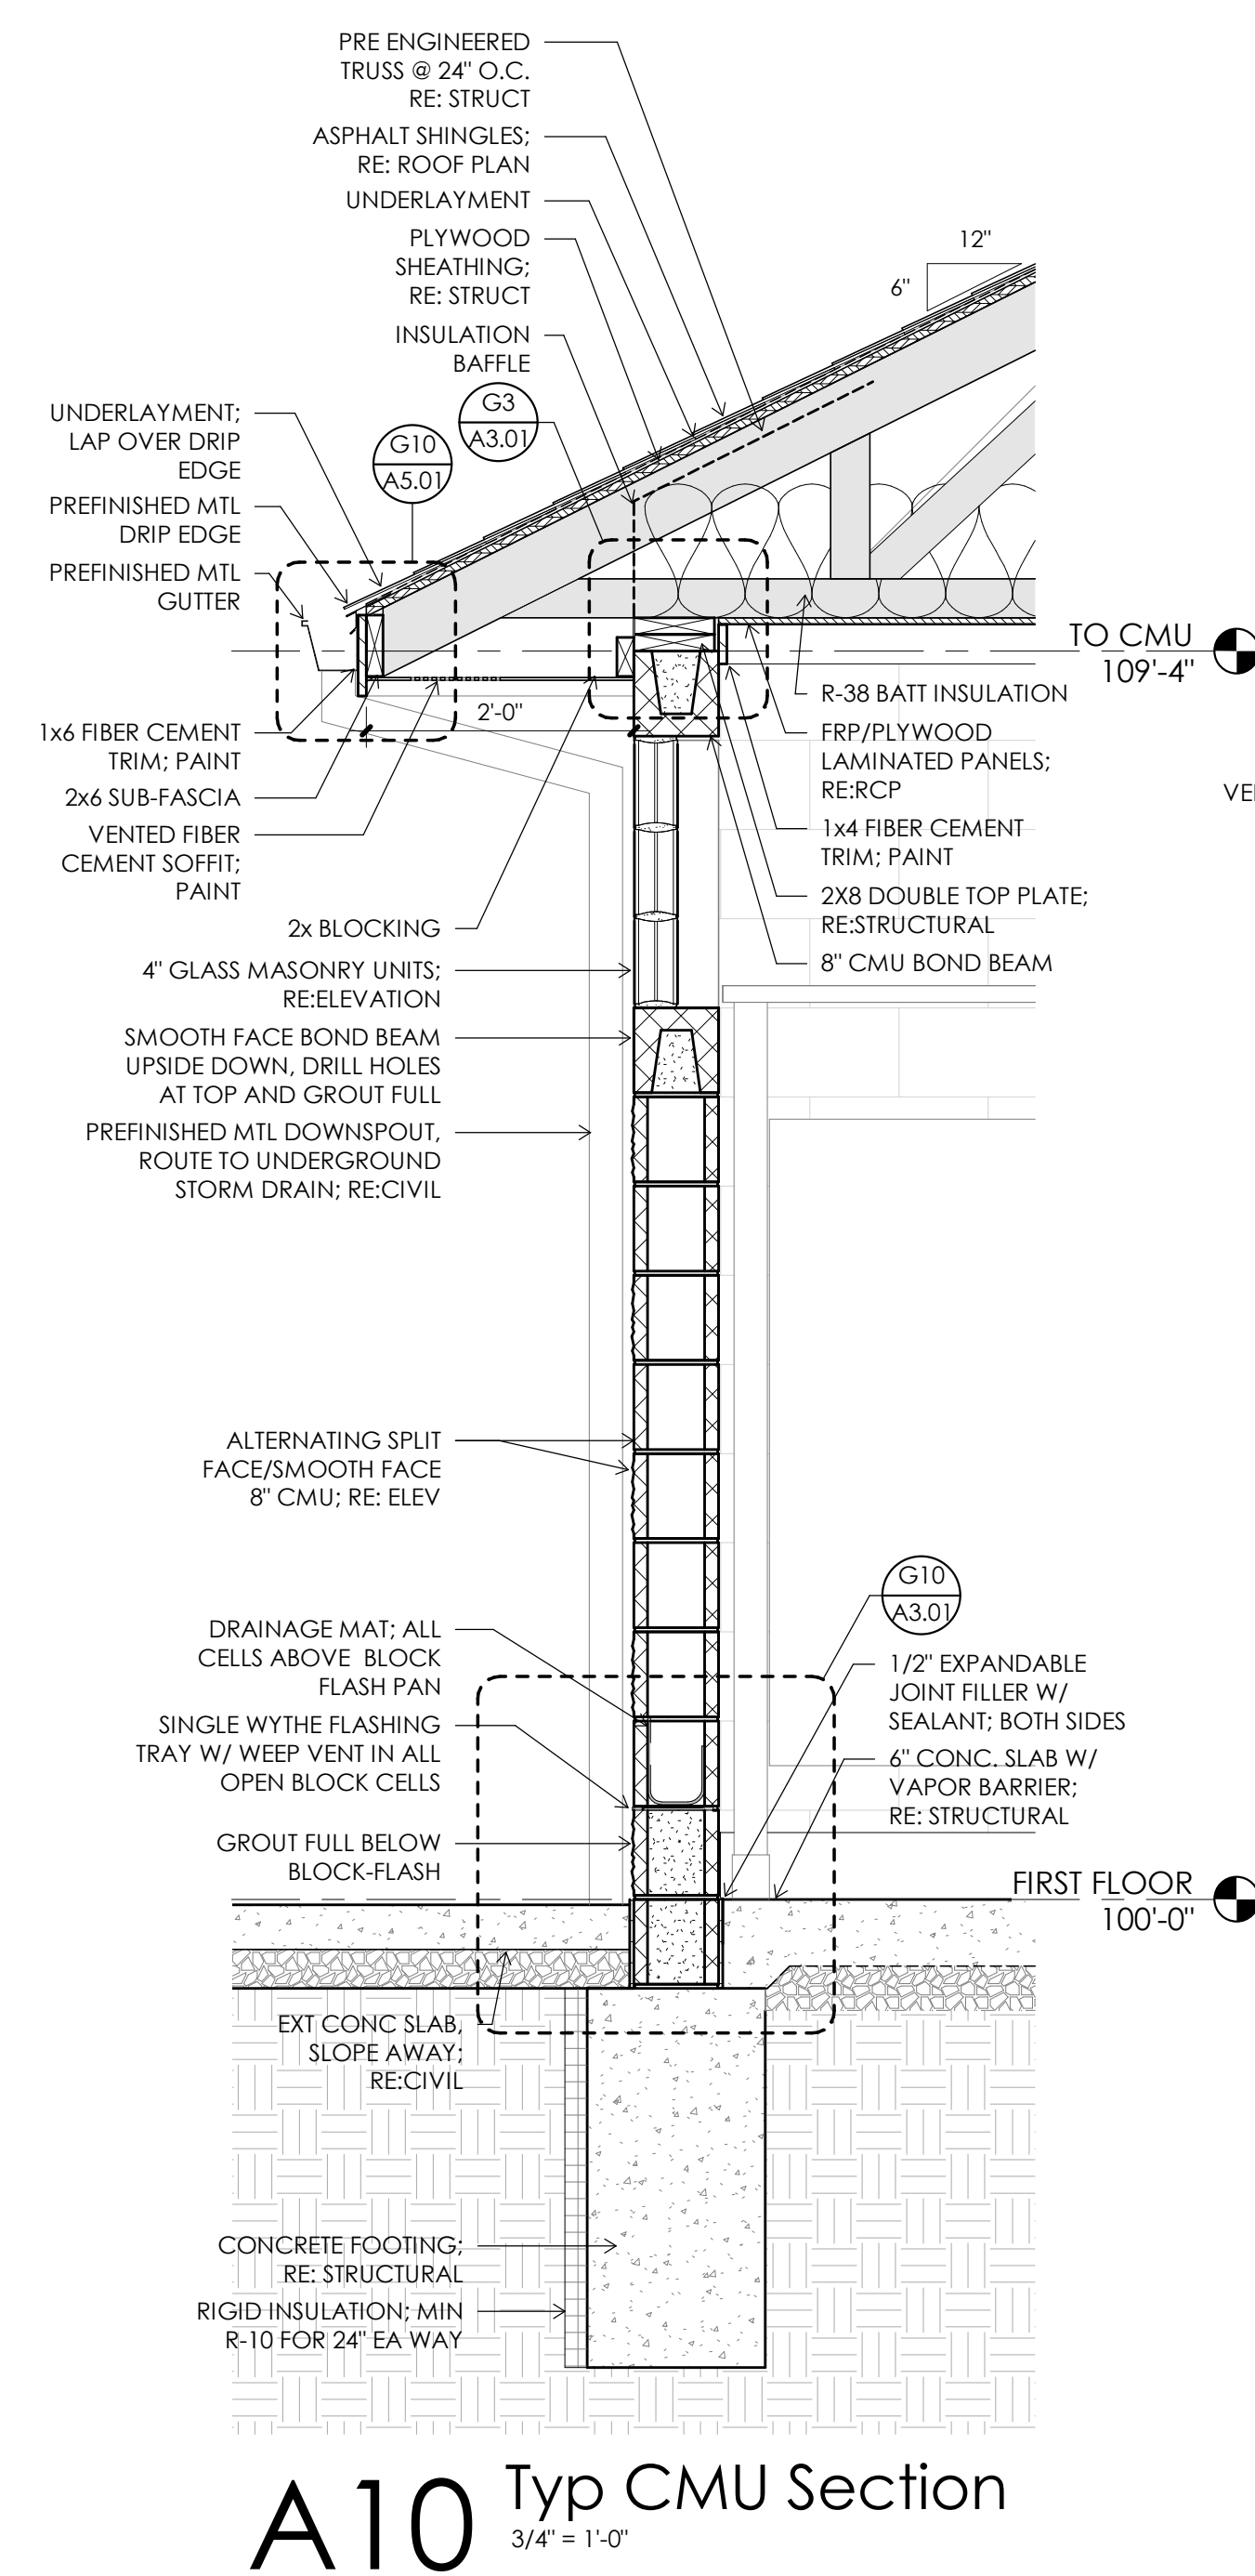
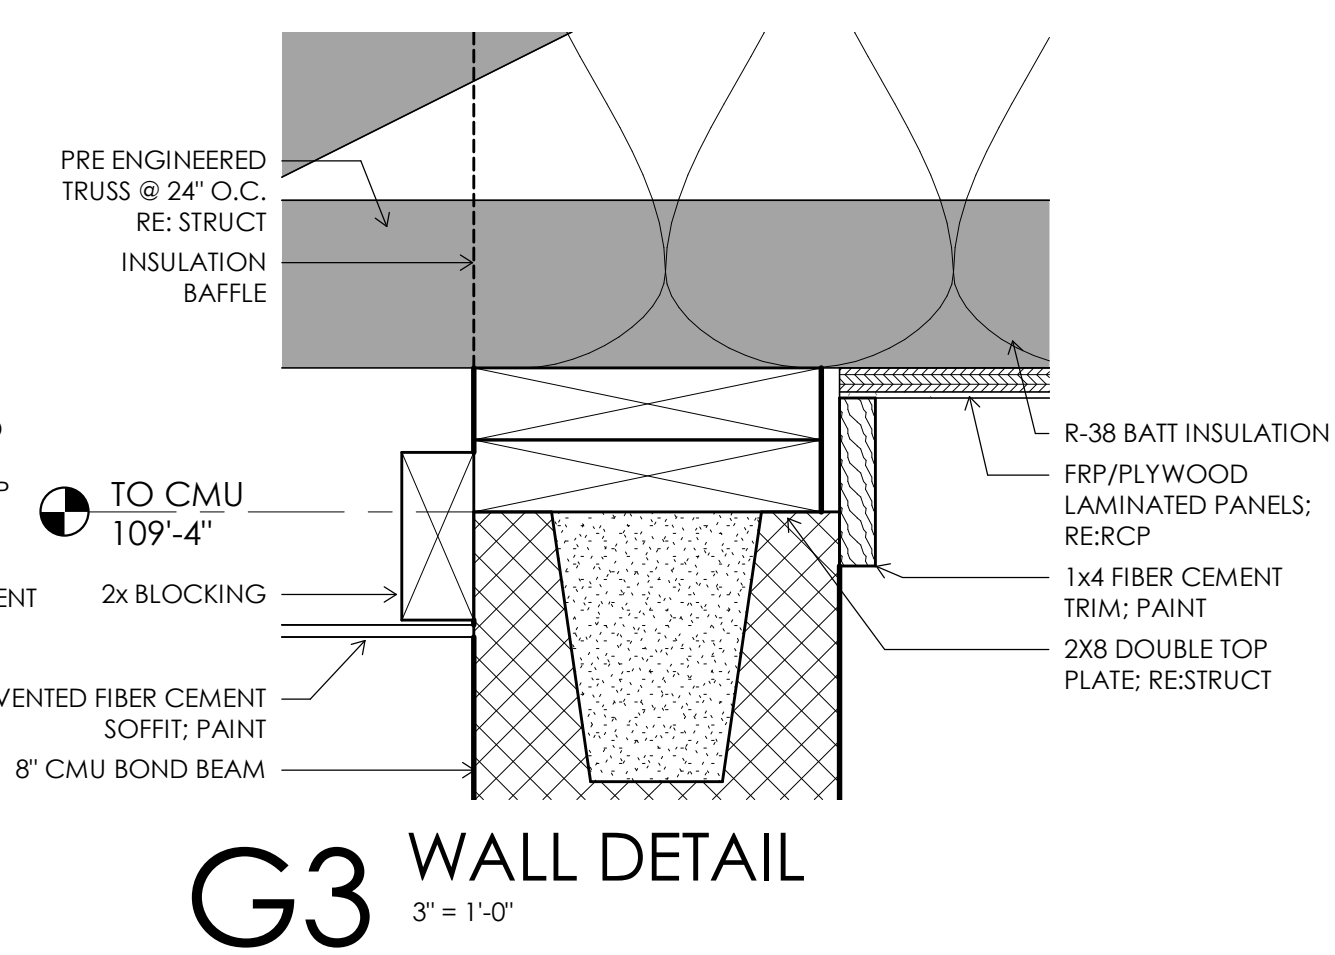
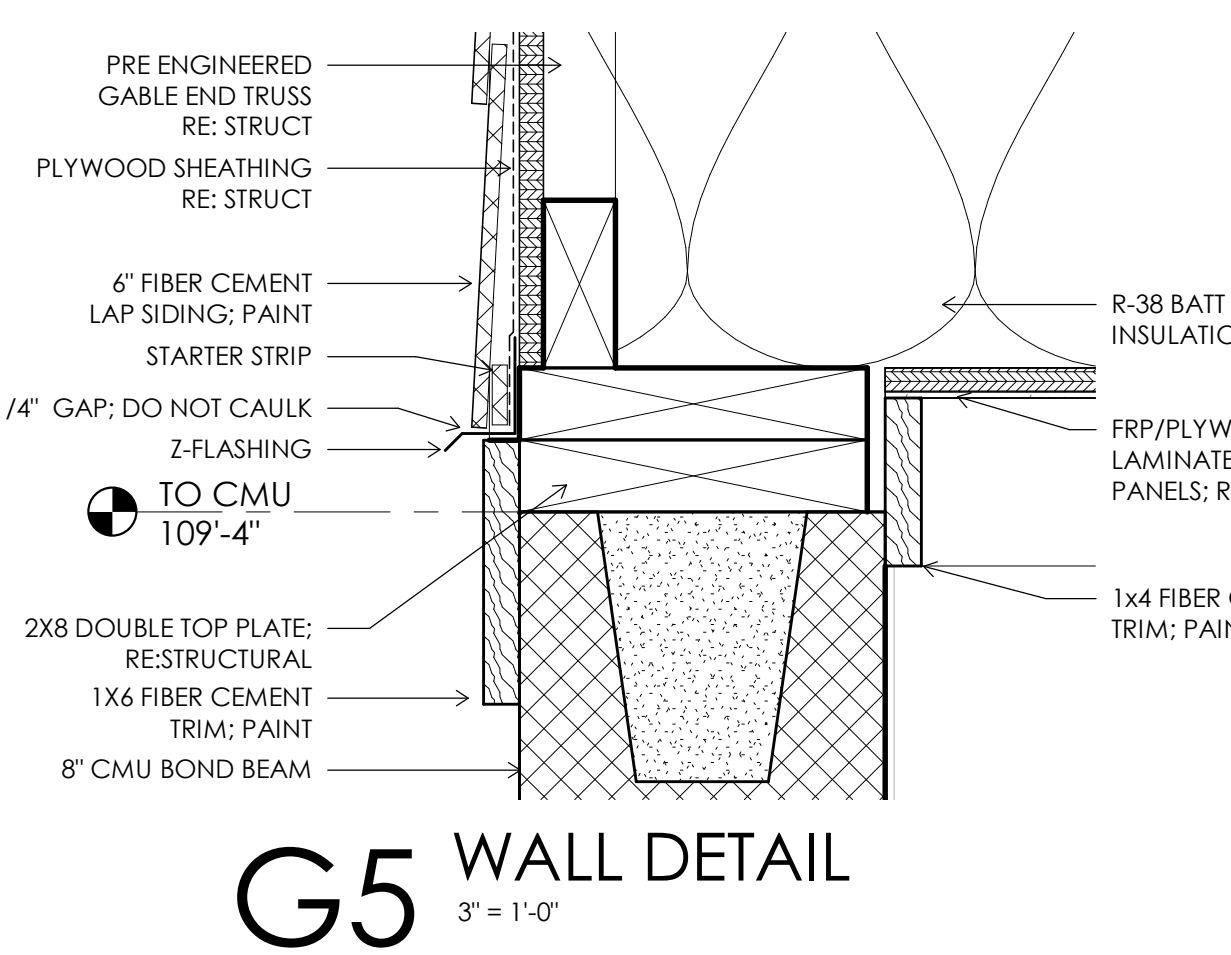
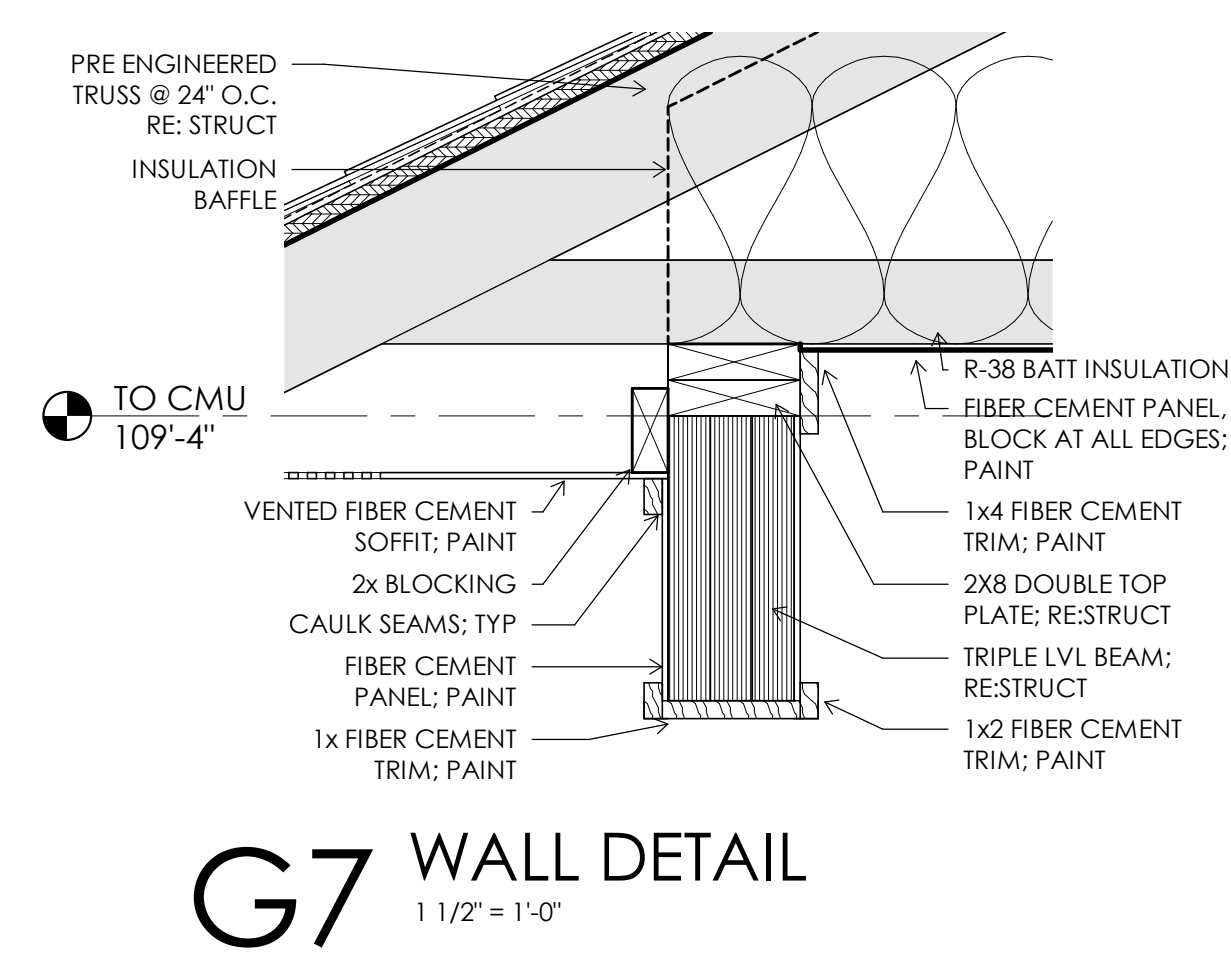
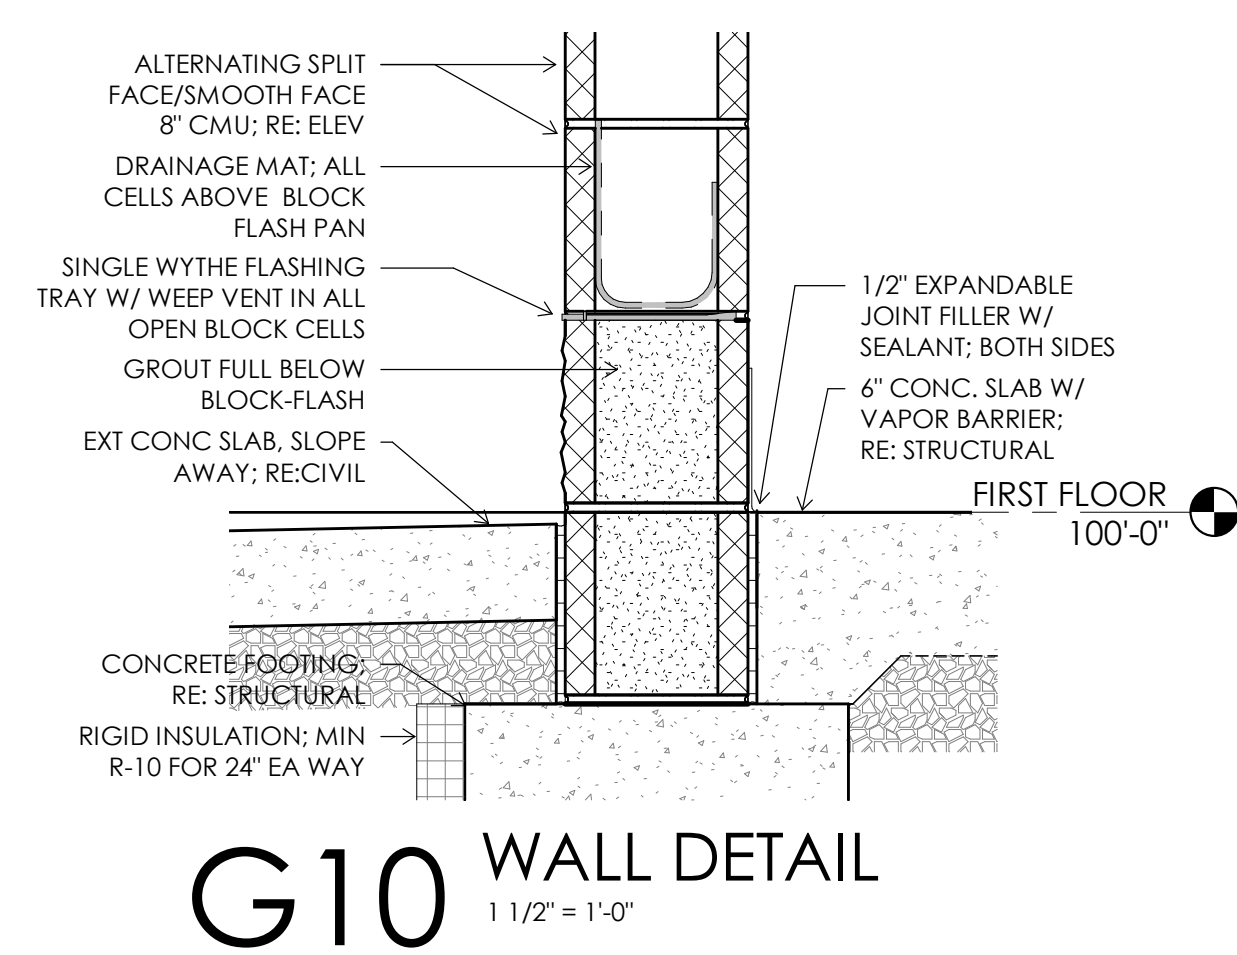
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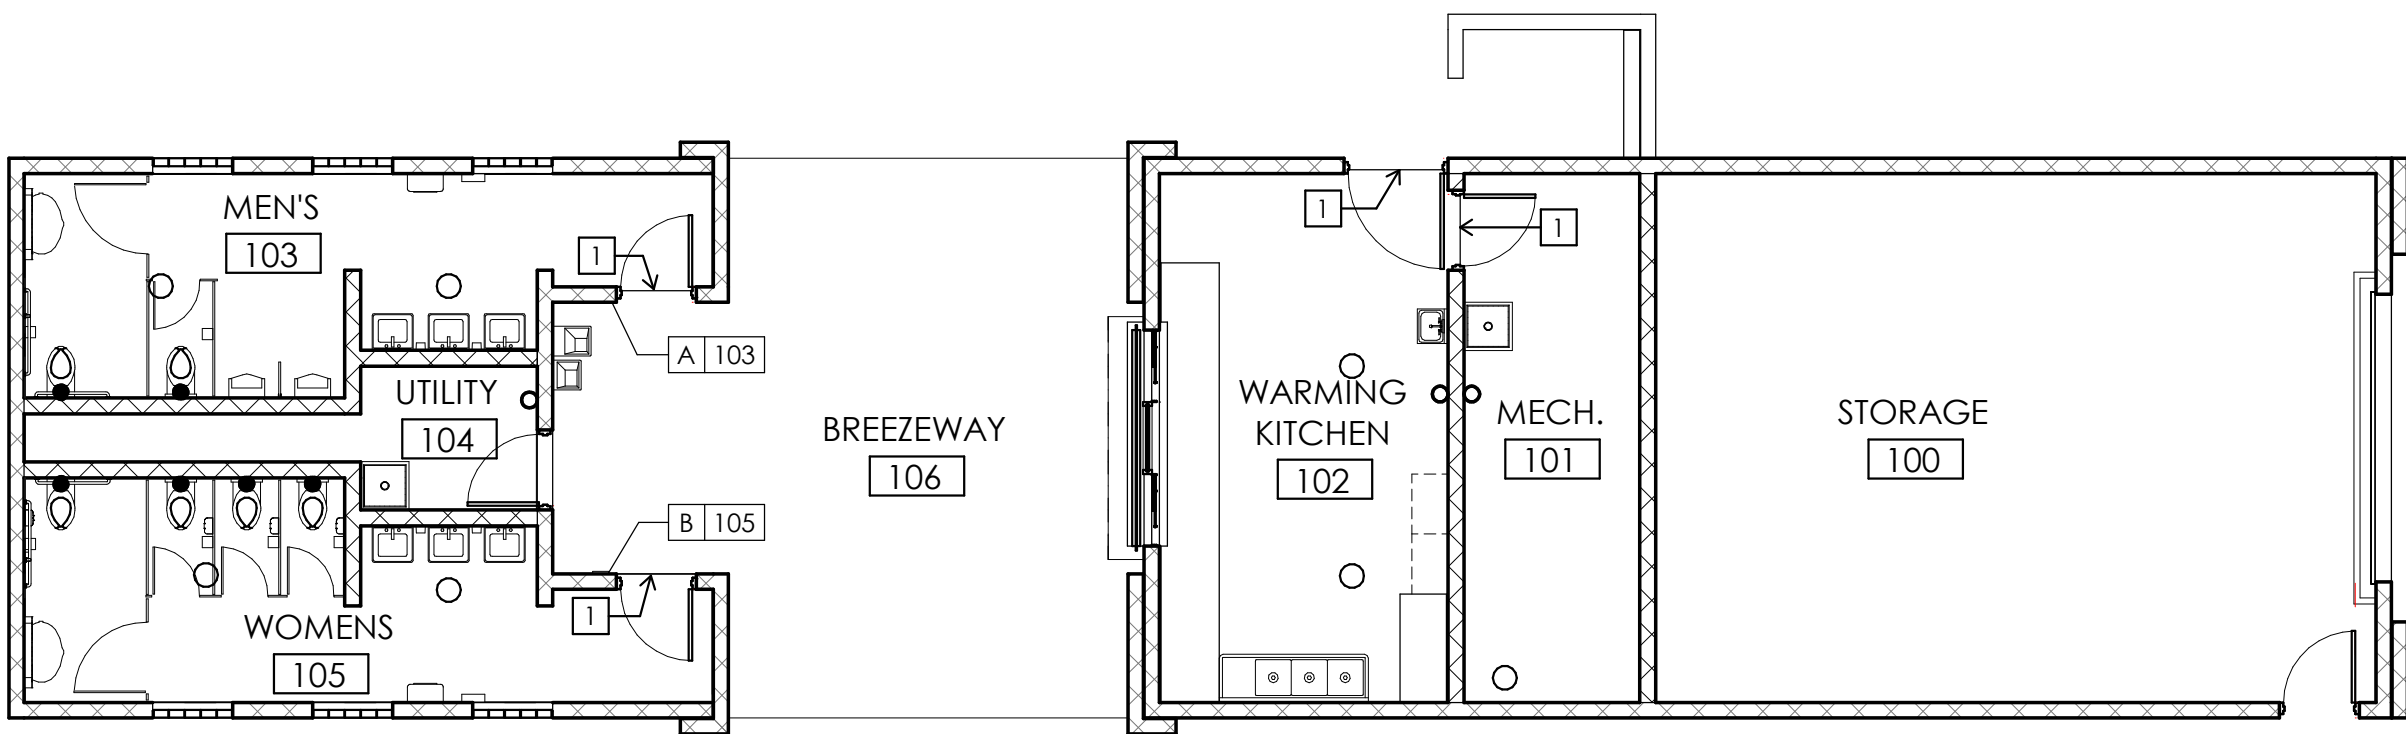
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ELEVATIONS / BUILDING SECTIONS

DRAWING NO.
A2.01





G8 FINISH FLOOR PLAN
1/8" = 1'-0"

FINISH PLAN GENERAL NOTES:

- CONTRACTOR SHALL BE RESPONSIBLE FOR VERIFYING ALL DIMENSIONS AND EXISTING CONDITIONS. ANY DISCREPANCIES WHICH WILL PREVENT THE ACCOMPLISHMENT OF INTENT SHOWN ON DRAWINGS SHALL BE BROUGHT TO THE IMMEDIATE ATTENTION OF THE ARCHITECT.
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- REFER TO ROOM FINISH SCHEDULES ON A7.01 FOR INTERIOR FINISH INFORMATION.
- REFER TO SIGNAGE SCHEDULE ON A7.01 FOR INTERIOR WALL MOUNTED ADA SIGNAGE AND LOCATIONS.

FINISH PLAN NOTES:

- 1 METAL TRANSITION FROM RESINOUS FLOORING TO CONCRETE

FINISH PLAN LEGEND:

A 100 SIGNAGE

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110 Armour Rd.
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816.300.4101



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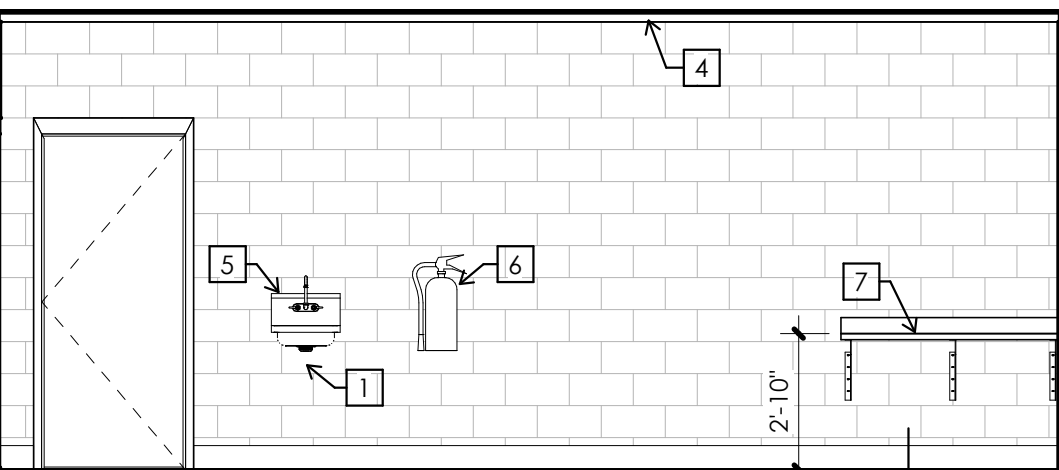
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GENERAL ELEVATION NOTES:


- FOR ITEMS LABELED T# REFER TO SPEC SECTION 102800 - TOILET, BATH, AND LAUNDRY ACCESSORIES.
- ALL DIMENSIONS ON INTERIOR ELEVATIONS ARE FROM FINISHED SURFACES.
- OFOI= OWNER FURNISHED, OWNER INSTALLED.
- OFCI= OWNER FURNISHED, CONTRACTOR INSTALLED.

ELEVATION NOTES:


- 1 INSULATED PIPE WRAP, RE: PLUMBING
2 TOILET PARTITION, RE: SPEC SECTION 102113.19
3 COUNTERTOP ON SUPPORT BRACKETS, 36" O.C.
4 PAINT TRIM TO MATCH WALL
5 SINK; RE: PLUMBING
6 FIRE EXTINGUISHER, RE:G0.01
7 COUNTERTOP ON SUPPORT BRACKETS; RE: FINISH SCHEDULE



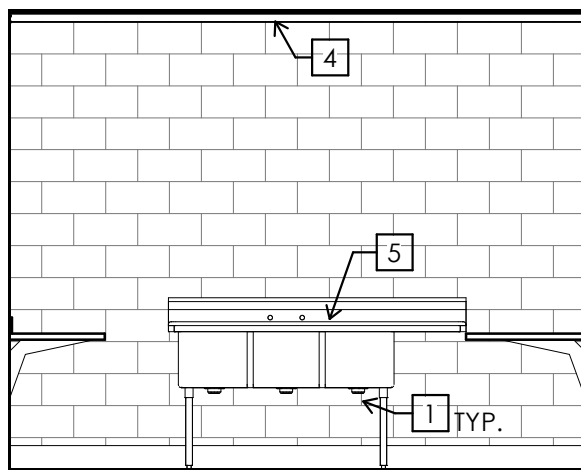
C8 WARMING KITCHEN
1/4" = 1'-0"




C6 WARMING KITCHEN
1/4" = 1'-0"

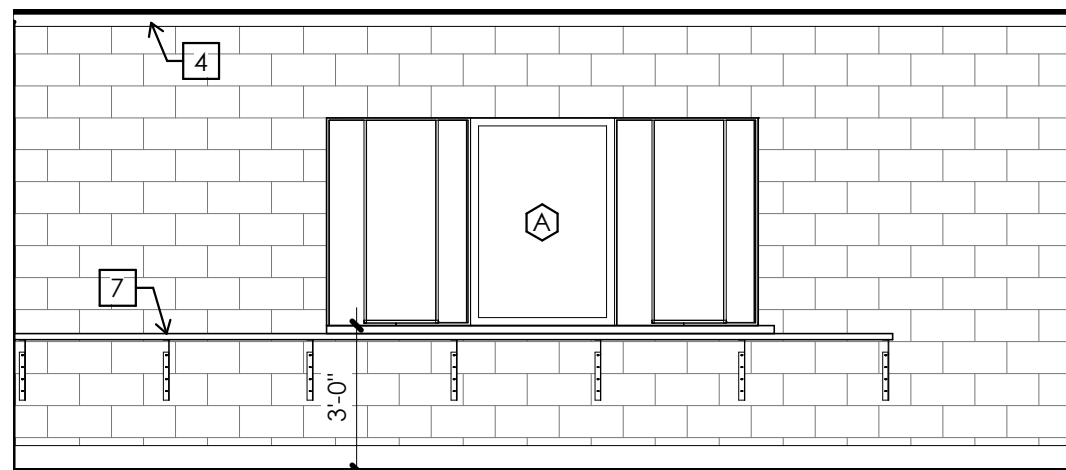


C4 WARMING KITCHEN
1/4" = 1'-0"

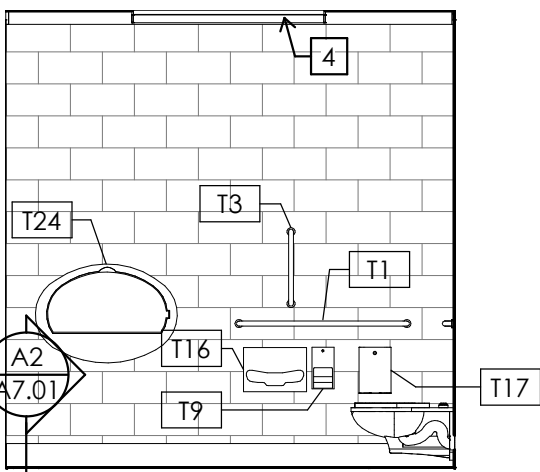


B8 WOMEN
1/4" = 1'-0"

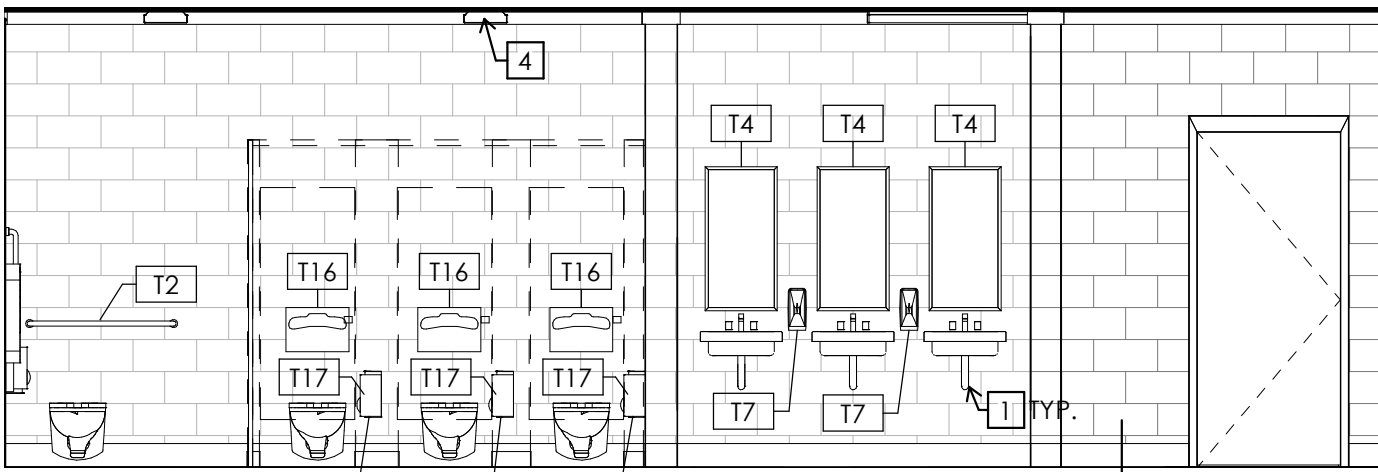


B7 WOMEN
1/4" = 1'-0"

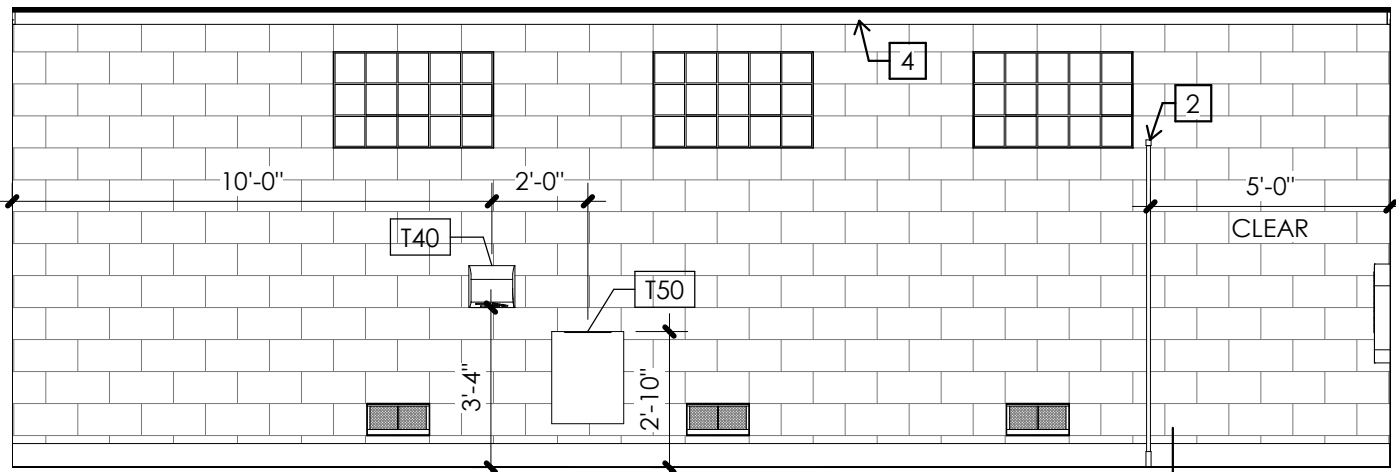


B4 WOMEN
1/4" = 1'-0"

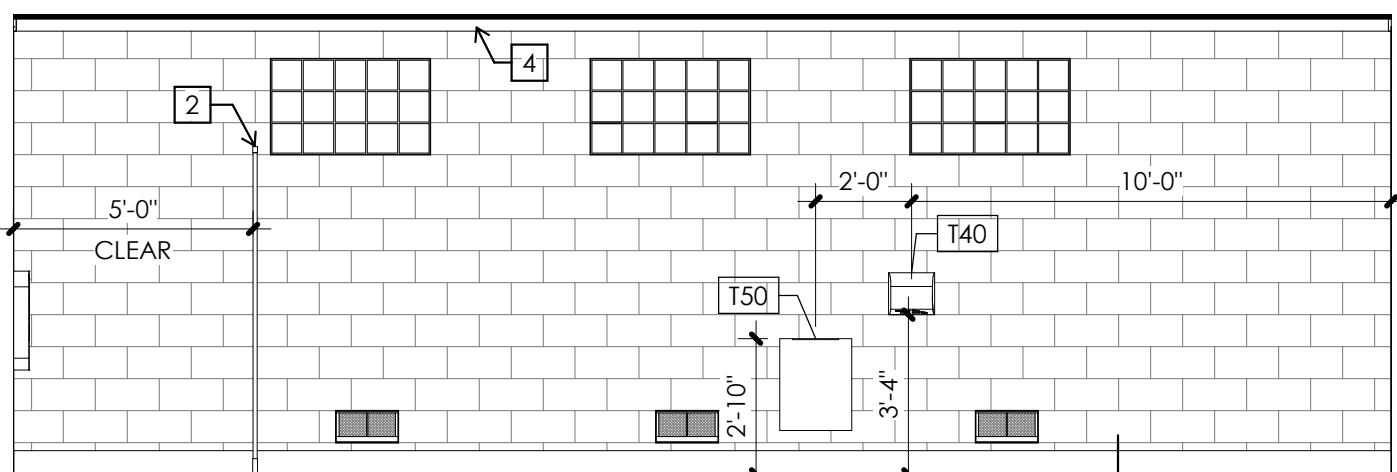

A8 MEN
1/4" = 1'-0"

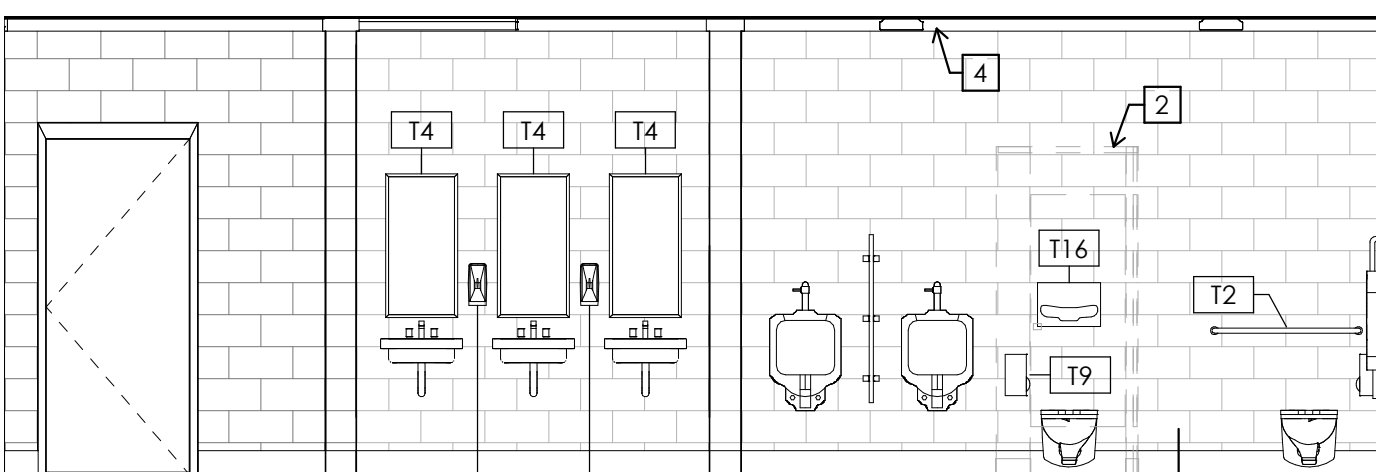

A5 MEN
1/4" = 1'-0"

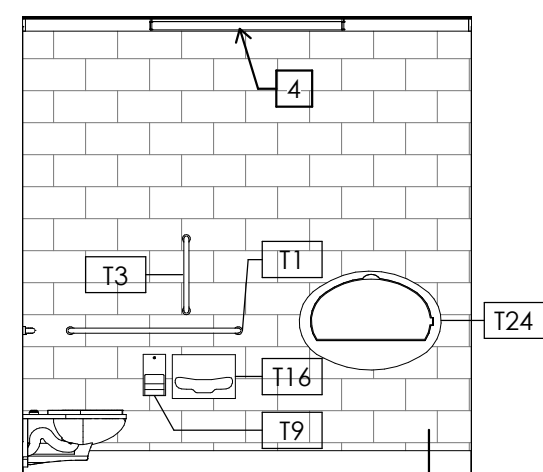


A3 MEN
1/4" = 1'-0"


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INTERIOR ELEVATIONS


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A4.01

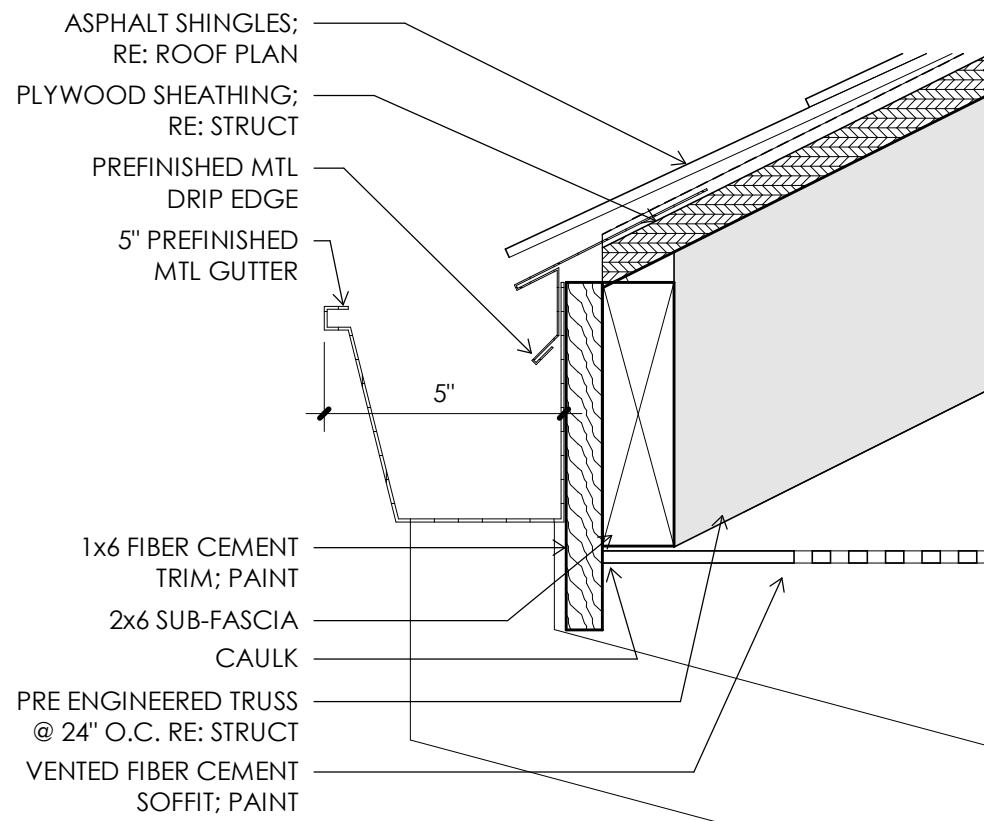

G10 ROOF DETAIL
3" = 1'-0"

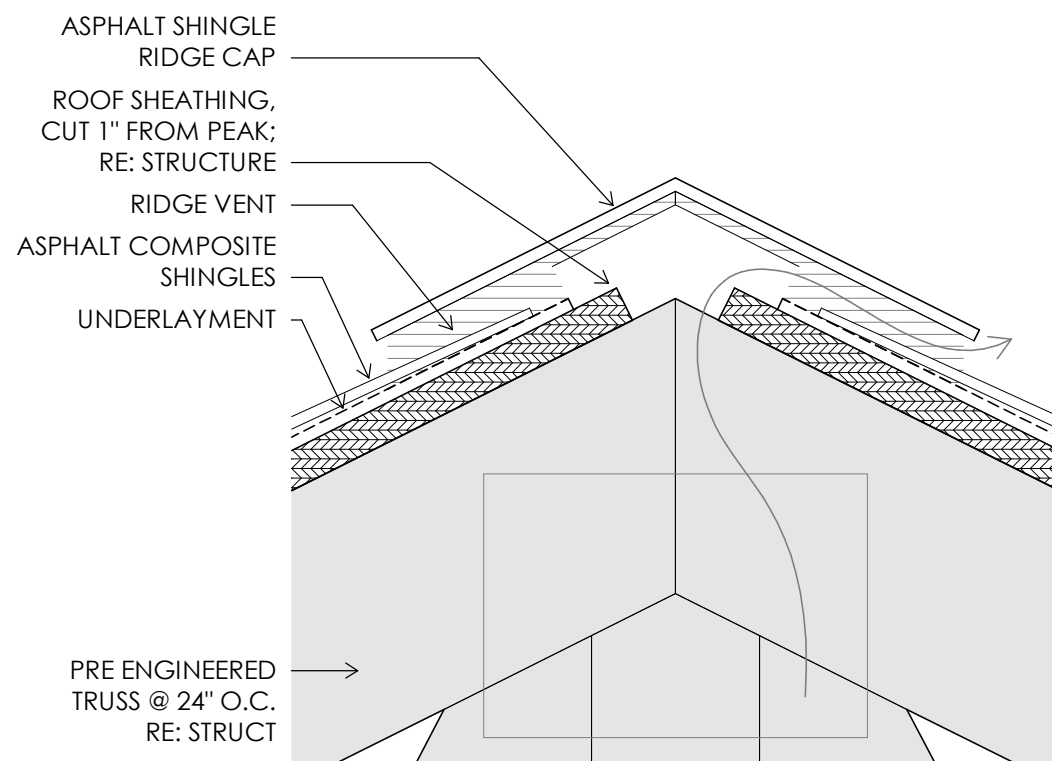

G8 ROOF DETAIL
3" = 1'-0"

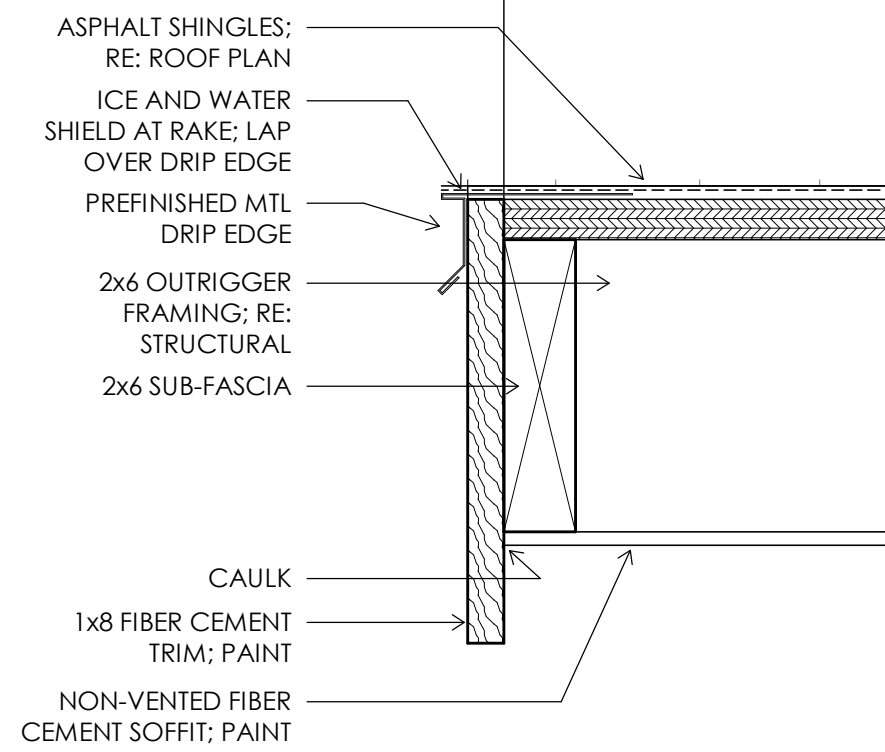

G6 ROOF DETAIL
3" = 1'-0"

GENERAL NOTES:

- RUN FRAMING FOR SOFFIT UP TO STRUCTURE W/ KICKERS @ 24" O.C. U.N.O.
- REFER TO ELECTRICAL FOR LIGHT FIXTURE TYPES AND NOTES.
- REFER TO MECHANICAL FOR SUPPLY AND RETURN REGISTER LOCATIONS.

RCP NOTES:

- 1 OPEN TO STRUCTURE
- 2 FRP PANELS ADHERED TO 5/8" EXTERIOR GRADE PLYWOOD
- 3 FIBER CEMENT SOFFIT PANELS W/ 1x3 BATTENS; PAINT, COLOR: MATCH EXISTING BUILDING
- 4 VENTED FIBER CEMENT SOFFIT; PAINT, COLOR: MATCH EXISTING BUILDING
- 5 NON-VENTED FIBER CEMENT SOFFIT; PAINT, COLOR: MATCH EXISTING BUILDING
- 6 FIBER CEMENT FASCIA TRIM; PAINT, COLOR: MATCH EXISTING BUILDING
- 7 BEAM; RE:STRUCTURAL
- 8 PREFINISHED MTL GUTTER; COLOR TO BE SELECTED BY ARCHITECT
- 9 PREFINISHED MTL DOWNSPOUT; COLOR TO BE SELECTED BY ARCHITECT
- 10 OVERHEAD DOOR CLEARANCE
- 11 COILING COUNTER DOOR HOOD
- 12 24"x48" ATTIC ACCESS PANEL; SPACE BTW ROOF TRUSSES
- 13 LIGHT FIXTURE; RE:M/E/P
- 14 AIR TERMINAL; RE:M/E/P

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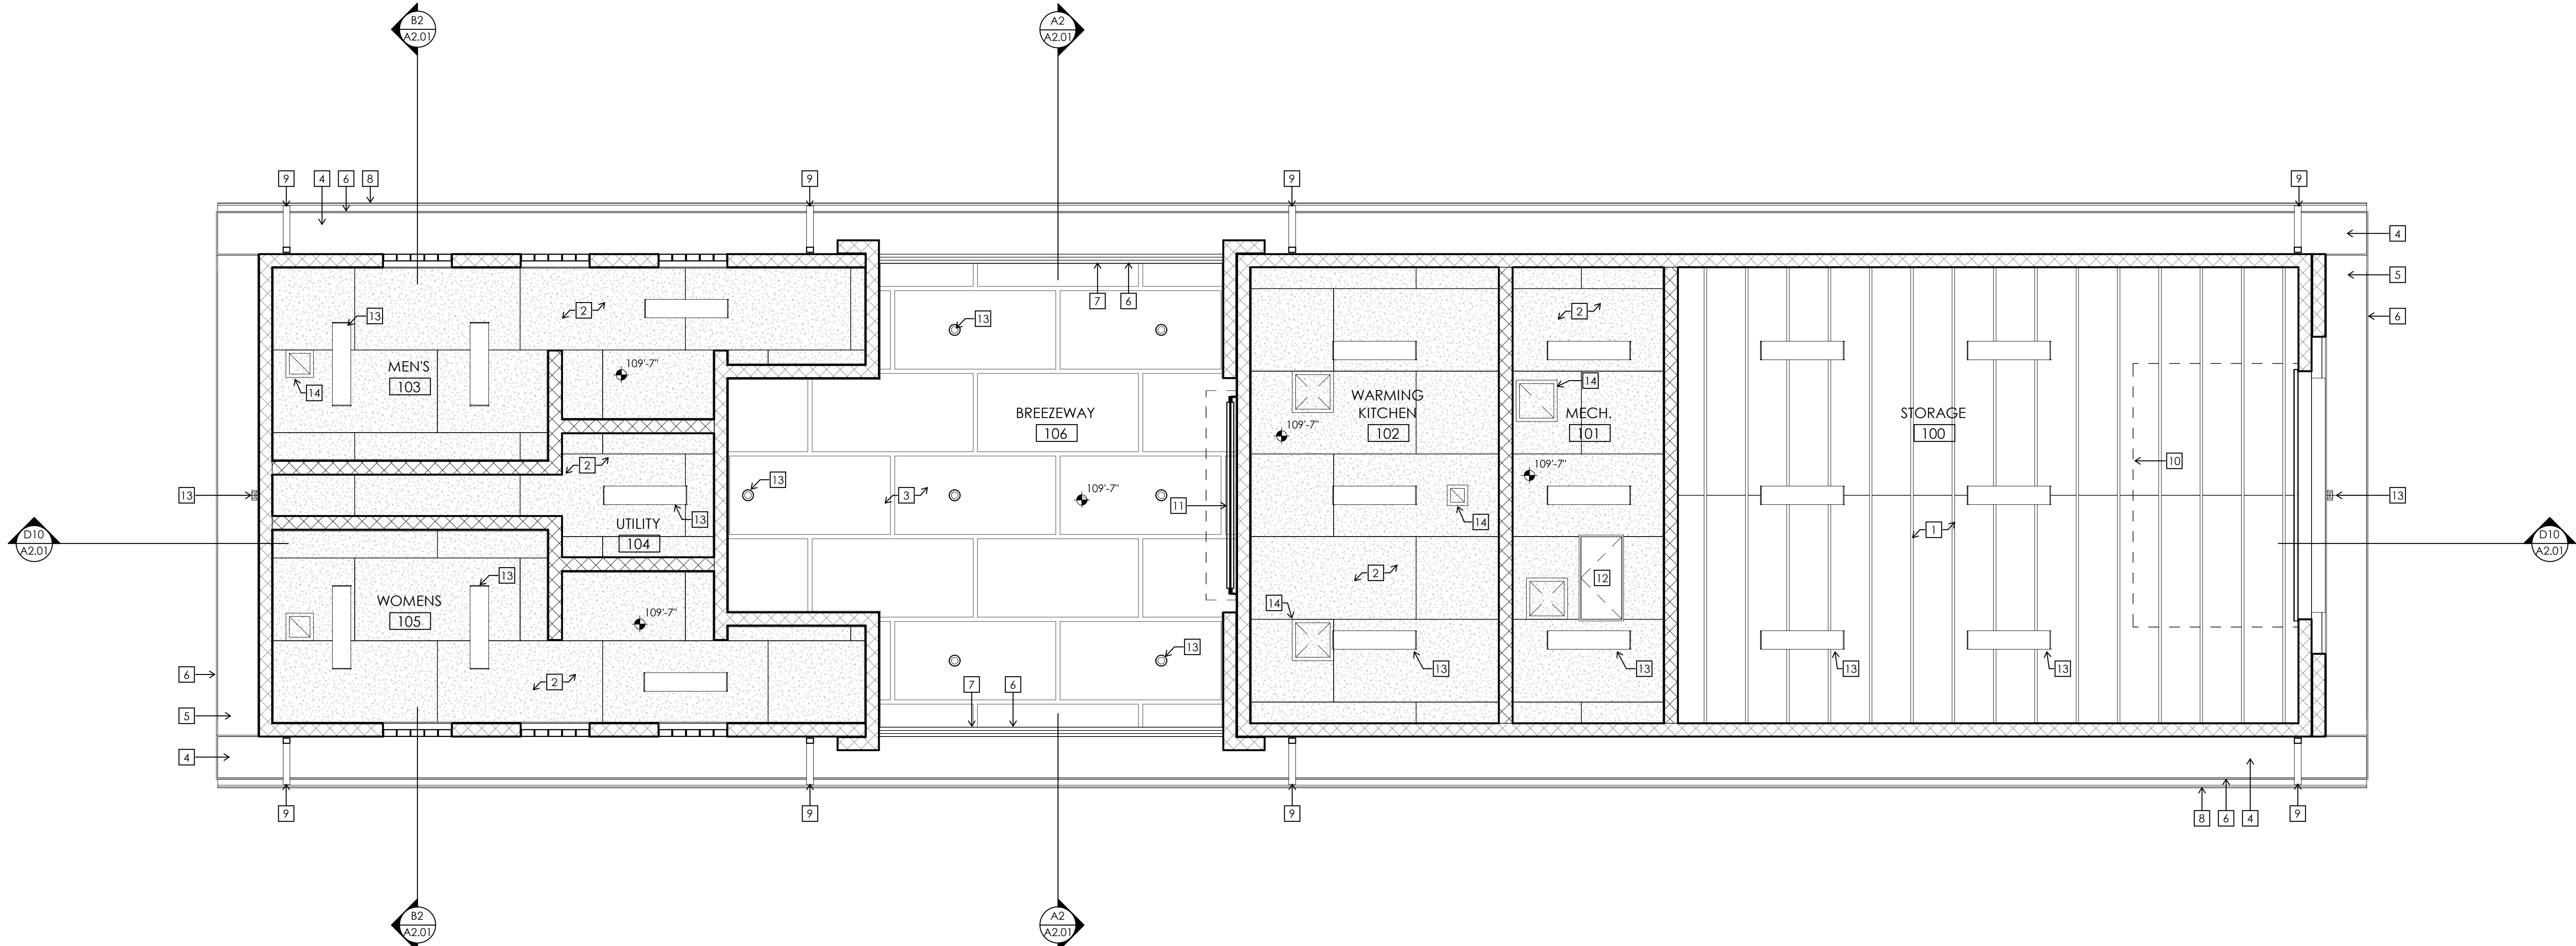
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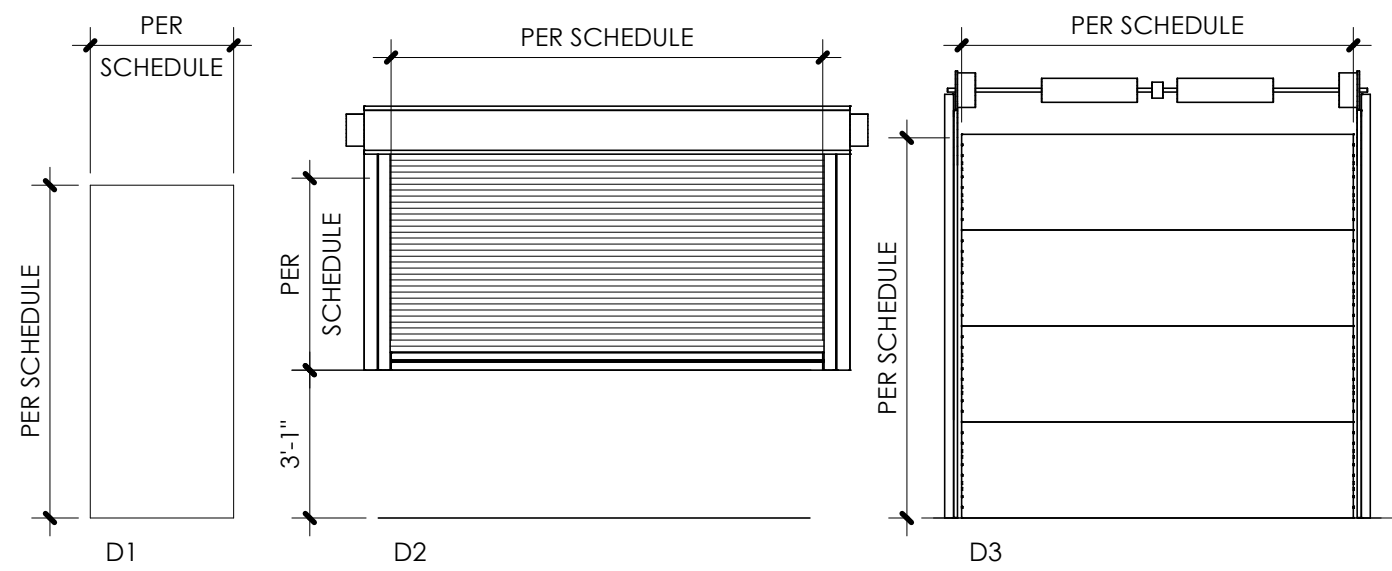
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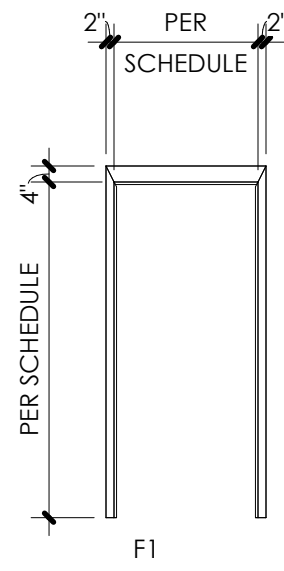
DRAWING NO.
A5.01




A10 REFLECTED CEILING PLAN
1/4" = 1'-0"



DOOR TYPES
1/4" = 1'-0"



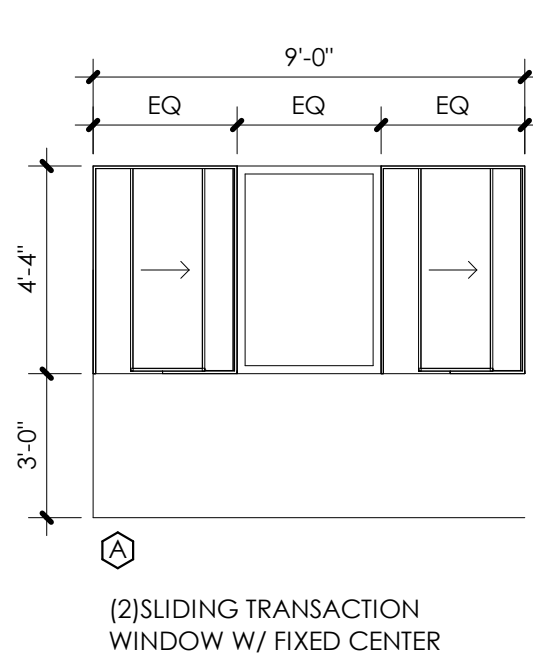FRAME TYPES
1/4" = 1'-0"



FRAME TYPES
1/4" = 1'-0"


DOOR SCHEDULE											
DOOR INFORMATION						FRAME INFORMATION					
NO.	WIDTH	HEIGHT	TYPE	MATERIAL	FIRE RATING	TYPE	MATERIAL	DEPTH	HEAD	JAMB	THRESHOLD
100A	12'-0"	8'-0"	D3	INSUL STL	-		STL		D10/A6.01	C10/A6.01	A10/A6.01
100B	3'-0"	7'-0"	D1	HM	-	F1	HM	5 3/4"	D6/A6.01	C6/A6.01	A6/A6.01
101	3'-0"	7'-0"	D1	HM	-	F1	HM	5 3/4"	D6/A6.01	C6/A6.01	A6/A6.01
102A	4'-0"	7'-0"	D1	HM	-	F1	HM	5 3/4"	D6/A6.01	C6/A6.01	A6/A6.01
102B	9'-0"	4'-4"	D2	STL	-		STL		D8/A6.01	C8/A6.01	A8/A6.01
103	3'-0"	7'-0"	D1	HM	-	F1	HM	5 3/4"	D6/A6.01	C6/A6.01	A6/A6.01
104	3'-0"	7'-0"	D1	HM	-	F1	HM	5 3/4"	D6/A6.01	C6/A6.01	A6/A6.01
105	3'-0"	7'-0"	D1	HM	-	F1	HM	5 3/4"	D6/A6.01	C6/A6.01	A6/A6.01

DOOR SCHEDULE GENERAL NOTES:


- HOLLOW METAL DOORS TO BE 1 3/4" THICK U.N.O.
- EXTERIOR HOLLOW METAL DOORS TO BE INSULATED.

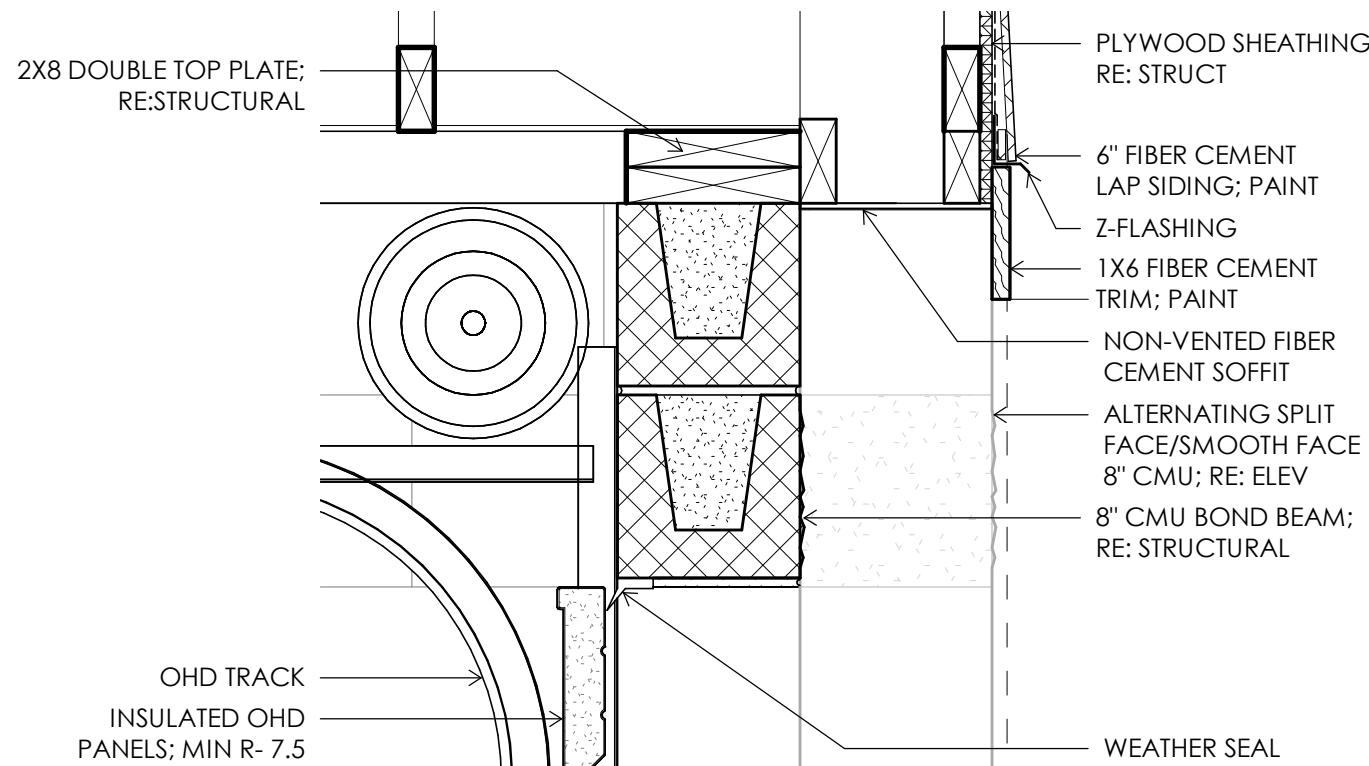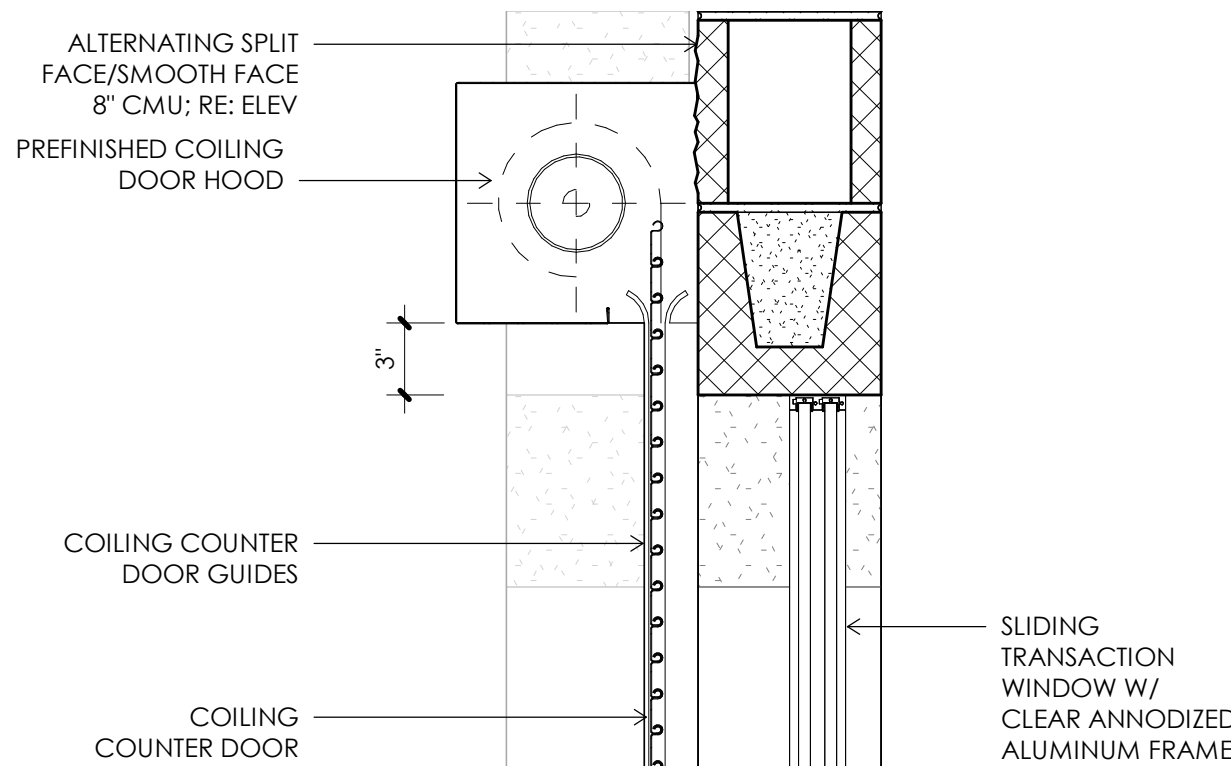DOOR SCHEDULE KEY NOTES:

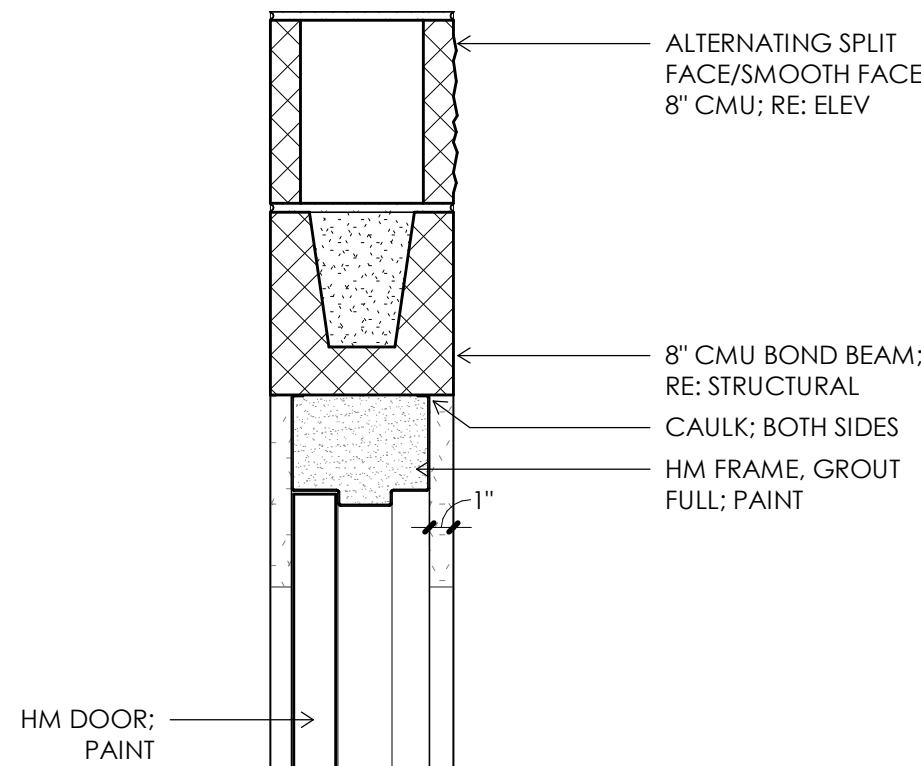
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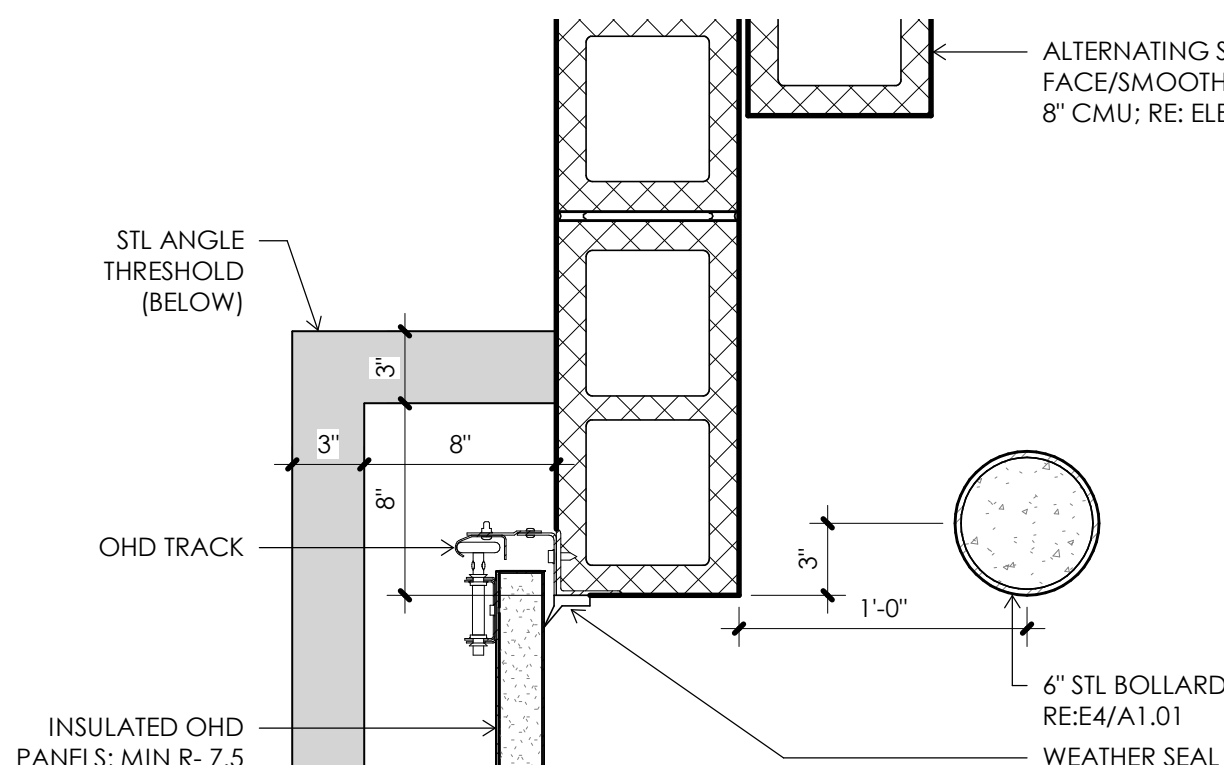
D10 HEAD DETAIL
1 1/2" = 1'-0"




D8 HEAD DETAIL
1 1/2" = 1'-0"




D6 HEAD DETAIL
1 1/2" = 1'-0"



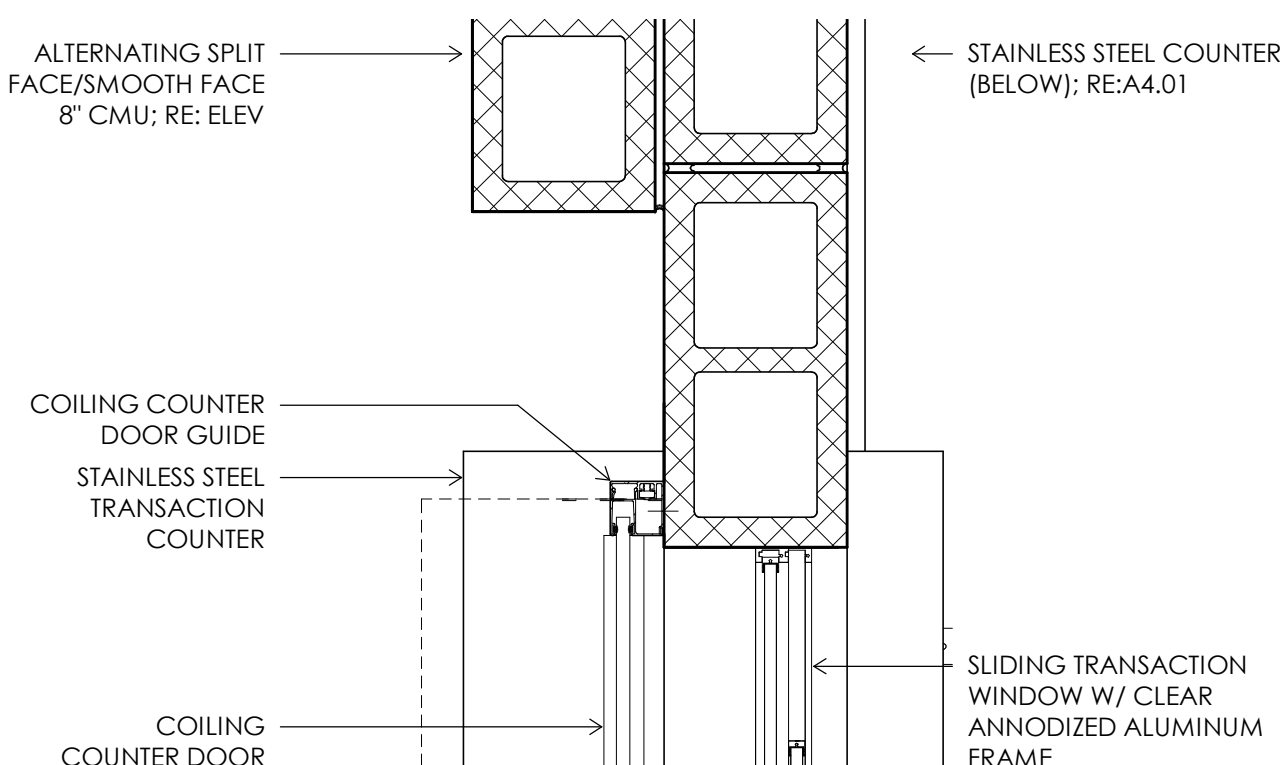
C10 JAMB DETAIL
1 1/2" = 1'-0"




C8 JAMB DETAIL
1 1/2" = 1'-0"

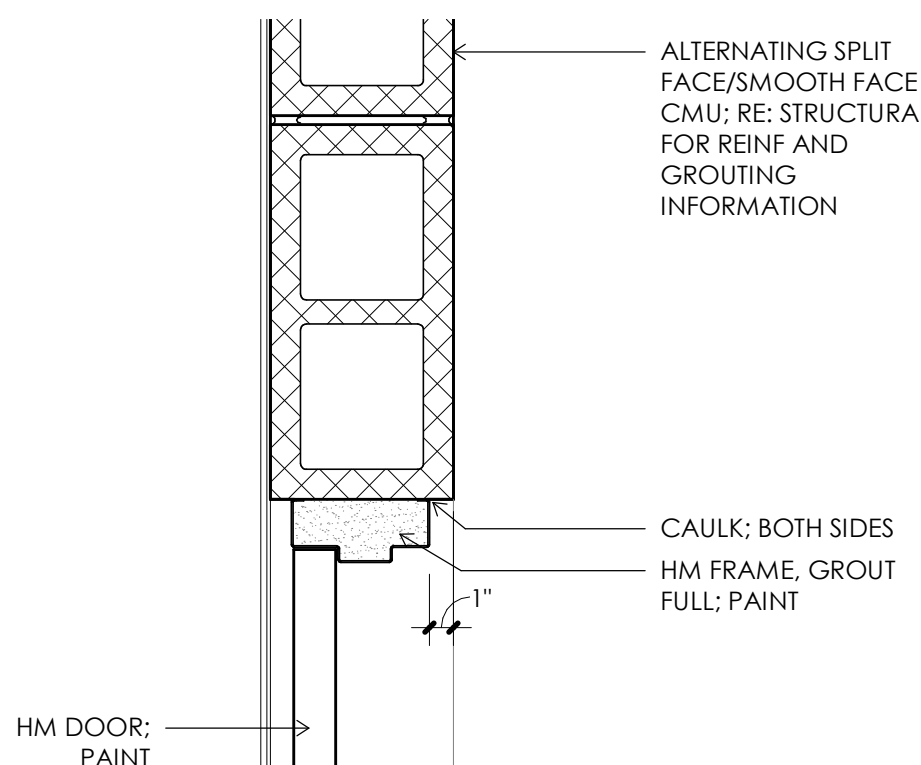


C6 JAMB DETAIL
1 1/2" = 1'-0"

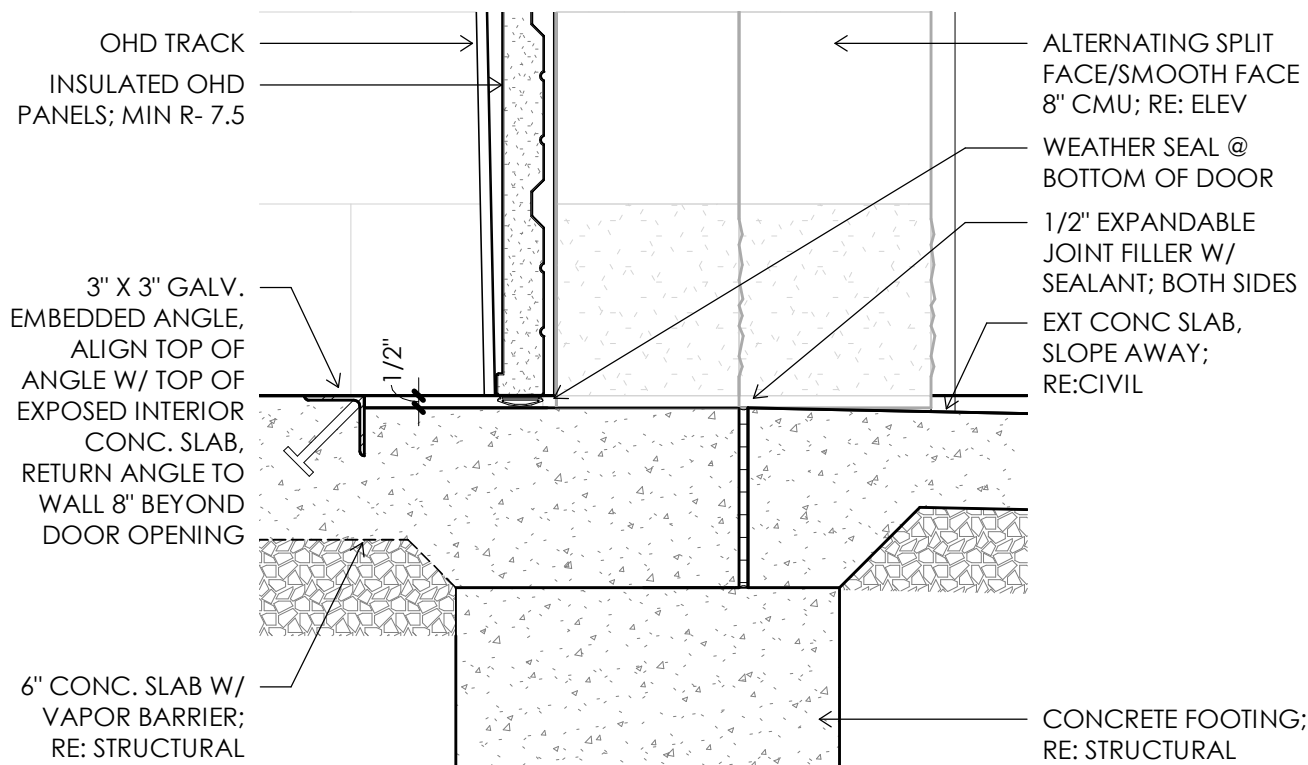

A10 THRESHOLD DETAIL
1 1/2" = 1'-0"

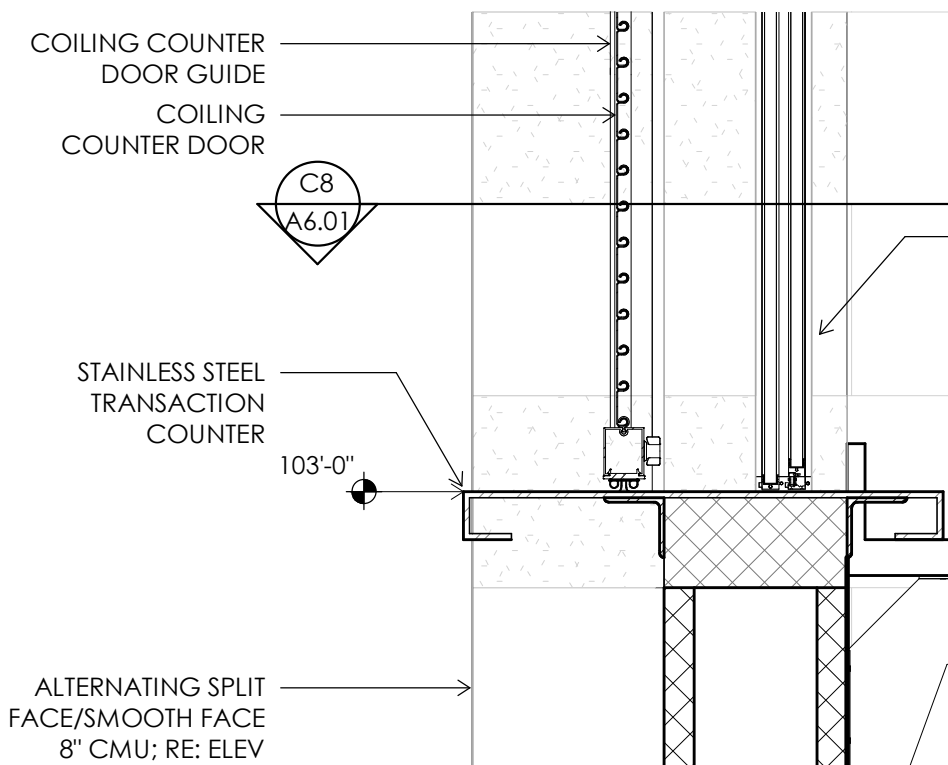

A8 SILL DETAIL
1 1/2" = 1'-0"

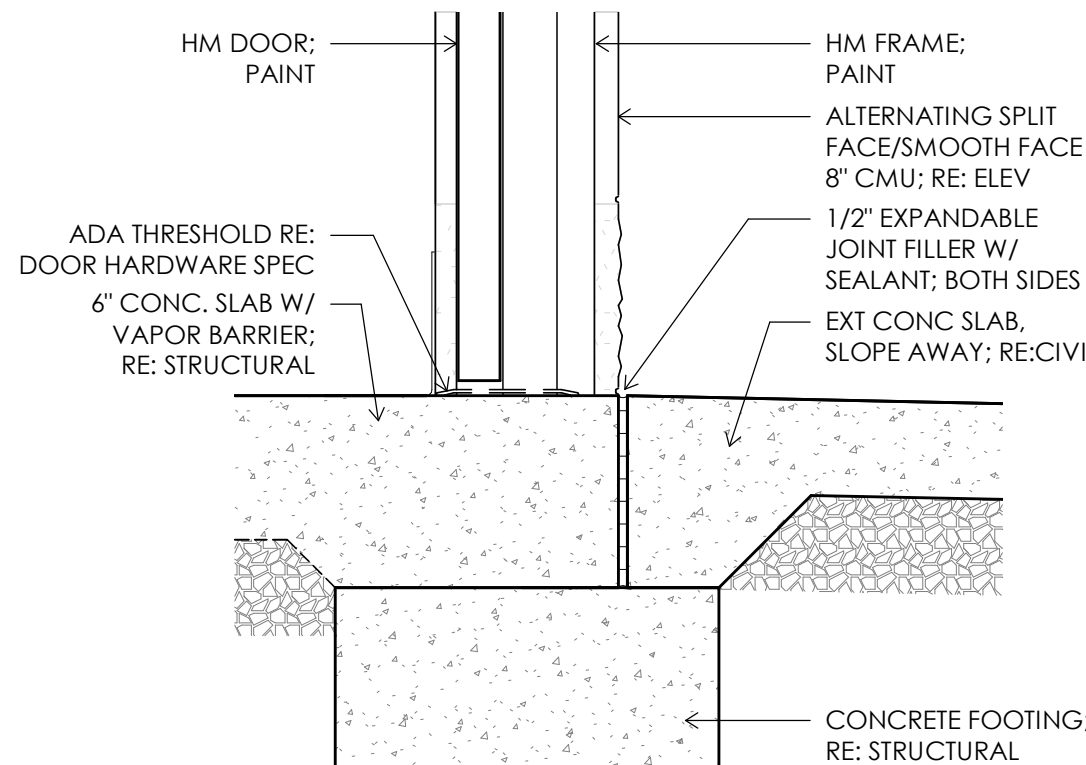

A6 THRESHOLD DETAIL
1 1/2" = 1'-0"

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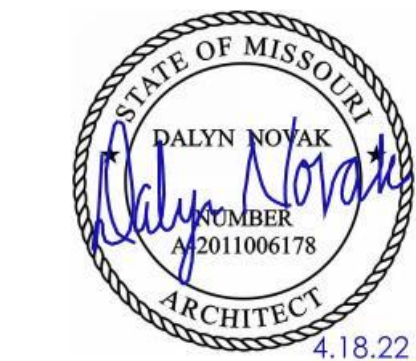
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Dalyn Novak - Architect
MO # A-2011006178

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No.	Description	Date

PROJECT NUMBER: 210266-000
SET ISSUE DATE: 04/13/2022

ENGINEER: DRAWN BY: CHECKED BY:

PLATE RIDGE PARK - FOOTBALL
COMPLEX IMPROVEMENTS
17130 HIGHWAY 371, PLATTE CITY, MO 64079

DOOR SCHEDULE


DRAWING NO.
A6.01

ROOM NO	ROOM NAME	FLOOR		WALLS				CEILING	CASEWORK		REMARKS
		FINISH	BASE	NORTH	EAST	SOUTH	WEST		BASE	COUNTER	
										UPPER	
100	STORAGE	F2	--	EP3	EP3	EP3	EP3	STR	--	--	
101	MECH.	F2	--	EP3	EP3	EP3	EP3	FRP1	--	--	
102	WARMING KITCHEN	F1	B1	EP1	EP1	EP1	EP1	FRP1	--	STL1	
103	MEN'S	F1	B1	EP1	EP1	EP1	EP1	FRP1	--	--	
104	UTILITY	F2	--	--	--	--	--	FRP1	--	--	
105	WOMEN'S	F1	B1	EP1	EP1	EP1	EP1	FRP1	--	--	

GENERAL FINISH SCHEDULE NOTES:
A. PAINT TRIM AT CEILING TO MATCH WALL COLOR.

SIGNAGE SCHEDULE			
ROOM LOCATION		TYPE	SIGN TEXT
NO.	NAME		
103	MEN'S	A	MEN
105	WOMEN'S	B	WOMEN

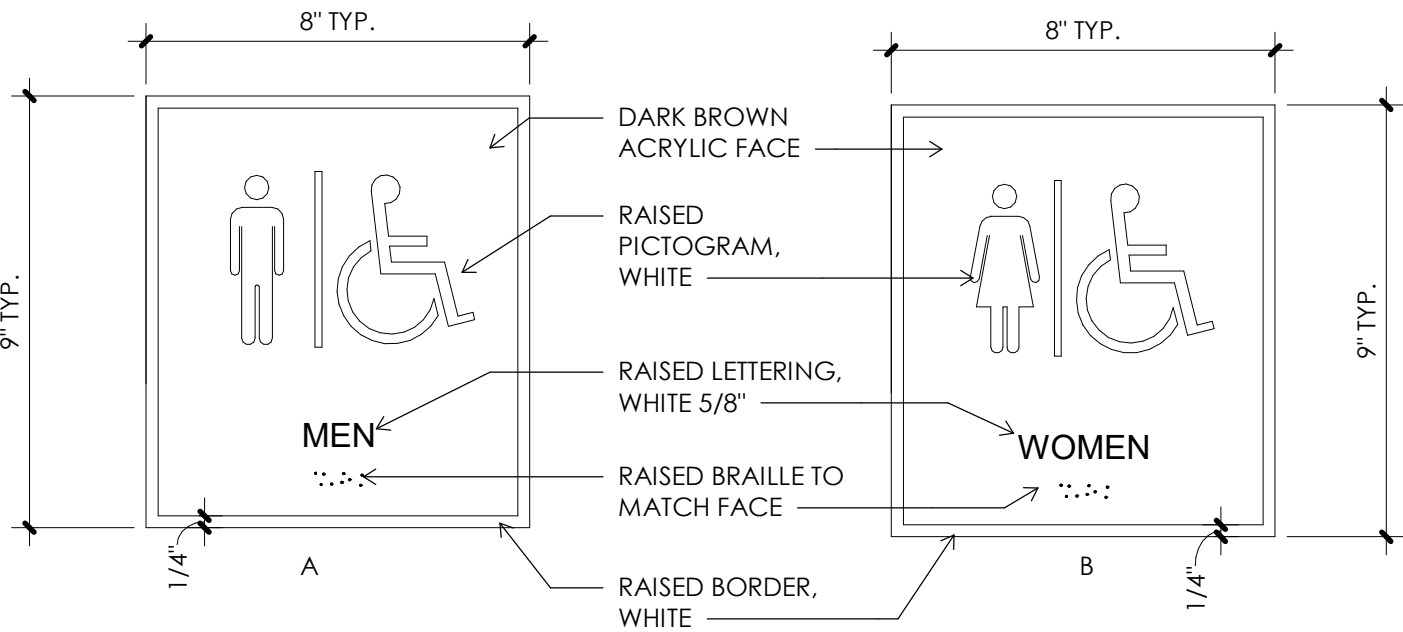GENERAL SIGNAGE SCHEDULE NOTES:
A. REFER TO FINISH PLAN ON A4.01 FOR SIGNAGE LOCATIONS



SIGNAGE TYPES
3" = 1'-0"

TOILET ACCESSORY SCHEDULE		
KEY	DESCRIPTION	NOTES
T1	42" GRAB BAR	
T2	36" GRAB BAR	
T3	18" VERTICAL GRAB BAR	
T4	CHANNEL FRAME MIRROR	
T7	SOAP DISPENSER	NOTE: 1
T9	SURFACE MOUNTED TOILET TISSUE DISPENSER	
T16	SURFACE MOUNTED SEAT COVER DISPENSER	
T17	SURFACE MOUNTED NAPKIN DISPOSAL	
T24	SURFACE MOUNTED BABY CHANGING STATION	
T40	HAND DRYER	
T50	WASTE RECEPTACLE	

TOILET ACCESSORY SCHEDULE - KEYED NOTES:
1. OWNER FURNISHED/ CONTRACTOR INSTALLED ACCESSORY

GENERAL TOILET ACCESSORY SCHEDULE NOTES:
A. INTEGRAL PARTITION BLOCKING REQUIRED AT ALL PARTITION MOUNTED ACCESSORIES.

FINISH LEGEND					
KEY	DESCRIPTION	MANUFACTURER	PRODUCT NAME	PATTERN/COLOR/SIZE	COMMENTS
FLOORING MATERIALS					
F1	RESINOUS FLOORING	TNEMEC	DECO TREAD - BROADCAST MICROFLAKE	CUSTOM COLOR	--
F2	SEALED CONCRETE	REFER TO SPECIFICATIONS	REFER TO SPECIFICATIONS	--	--
BASE MATERIALS					
B1	BASE MATERIAL	TNEMEC	DECO TREAD BROADCAST MICROFLAKES	CUSTOM COLOR	--
PAINT MATERIALS					
EP1	PAINT MATERIAL	SHERWIN WILLIAMS	MACROPOXY	SW9109 NATURAL LINEN	SEMI-GLOSS
EP2	PAINT MATERIAL	SHERWIN WILLIAMS	PRE-CATALYZED EPOXY	SWW6107 NOMADIC DESERT	SEMI-GLOSS
EP3	PAINT MATERIAL	SHERWIN WILLIAMS	PRE-CATALYZED EPOXY	SW9109 NATURAL LINEN	SEMI-GLOSS
CABINETRY AND COUNTERTOP MATERIALS					
STL1	STAINLESS STEEL COUNTERTOP	--	TYPD 304, BRUSHED	SATIN STAINLESS STEEL	--
CEILING MATERIALS					
FRP1	FRP CEILING PANEL	CRANE COMPOSITES	KEMPLY FRP LAMINATED PLYWOOD PANELS	GLASSBORD, WHITE, 5/8"	CLASS 'A'
STR	EXPOSED STRUCTURE	--	--	DO NOT PAINT	--
TRANSITION STRIPS					
TS1	TRANSITION STRIP	SCHLUTER	RENO-RAMP	SATIN ANOD. ALUM.	RESINOUS FLOOR TO CONCRETE

GENERAL FINISH LEGEND NOTES:
A. ALL HOLLOW METAL FRAMES, DOORS AND DOOR LITE TRIM TO BE EP2.
B. PROVIDE APPROPRIATE TRANSITION STRIPS AT ALL FLOORING MATERIAL CHANGES.
C. ALL MECHANICAL GRILLES TO BE FIELD PAINTED TO MATCH ADJACENT WALL. PREP GRILLE W/ LIGHT SANDING.

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pkmr
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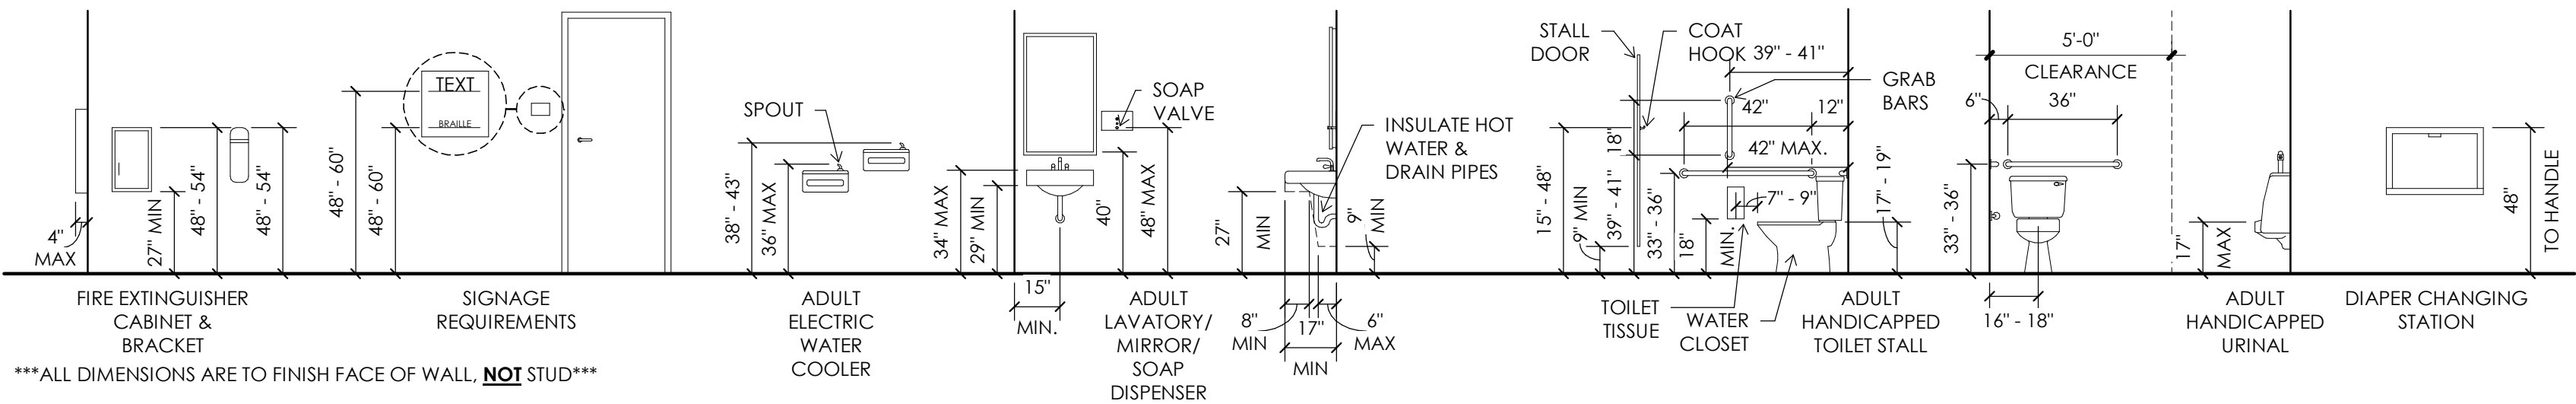


Dalyn Novak - Architect
MO # A-2011006178


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No.	Description	Date

PROJECT NUMBER: 210266-000
SET ISSUE DATE: 04/13/2022
ENGINEER: DRAWN BY: CHECKED BY:



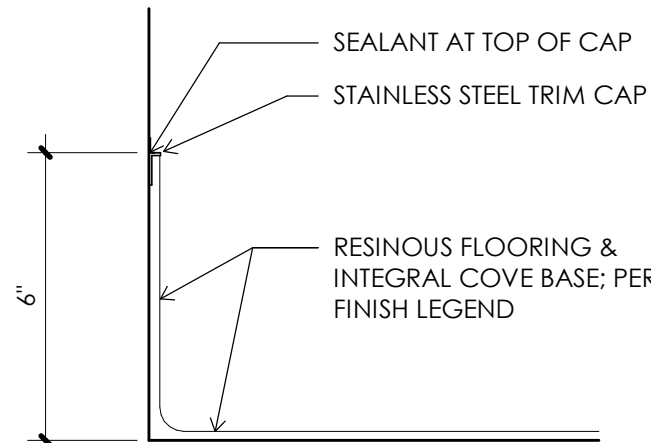A10 ADA TYPICAL MOUNTING HEIGHTS
1/4" = 1'-0"



A2 RESINOUS COVE BASE
3" = 1'-0"

PLATE RIDGE PARK - FOOTBALL
COMPLEX IMPROVEMENTS
17130 HIGHWAY 371, PLATTE CITY, MO 64079

FINISH SCHEDULE



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GENERAL SITE PLAN NOTES


1. REFER TO GENERAL NOTES ON MEP COVER SHEET FOR ADDITIONAL REQUIREMENTS OF WORK.
2. REFER TO CIVIL PLANS FOR CONTINUATION OF SERVICES BEYOND 5'-0" FROM BUILDING UNLESS OTHERWISE SHOWN.
3. REFER TO RESPECTIVE FLOOR PLANS FOR CONTINUATION OF SERVICES INSIDE BUILDING AND/OR EXACT LOCATIONS OF EQUIPMENT.
4. CONTACT UTILITY LOCATING SERVICE TO LOCATE EXACT LOCATION OF ALL EXISTING UTILITIES BELOW GRADE.

SITE PLAN KEYED NOTES

- (1) CONTINUE AS DIRECTED BY UTILITY. REFER TO CIVIL PLANS FOR CONTINUATION.
- (2) WIRE GUTTER AND DISCONNECTS FOR SMALL BLOWER AND TURBINE PUMP. VERIFY EXACT LOCATION WITH CIVIL. REFER TO CIVIL PLANS FOR FEEDER ROUTING. REFER TO RISER DIAGRAM FOR MORE INFORMATION.
- (3) (2) #3 WIRE AND (1) #8 GROUND IN 1" CONDUIT.
- (4) REFER TO POWER PLAN FOR CONTINUATION.
- (5) REFER TO RISER DIAGRAM FOR ADDITIONAL INFORMATION.
- (6) FEEDER TO BE 36" BELOW GRADE WITH WARNING TAPE ABOVE CONDUIT AT 18" BELOW GRADE.

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EXPIRES: DECEMBER 31, 2022

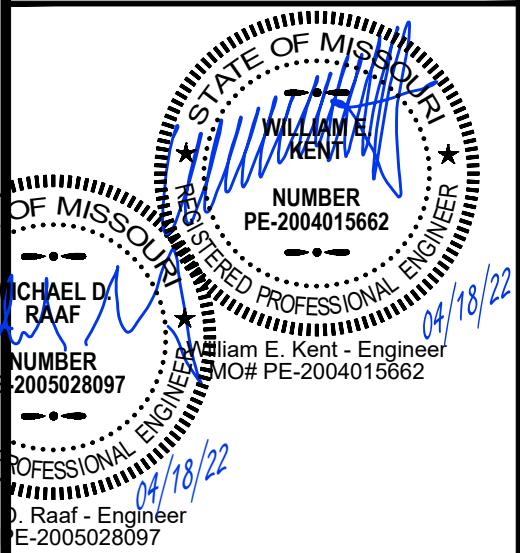

WILLIAM E. KENT
NUMBER PE-2004015662
4/18/22

MICHAEL D. RAAT
NUMBER PE-2005028997
4/18/22

Michael D. Raat - Engineer
MO# PE-2005028997



REVISIONS		
ISSUE DATE: 4/18/2022		
PROJECT INFO		
210266-000		
ENGINEER	DRAWN BY	CHECKED BY
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PLATTE RIDGE PARK
FOOTBALL COMPLEX IMPROVEMENTS
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SITE PLAN

DRAWING NO.

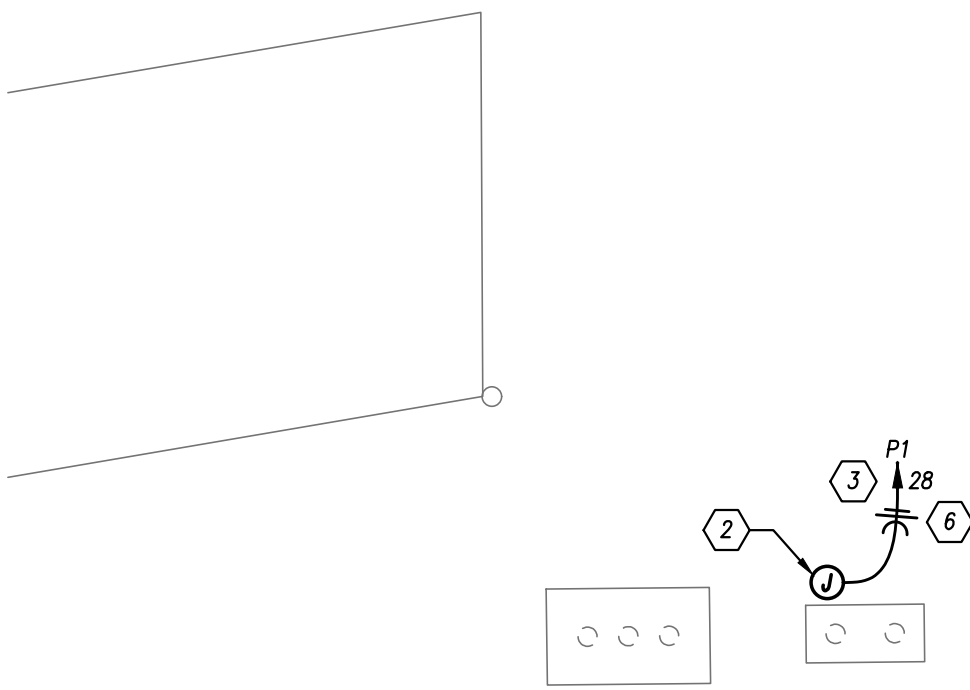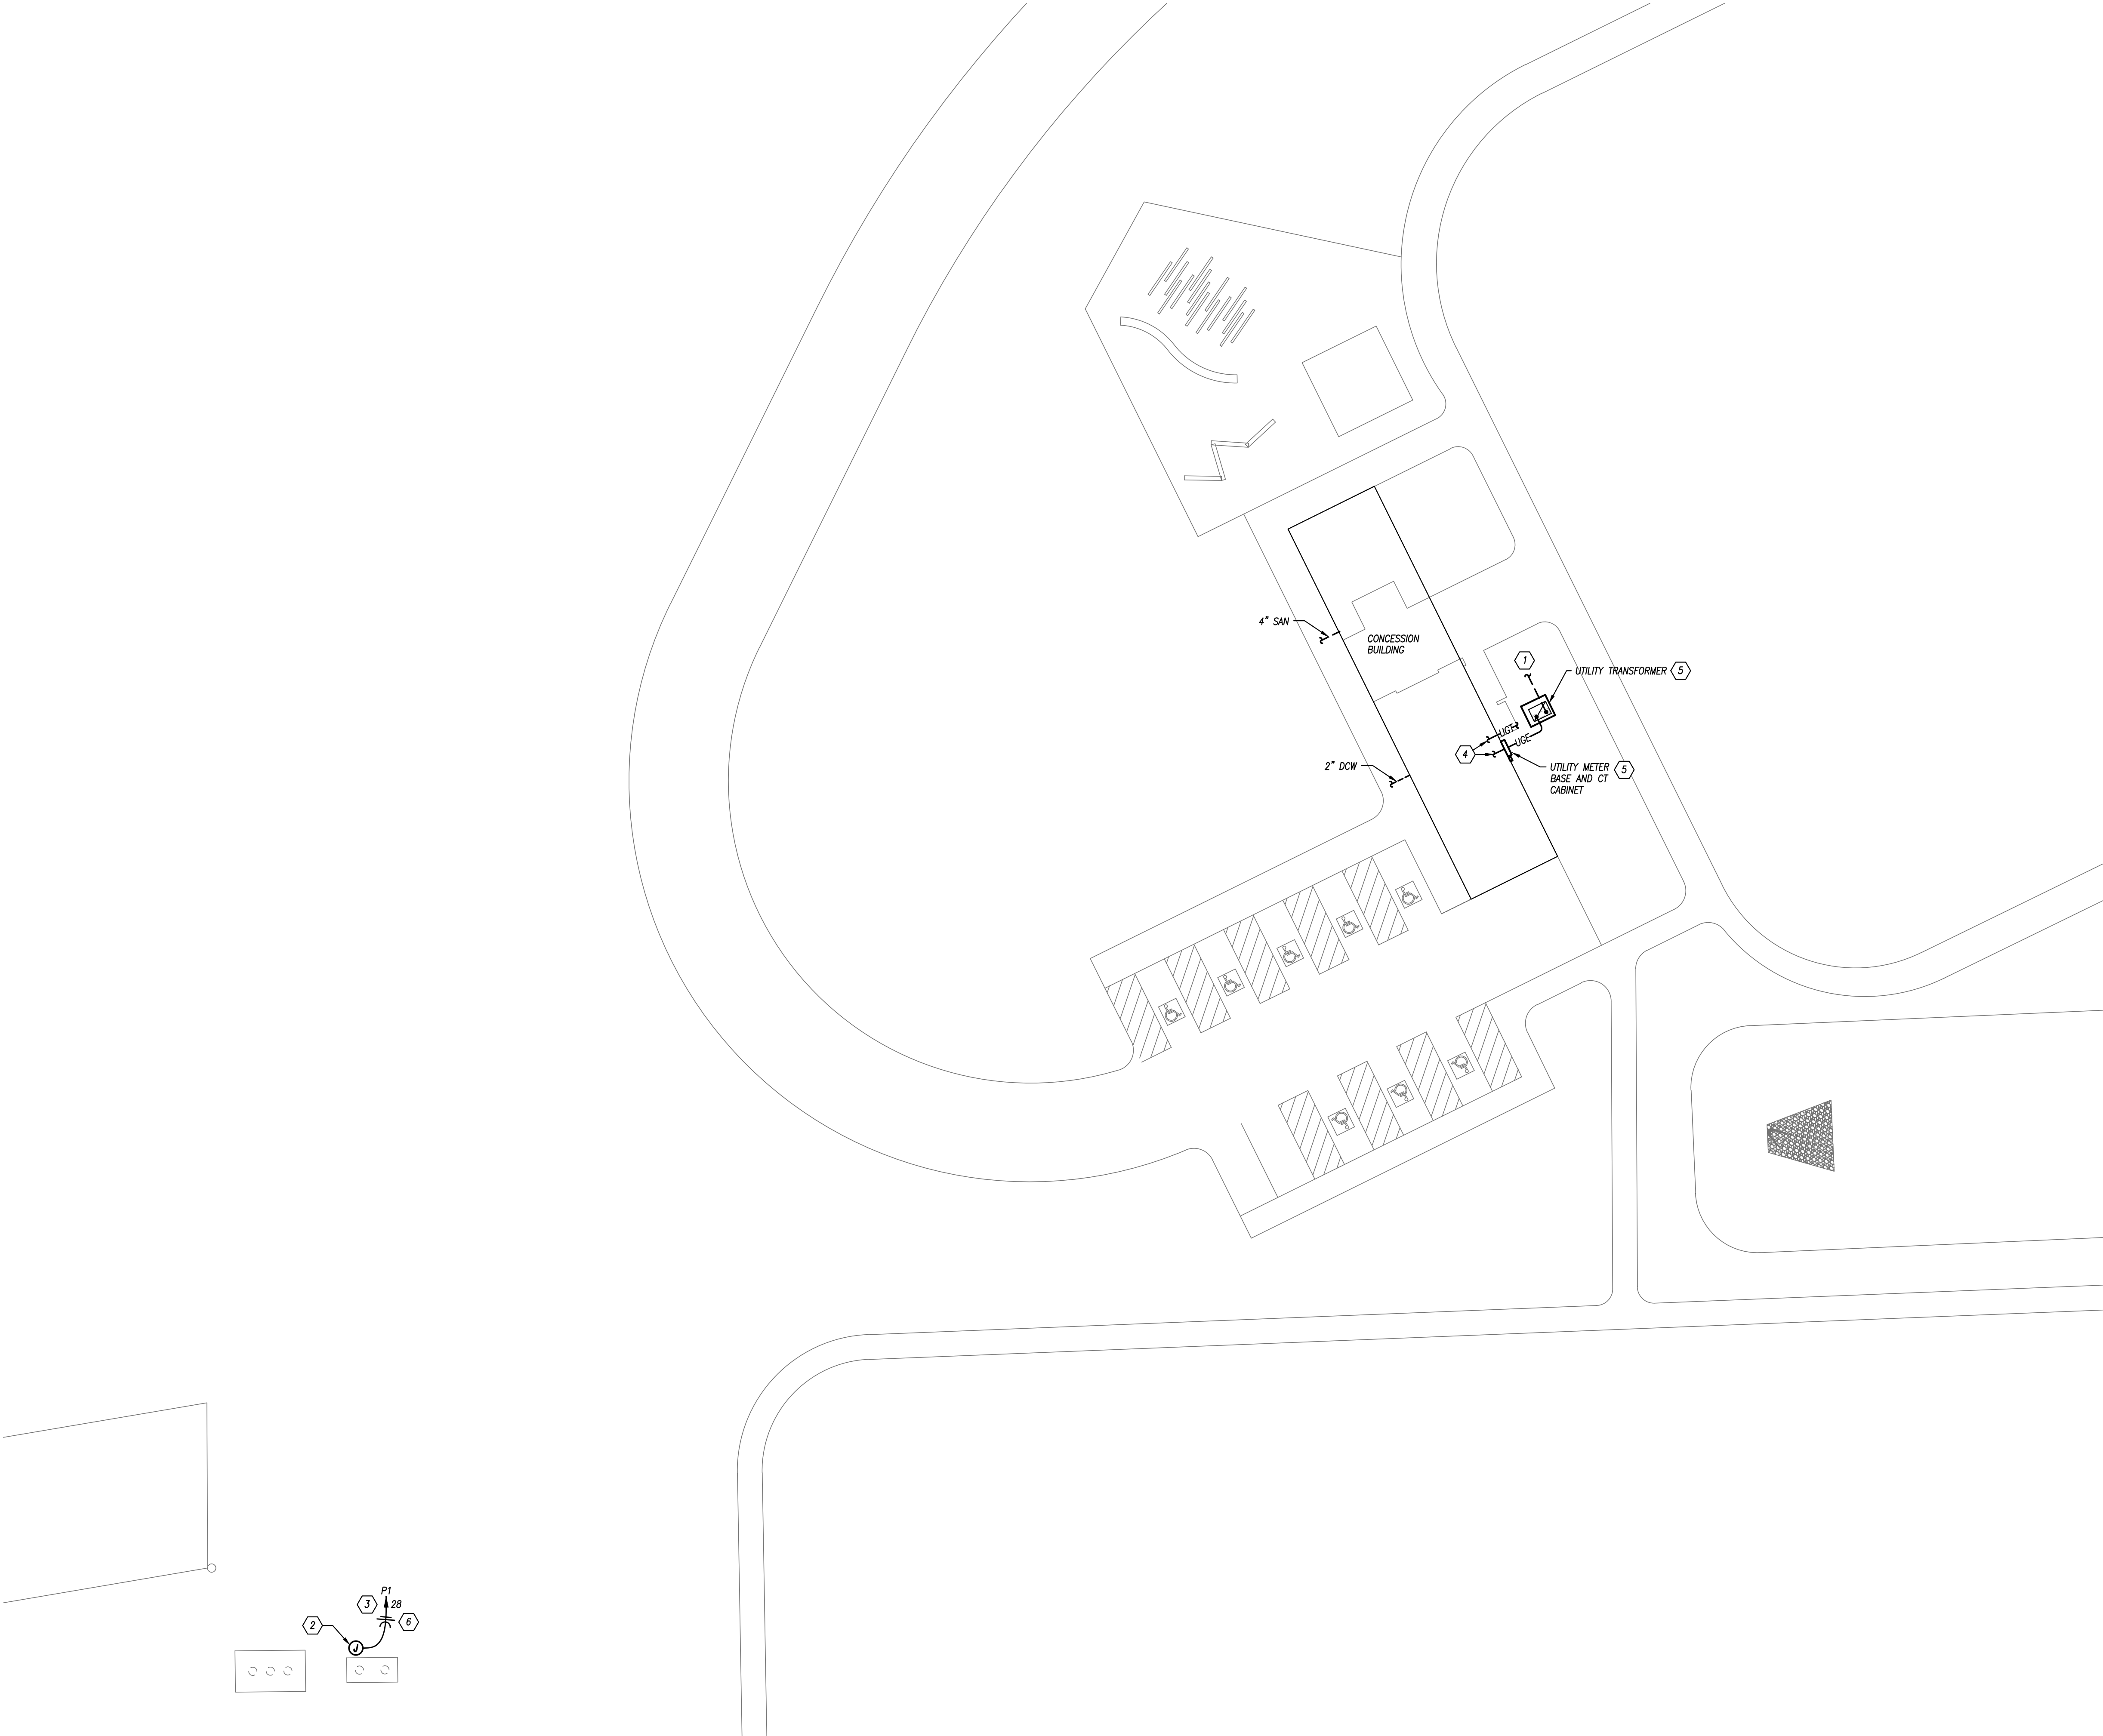MEP.1





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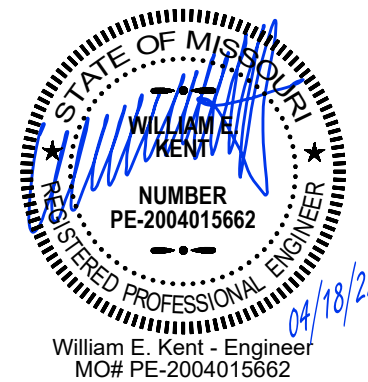
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PLATTE RIDGE PARK
FOOTBALL COMPLEX IMPROVEMENTS
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FLOOR PLAN - HVAC

Z:\22\22.113\DRAWINGS\22113 - M101.DWG


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GENERAL HVAC NOTES


1. REFER TO GENERAL NOTES ON MEP COVER SHEET FOR ADDITIONAL REQUIREMENTS OF WORK.
2. ROUND BRANCH DUCT RUNOUTS AND FLEXIBLE DUCT SHALL BE THE SAME SIZE AS THE DIFFUSER NECK UNLESS NOTED OTHERWISE.
3. MAXIMUM FLEXIBLE DUCT LENGTH SHALL BE 5'-0".
4. ALL AIR DISTRIBUTION DEVICES SHALL HAVE LOCKABLE VOLUME CONTROL DEVICES.
5. ALL 90 DEGREE TURNING ELBOWS SHALL BE SMOOTH ROUND OR SQUARE WITH TURNING VANES.
6. DUCT SIZES SHOWN ON PLANS ARE INSIDE FREE AREA.

HVAC PLAN KEYED NOTES

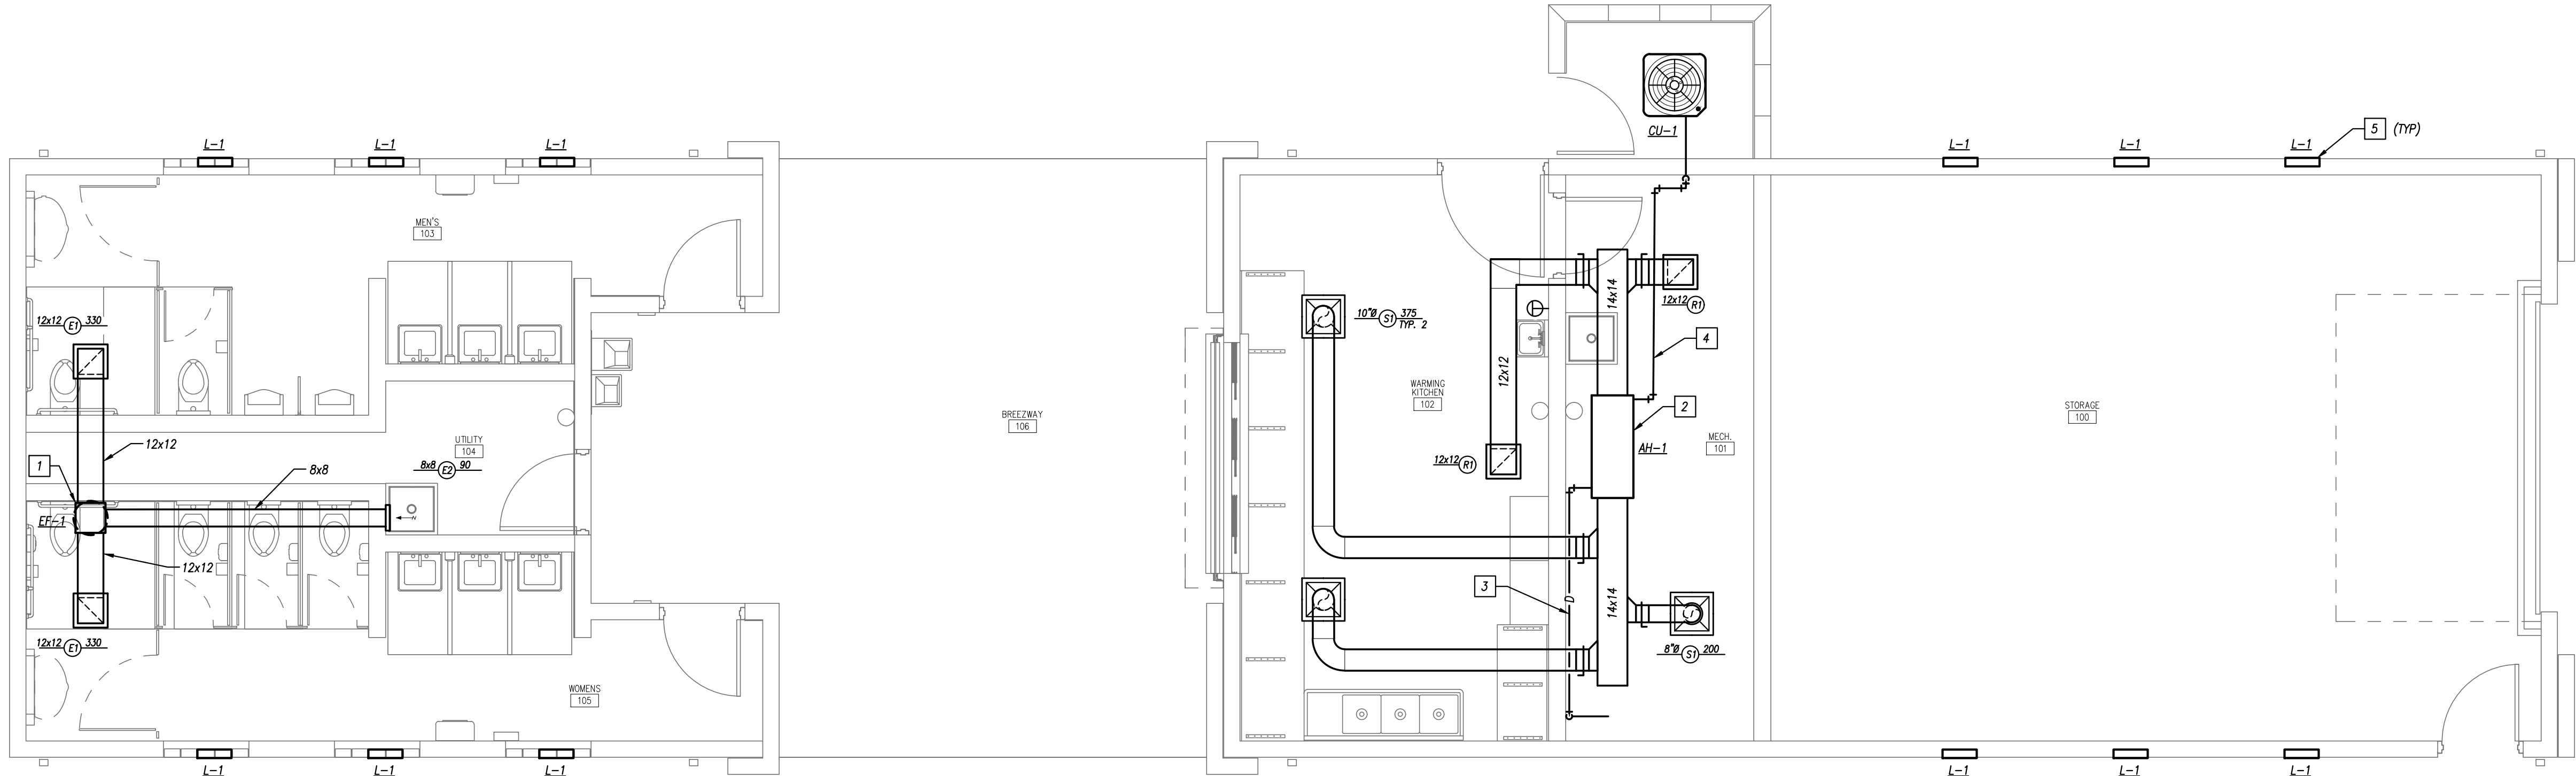- 1 14x14 EXHAUST AIR DUCT UP TO FAN ON ROOF.
- 2 INSTALL AIR HANDLER ABOVE CEILING. PROVIDE ACCESS DOOR FOR MAINTENANCE.
- 3 ROUTE DRAIN PIPING TIGHT TO WALL AND TERMINATE AT FLOOR DRAIN.
- 4 ROUTE REFRIGERANT LINESET TO CONDENSING UNIT. SIZE LINESET BASED ON MANUFACTURER'S REQUIREMENTS.
- 5 INSTALL LOUVERS IN STORAGE AT 7'-0" TO BOTTOM OF LOUVER.



FLOOR PLAN - HVAC
1/4" = 1'-0"

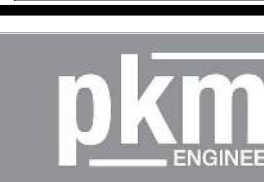

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PLATTE RIDGE PARK
FOOTBALL COMPLEX IMPROVEMENTS
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MECHANICAL - SCHEDULES & DETAILS

DRAWING NO.

M2.01



EXHAUST FAN DETAIL

CONDENSING UNIT / HEAT PUMP DETAIL

DIFFUSER SCHEDULE

GENERAL REMARKS:

1. PROVIDE ALL GRD WITH ALL NECESSARY MOUNTING HARDWARE.
2. PROVIDE GRD WITHOUT SCREWHOLES WHEN INSTALLED IN LAY-IN CEILINGS
3. VERIFY CEILING CONFIGURATION, COLOR AND SPECIFICS WITH ARCHITECTURAL CEILING PLANS.

NOTES:

1. PROVIDE WITH INSULATED PLENUM
2. LENGTH AS INDICATED ON PLANS.
3. PROVIDE ROUND NECK ADAPTER WHERE SHOWN WITH ROUND CONNECTION.
4. COORDINATE FINISH WITH ARCHITECT. PROVIDE GALVANIZED OR MILL FINISH WHERE DUCTWORK IS NOT TO BE PAINTED. PROVIDE PRIMED PAINTABLE FINISH WHEN DUCTWORK IS TO BE PAINTED.

HVAC PIPING MATERIAL SCHEDULE

NOTES:

1. ALL PIPING AND MATERIALS IN PLENUMS MUST MEET ASTM E84 FLAME/SMOKE RATING OF 25/50.
2. ALL INSULATION THICKNESSES SHALL MEET ASHRAE 90.1 - 2007 REQUIREMENTS AT A MINIMUM.
3. REFER TO SPECIFICATIONS FOR MORE DETAILED INFORMATION.

EXHAUST FAN SCHEDULE

REMARKS:

1. UNIT SHALL BE PROVIDED WITH SOLID STATE SPEED CONTROL MOUNTED AT FAN.
2. UNIT SHALL BE CONTROLLED VIA SWITCH. REFER TO ELECTRICAL DRAWINGS FOR LOCATION.

DUCTWORK INSULATION SCHEDULE

NOTES

1. PROVIDE LINER ONLY WITHIN 10' OF FAN FOR ACCOUSTICS.

GENERAL REMARKS (APPLICABLE TO ALL TYPES):

- 1) ALL DUCTWORK, INSULATION AND MATERIALS IN PLENUMS MUST MEET ASTM E84 FLAME/SMOKE RATING OF 25/50
- 2) ALL INSULATION THICKNESSES SHALL MEET ASHRAE 90.1 - 2016 REQUIREMENTS AT A MINIMUM.
- 3) REFER TO SPECIFICATIONS FOR MORE DETAILED INFORMATION FOR INSULATION PRODUCTS AND SYSTEMS.

AIR HANDLER SCHEDULE

REMARKS:

1. CAPACITIES AND AIRFLOWS ARE MANUFACTURER'S VALUES AT RATED CONDITIONS, NOT ACTUAL OPERATING CONDITIONS.
2. AIR HANDLER SHALL BE COOLING ONLY. PROVIDE WITH TXV.
3. PROVIDE WITH DRAIN PAN UNDER AIR HANDLER, AND PROVIDE WITH FLOAT SWITCH IN PAN.
4. PROVIDE WITH FILTER.

LOUVER SCHEDULE

REMARKS:

1. PROVIDE EXTENDED SILL AND MOUNTING FRAME TO MATCH CONSTRUCTION.
2. PROVIDE COLOR AS SELECTED BY ARCHITECT FROM MANUFACTURER'S STANDARD COLORS

CONDENSING UNIT SCHEDULE

REMARKS:

1. COOLING CAPACITY BASED ON A SUCTION TEMPERATURE OF 49°F.

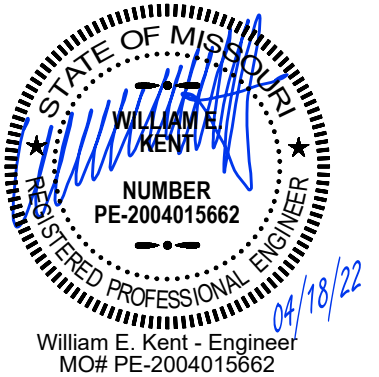


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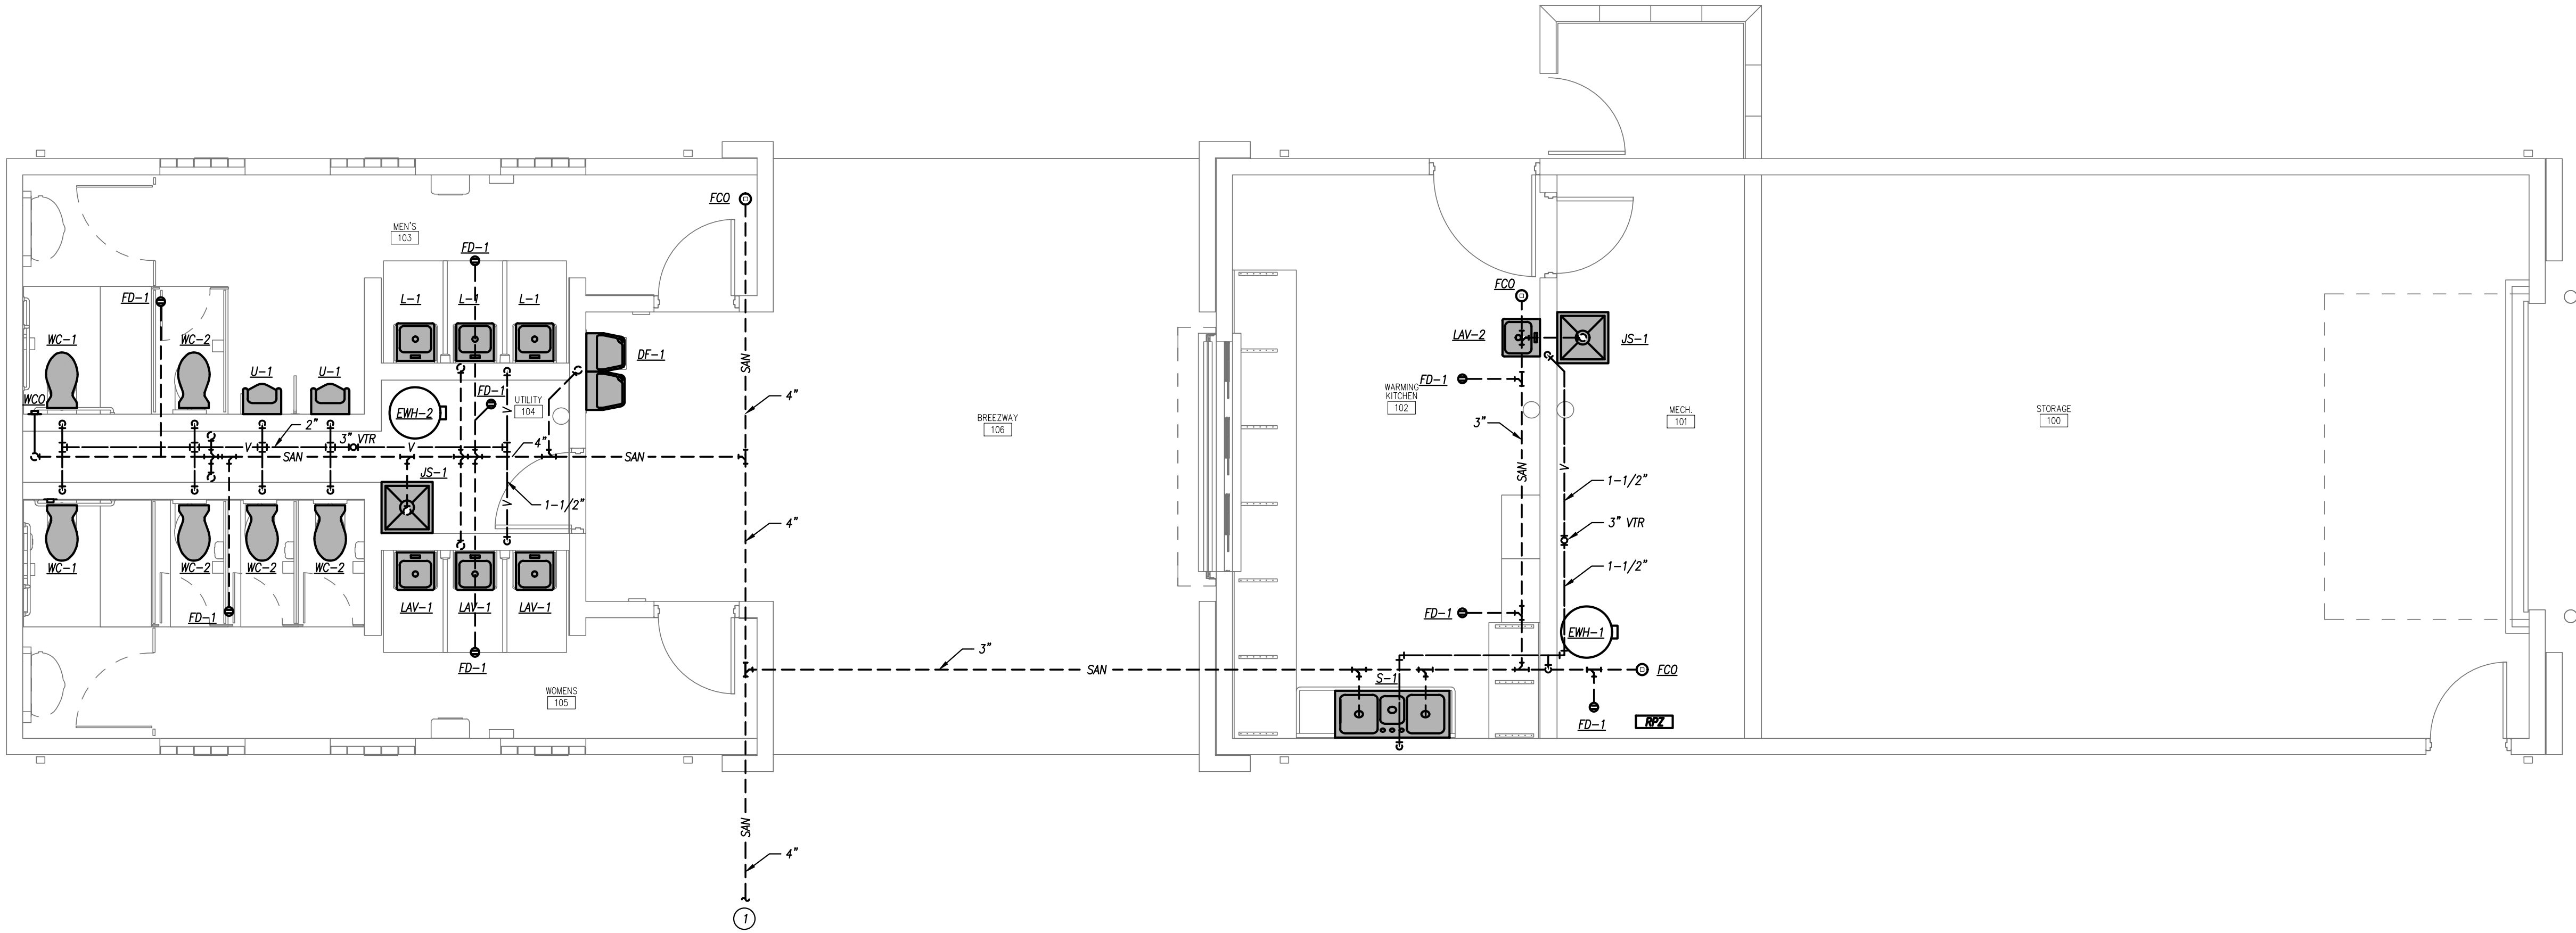


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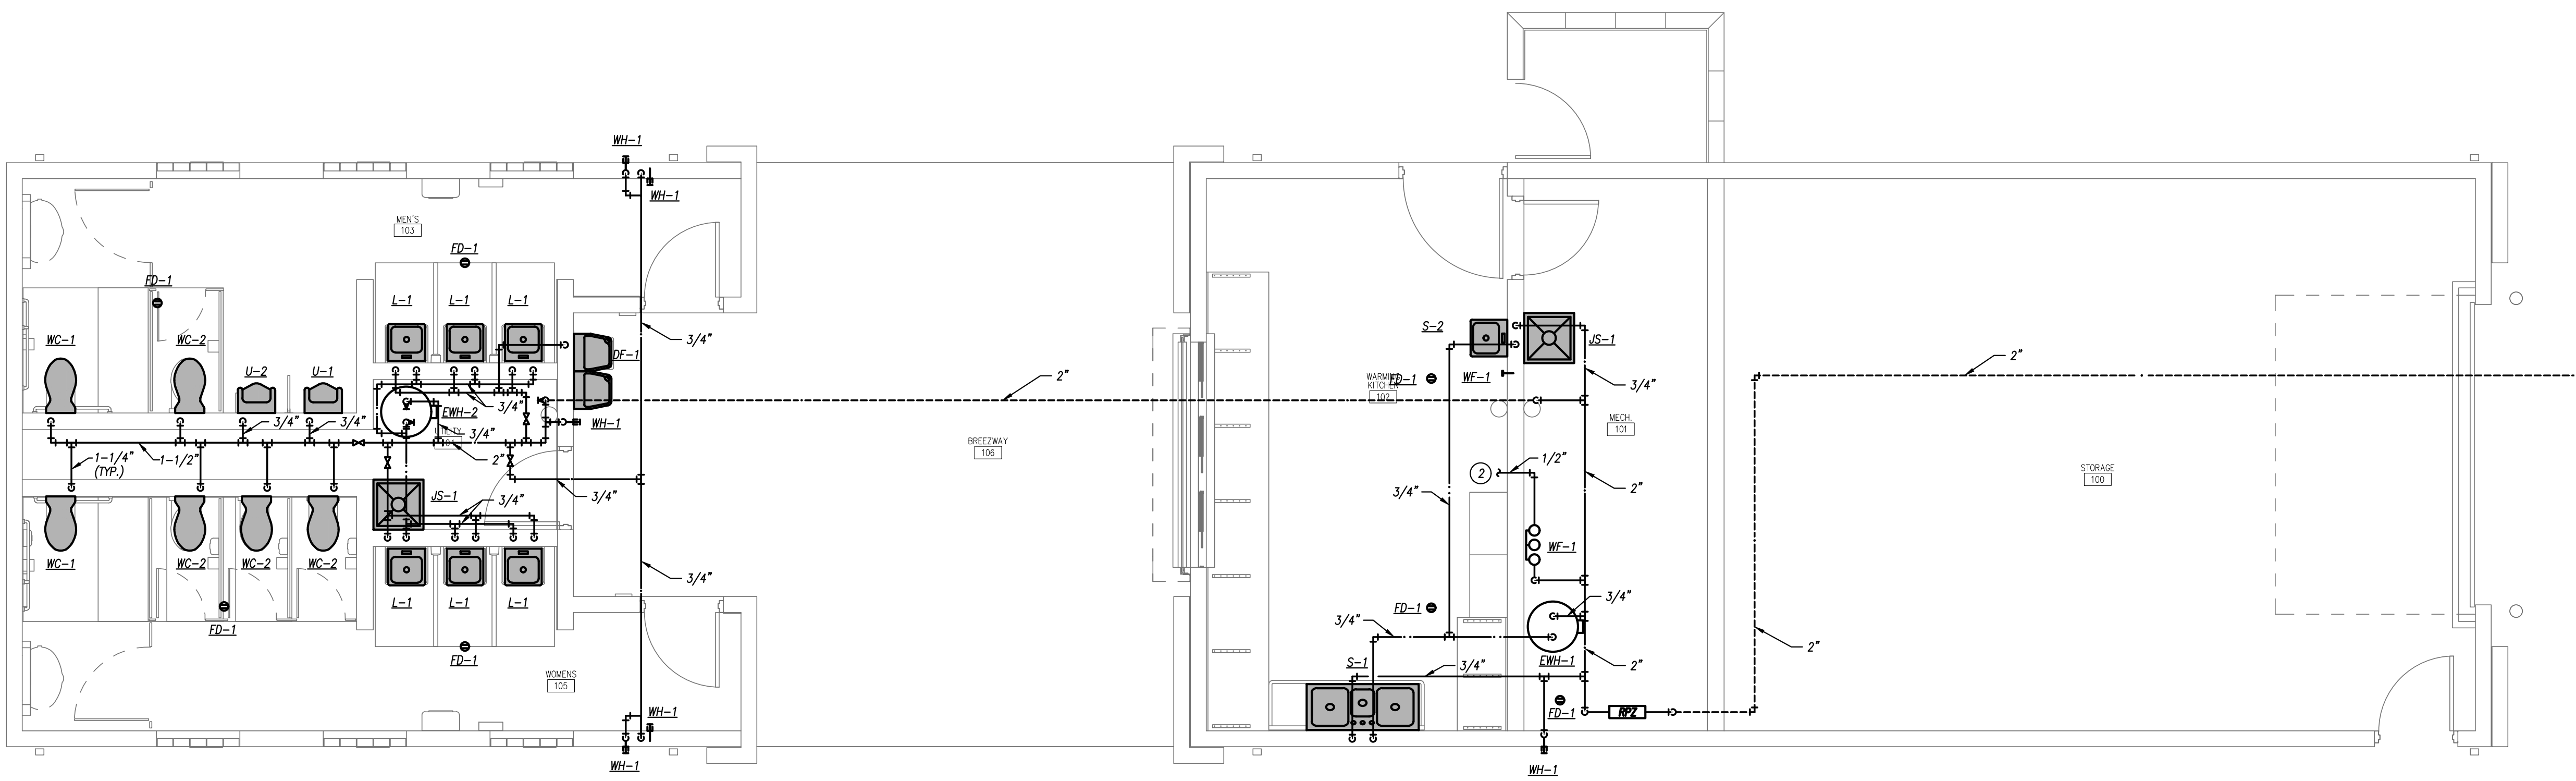
PROJECT INFO
210266-000
ENGINEER DRAWN BY CHECKED BY

PLATE RIDGE PARK
FOOTBALL COMPLEX IMPROVEMENTS
17130 HIGHWAY 371, PLATTE CITY, MO 64079
FLOOR PLAN - PLUMBING

DRAWING NO.
P1.01



FLOOR PLAN - PLUMBING - WASTE & VENT
1/4" = 1'-0"



FLOOR PLAN - PLUMBING - DOMESTIC WATER
1/4" = 1'-0"

GENERAL PLUMBING NOTES

1. REFER TO GENERAL NOTES ON MEP COVER SHEET FOR ADDITIONAL REQUIREMENTS OF WORK.
2. REFER TO PLUMBING FIXTURE / DRAIN SCHEDULES FOR PIPING SIZES FOR INDIVIDUAL CONNECTIONS TO FIXTURES AND RISERS NOT SHOWN ON PLANS.
3. NO SANITARY OR VENT PIPING BELOW GRADE SHALL BE LESS THAN 2".
4. NO DOMESTIC WATER PIPING SHALL BE SMALLER THAN 3/4" UNLESS NOTED OTHERWISE.
5. ALL VENT PIPING SHOWN IS DIAGRAMMATIC. USE APPROPRIATE FITTINGS FOR VENT PIPING BELOW FLOOD RIM OF FIXTURE.
6. NOT ALL INTERIOR CLEANOUTS ARE SHOWN FOR DRAWING CLARITY. CONTRACTOR SHALL INSTALL ALL CODE-REQUIRED CLEANOUTS (RE: GENERAL NOTES ON COVER SHEET). COORDINATE EXACT LOCATIONS OF CLEANOUTS WITH ARCHITECT.
7. INSTALL WATER PIPING SUCH THAT THE SYSTEM CAN BE DRAINED FOR WINTERIZATION OF THE BUILDING. SUPPLY DROPS SHALL DRAIN THROUGH ASSOCIATED FIXTURE VIA SHUT-OFF VALVE LOCATED AT BOTTOM OF VERTICAL DROP. MAINS SHALL SLOPE 1/4" PER FOOT AT ALL LOCATIONS ABOVE AND BELOW GRADE.
8. OWNER SHALL BE RESPONSIBLE FOR ADDING GLYCOL SOLUTION TO PLUMBING FIXTURE TRAPS TO PREVENT PIPES FROM FREEZING.
9. ALL FLOOR DRAIN TRAPS SHALL BE PROTECTED BY ONE OF THE FOLLOWING METHODS, TO BE INSTALLED AT CONTRACTOR'S DISCRETION AND IN COMPLIANCE WITH ADOPTED VERSION OF PLUMBING CODE AND/OR AHJ.
9.1. PROVIDE TRAP SEALS LISTED FOR PROPOSED USE.
9.2. PROVIDE TRAP PRIMERS. 1/2" TRAP PRIMER PIPING TO NEAREST TRAP PRIMER VALVE. PIPING SHALL BE TYPE "K" SOFT COPPER SEAMLESS WITH NO JOINTS FROM VALVE TO DRAIN.

PLUMBING PLAN KEYED NOTES

- ① REFER TO CIVIL DRAWINGS FOR CONTINUATION.
- ② CONNECTION TO ICE MAKER. PROVIDE SHUTOFF VALVE AT WALL.
- ③ 1-1/2" V, 1/2" CW, 1/2" HW DOWN TO FIXTURE.
- ④ 1-1/4" CW, 1-1/2" V DOWN TO WATER CLOSET.
- ⑤ 3/4" CW, 1-1/2" V DOWN TO URINAL.

PIPING MATERIAL & INSULATION SCHEDULE

PIPING SYSTEM		SIZE	TYPE/SCHED	MATERIAL	ACCEPTABLE FITTINGS	FIELD TEST PRESSURE/TIME	ALLOWABLE IN PLENUMS	INSULATION	
								TYPE	THICKNESS
DOMESTIC COLD WATER		1/2"-2-1/2"	L	COPPER	SOLDER, PRO-PRESS	130 PSI - 1/2HR	YES	FIBERGLASS W/ ASJ	1/2"
DOMESTIC HOT WATER & HW RETURN		1/2"-1-1/4"	L	COPPER	SOLDER, PRO-PRESS	130 PSI - 1/2HR	YES	FIBERGLASS W/ ASJ	1"
DOMESTIC HOT WATER & HW RETURN		1-1/2"-2-1/2"	L	COPPER	SOLDER, PRO-PRESS	130 PSI - 1/2HR	YES	FIBERGLASS W/ ASJ	1-1/2"
DOM. HOT & COLD BELOW GRADE		1/2"-1-1/4"	K	COPPER	CONTINUOUS TUBING, BRAZED	130 PSI - 1/2HR	YES	ELASTOMERIC	1" (HOT ONLY)
SOIL & WASTE ABOVE GRADE		2"-8"	SCH. 40	PVC	SOLVENT JOINED	10 FT - 1/2HR	NO	----	----
SOIL & WASTE BELOW GRADE		2"-8"	SCH. 40	PVC	SOLVENT JOINED	10 FT - 1/2HR	NO	----	----
DRINKING FOUNT. DRAIN		ALL	----	----	----	----	YES	ELASTOMERIC	1/2"
RPZ AND SIMILAR EXPOSED DRAIN LINES		ALL	L	COPPER	SOLDER, PRO-PRESS	10 FT - 1/2HR	YES	----	----
CONDENSATE DRAIN INTERIOR		1/2"-2"	L	COPPER	SOLDER, PRO-PRESS	10 FT - 1/2HR	YES	FIBERGLASS W/ ASJ	1/2" (PLENUM ONLY)
DOM. WATER SERVICE BELOW GRADE		1"-3"	K	COPPER	CONTINUOUS TUBING, BRAZED	130 PSI - 1/2HR	YES	----	----
DOM. WATER SERVICE BELOW GRADE		1"-3"	DR 9	HDPE	CONTINUOUS TUBING, FUSED	130 PSI - 1/2HR	NO	----	----

NOTES
1. ALL INSULATION THICKNESSES SHALL MEET ADOPTED IECC AND ASHRAE 90.1 - 2016 REQUIREMENTS AT A MINIMUM.
2. REFER TO SPECIFICATIONS FOR MORE DETAILED INFORMATION.

PLUMBING FIXTURE BRANCH CONNECTION SCHEDULE

FIXTURE TYPE	TRAP	PLUMBING FIXTURE PIPE SIZES			
		WASTE	VENT	DCW	DHW
WATER CLOSET (FLUSH VALVE)	INTEGRAL	4"	2"	1"	----
URINAL (FLUSH VALVE)	INTEGRAL	2"	2"	3/4"	----
FLUSH TANK WATER CLOSET	INTEGRAL	4"	2"	1/2"	----
LAVATORY	PROVIDE TRAP	2"	1-1/2"	1/2"	1/2"
SINK	PROVIDE TRAP	2"	2"	1/2"	1/2"
MOP SINK	PROVIDE DEEP SEAL TRAP	3"	2"	1/2"	1/2"
FLOOR DRAIN	PROVIDE DEEP SEAL TRAP	AS SCHEDULED	1-1/2"	----	----
FLOOR SINK	PROVIDE TRAP	AS SCHEDULED	1-1/2"	----	----
DRINKING FOUNTAINS/CWC'S	PROVIDE TRAP	1-1/2"	1-1/2"	1/2"	----
SHOWERS/TUBS	PROVIDE TRAP	2"	1-1/2"	1/2"	1/2"
ICE MACHINE HOOKUP BOX	----	----	----	1/2"	----
WASHER HOOKUP BOXES	PROVIDE TRAP	2"	1-1/2"	1/2"	1/2"

FLOOR / ROOF DRAIN SCHEDULE

PLAN MARK	MANUFACTURER	MODEL NUMBER	SERVICE	TOPIGRATE SIZE	WASTE SIZE	REMARKS
FD-1	WADE	1100	FLOOR DRAIN	6"Ø	2"	NOTE 1

REMARKS:
1. PROVIDE WITH NICKEL BRONZE TOP.

WATER HEATER SCHEDULE - ELECTRIC

PLAN MARK	MANUFACTURER	MODEL NUMBER	GALLONS	USE	STYLE	HEIGHT (IN)	ELEMENTS		TOTAL WATTS	RECOVERY @ 90°F RISE	VOLTAGE/ PHASE	REMARKS
EW-1	STATE		50	CONCESSIONS	STORAGE TANK	60	2	6100	6100	100	240V / 1PH	NOTES 1,2
EW-1	STATE		50	RESTROOMS	STORAGE TANK	60	2	6100	6,100	100	240V / 1PH	NOTES 1,2

REMARKS:
1. PROVIDE WITH EXPANSION TANK. SUPPORT EXPANSION TANK FROM STRUCTURE.
2. MOUNT ON CONCRETE EQUIPMENT PAD.

PLUMBING FIXTURE SCHEDULE

MARK	FIXTURE MODEL	FIXTURE DESCRIPTION	FITTINGS MODEL		REMARKS	PLUMBING FIXTURE PIPE SIZES				
						WASTE	VENT	DCW	DHW	
WC-1	AMERICAN STANDARD AFWALL 3351.101	ADA-COMPLIANT, 1.6 GALLON, WALL-MOUNTED FLUSH VALVE WATER CLOSET. SIPHON JET FLUSHING ACTION. TOP SPUD AND FLAT BOLT COVERS. WHITE VITREOUS CHINA ELONGATED BOWL. MOUNT TOP OF RIM AT 17" A.F.F. PROVIDE CHAIR CARRIER, FACEPLATE AND FOOT SUPPORTS FOR HANGER AND ALL OTHER REQUIRED MOUNTING HARDWARE.	SLOAN ROYAL 111	EXPOSED WATER CLOSET FLUSH VALVE. CHROME-PLATED, METAL OSCILLATING NON-HOLD-OPEN HANDLE. 1" I.P.S. SCREWDRIVER BACK-CHECK ANGLE STOP WITH PROTECTIVE CAP. ADJUSTABLE TAILPIECE. 1.6 GPF. VACUUM BREAKER FLUSH CONNECTION AND SPUD COUPLING FOR 1-1/2" TOP SPUD. PROVIDE WALL AND SPUD FLANGES. HANDLE HEIGHT PER MANUFACTURER'S RECOMMENDATIONS AND IN ACCORDANCE WITH ADA GUIDELINES.	6	4"	2"	1-1/4"	----	
	CHURCH 9500C	WHITE, SOLID PLASTIC, OPEN-FRONT SEAT FOR ELONGATED BOWL. INTEGRAL BUMPERS. EXTERNALCHECK HINGES WITH STAINLESS STEEL POSTS.								
WC-2	AMERICAN STANDARD AFWALL 3351.101	1.6 GALLON, WALL-MOUNTED FLUSH VALVE WATER CLOSET. SIPHON JET FLUSHING ACTION. TOP SPUD AND FLAT BOLT COVERS. WHITE VITREOUS CHINA ELONGATED BOWL. MOUNT TOP OF RIM AT 15" A.F.F. PROVIDE CHAIR CARRIER, FACEPLATE AND FOOT SUPPORTS FOR HANGER AND ALL OTHER REQUIRED MOUNTING HARDWARE.	SLOAN ROYAL 111	EXPOSED WATER CLOSET FLUSH VALVE. CHROME-PLATED, METAL OSCILLATING NON-HOLD-OPEN HANDLE. 1" I.P.S. SCREWDRIVER BACK-CHECK ANGLE STOP WITH PROTECTIVE CAP. ADJUSTABLE TAILPIECE. 1.6 GPF. VACUUM BREAKER FLUSH CONNECTION AND SPUD COUPLING FOR 1-1/2" TOP SPUD. PROVIDE WALL AND SPUD FLANGES. HANDLE HEIGHT PER MANUFACTURER'S RECOMMENDATIONS AND IN ACCORDANCE WITH ADA GUIDELINES.	6	4"	2"	1-1/4"	----	
	CHURCH 9500C	WHITE, SOLID PLASTIC, OPEN-FRONT SEAT FOR ELONGATED BOWL. INTEGRAL BUMPERS. EXTERNALCHECK HINGES WITH STAINLESS STEEL POSTS.								
UR-1	AMERICAN STANDARD WASHBROOK 6590.001	ADA COMPLIANT, WALL-HUNG URINAL. WHITE VITREOUS CHINA. 3/4" TOP SPUD. 1.0 GALLON SIPHON JET FLUSHING ACTION. MOUNT FIXTURE RIM AT 17" A.F.F. PROVIDE FLOOR-MOUNTED, HEAVY-DUTY TUBULAR STEEL UPRIGHTS, ADJUSTABLE CARRIER, PLATED HANGER, AND ALL OTHER REQUIRED MOUNTING HARDWARE.	SLOAN ROYAL 186-0.5	EXPOSED URINAL FLUSH VALVE. CHROME-PLATED, METAL OSCILLATING NON-HOLD-OPEN HANDLE. 3/4" I.P.S. SCREWDRIVER BACK-CHECK ANGLE STOP WITH PROTECTIVE CAP. ADJUSTABLE TAILPIECE. 1.0GPFN. VACUUM BREAKER FLUSH CONNECTION AND SPUD COUPLING FOR 3/4" TOP SPUD. PROVIDE WALL AND SPUD FLANGES. MAXIMUM HANDLE HEIGHT PER ADA STANDARDS.	6	2"	2"	1"	----	
UR-2	AMERICAN STANDARD 6561.017	WALL-HUNG URINAL. WHITE VITREOUS CHINA. 3/4" TOP SPUD. 1.0 GALLON SIPHON JET FLUSHING ACTION. MOUNT FIXTURE RIM AT 24" A.F.F. PROVIDE FLOOR-MOUNTED, HEAVY-DUTY TUBULAR STEEL UPRIGHTS, ADJUSTABLE CARRIER, PLATED HANGER, AND ALL OTHER REQUIRED MOUNTING HARDWARE.	SLOAN ROYAL 186-0.5	EXPOSED URINAL FLUSH VALVE. CHROME-PLATED, METAL OSCILLATING NON-HOLD-OPEN HANDLE. 3/4" I.P.S. SCREWDRIVER BACK-CHECK ANGLE STOP WITH PROTECTIVE CAP. ADJUSTABLE TAILPIECE. 1.0GPFN. VACUUM BREAKER FLUSH CONNECTION AND SPUD COUPLING FOR 3/4" TOP SPUD. PROVIDE WALL AND SPUD FLANGES. MAXIMUM HANDLE HEIGHT PER ADA STANDARDS.	6	2"	2"	1"	----	
L-1	AMERICAN STANDARD 0355.012	ADA-COMPLIANT WALL-HUNG LAVATORY. 20"x18" WHITE VITREOUS CHINA BOWL WITH 4" BACK FOR USE WITH CONCEALED ARM HANGER. FAUCET HOLES COORDINATED WITH FAUCET AND TRIM. PROVIDE CONCEALED ARM CARRIER. MOUNT TOP OF RIM AT 34" A.F.F.	AMERICAN STANDARD 1340M.119	PILLAR TAP METERING FAUCET, CHROME PLATED CAST BRASS MIXING FAUCET, SINGLE HOLE. 4-3/4" SPOUT, MECHANICAL MIXING VALVE, 0.5GPM VANDAL PROOF NON-ABRATING SPRAY. CERAMIC CARTRIDGE. NO POP UP.	1,2,3,4,5	2"	1-1/2"	1/2"	1/2"	
JS-1	FIAT TSB-100	JANITORS SINK: 24"x24"x12" PRECAST TERRAZO FLOOR SERVICE SINK. STAINLESS STEEL CAP AND 2 SIDE WALL TUNG FLANGE. 3" STAINLESS STEEL CAST DRAIN AND STAINLESS STEEL STRAINER PLATE. PROVIDE STAINLESS STEEL WALL GUARDS, MOP BRACKETS, HOSE RACK.	CHICAGO FAUCET 897-CP	C.P. SERVICE SINK FITTING WITH VACUUM BREAKER, 3/4" HOSE THREAD ON SPOUT, ADJUSTABLE WALL BRACE, PAL HOOK, AND 1/2" FLANGED FEMALE ADJUSTABLE ARMS WITH INTEGRAL STOPS. CAULK BETWEEN WALL AND FLANGE WITH GE SILICONE SEALANT. 3" C.I. "P" TRAP.	----	3"	2"	1/2"	1/2"	
DF-1	HAWS 1119.14-1920	WALL MOUNTED, HEAVY DUTY, DUAL HEIGHT ADA-COMPLIANT, BARRIER-FREE, HEAVY DUTY DRINKING FOUNTAIN WITH BOTTLE FILLER. 3/16" WELDED STEEL CONSTRUCTION. 18GA STAINLESS BOWL. PROVIDE WITH CARRIER FOR WALL MOUNTING. MOUNT TRAP INSIDE OF BUILDING.	----	----	4	2"	2"	1/2"		
WH-1	ZURN Z1330XL	CONCEALED, AUTOMATIC DRAINING, ANTI-SIPHON WALL HYDRANT COMPLETE WITH NICKEL BRONZE BOX AND HINGED COVER WITH KEY, INTEGRAL BACKFLOW PREVENTER. BRASS CASING, ALL-BRONZE INTERIOR PARTS. NON-TURNING OPERATING ROD WITH FREE-FLOATING COMPRESSION CLOSURE VALVE. REPLACEABLE BRONZE SEAT AND SEAT WASHER. COMBINATION 3/4" FEMALE AND 1" MALE IP INLET CONNECTION STANDARD. INCLUDES OPERATING KEY.	----	----	----	----	----	3/4"	----	
WF-1	ZURN Z1341XL	EXPOSED LEAD FREE WALL FAUCET WITH BACKFLOW PREVENTER. 3/4" MALE HOSE CONNECTION. WHEEL HANDLE IN MECHANICAL SPACES.	----	----	----	----	----	3/4"	----	
S-1	ADVANCE TABCO	THREE-COMPARTMENT SINK WITH SIDE DRAIN BOARDS.16 GA. 304 SS SCULLERY SINK. 3 COMPARTMENTS 18" X 24" X 13-1/2" DEEP. 1-3/4" RADIUS COVED CORNERS. FULL LENGTH 8" BACKSPLASH W/ SLOPED TOP. 1-1/2" SLOPING TOP CHANNEL RIMS. REINFORCED DRAINBOARDS W/ PITCH. UNDERSIDE FULLY UNDERCOATED FOR SOUND/CONDENSATION. ALL EXPOSED SURFACES POLISHED TO A SATIN FINISH. NSF CERT.	ADVANCE TABCO	TWO HOLE DUAL HANDLE WALL MOUNT FAUCET, QUARTER TURN CERAMIC DISC CARTRIDGE. 1/2" ADJUSTABLE INLETS, SOLID BRASS CONSTRUCTION, CHROME FINISH, INCLUDES SPOUT SWING RESTRICTION PIN	----	----	----	----	----	
S-2	ADVANCE TABCO	WALL-MOUNTED SINK. 18 GA. 304 SS. 18" X 18" X 5" DEEP. 1-3/4" RADIUS COVED CORNERS. FULL LENGTH 8" BACKSPLASH W/ SLOPED TOP. ALL EXPOSED SURFACES POLISHED TO A SATIN FINISH.	ADVANCE TABCO	TWO HOLE DUAL HANDLE WALL MOUNT FAUCET, QUARTER TURN CERAMIC DISC CARTRIDGE. 1/2" ADJUSTABLE INLETS, SOLID BRASS CONSTRUCTION, CHROME FINISH, INCLUDES SPOUT SWING RESTRICTION PIN. INCLUDE SPOUT MOUNTED EYE WASH.	----	----	----	----	----	
WF-1	SPIROPURE (OR EQUAL)	3-STAGE WATER FILTER HOUSING FOR STANDARD 2.5"x10" FILTERS. OPTIONAL: 4.5"x10" FILTERS. FIRST STAGE SEDIMENT FILTER ELEMENT, 25 MICRON. SECOND STAGE ANTI-SCALE FILTER ELEMENT. THIRD STAGE ACTIVATED CARBON FILTER ELEMENT.	----	----	----	----	----	----	----	

REMARKS:
1. PROVIDE CHROME-PLATED BRASS TAILPIECE AND GRID DRAIN.
2. PROVIDE CHROME-PLATED BRASS P-TRAP.
3. PROVIDE LOOSE KEY STOPS AND FLEXIBLE RISERS.
4. PROVIDE CONCEALED ARM TYPE CARRIER WITH SQUARE, TUBULAR STEEL UP-RIGHTS AND BLOCK TYPE BASES. PROVIDE WITH SHUT OFF VALVES AND BYPASS LOOP.
5. INSULATE EXPOSED TAILPIECE, P-TRAP, AND WATER RISERS. REFER TO SPECIFICATIONS FOR INSULATION METHODS.
6. PROVIDE FLUSH VALVE HANDLE ON WIDE SIDE OF STALL.
7. PROVIDE HANDLE STOPS AND FLEXIBLE RISERS.
8. PROVIDE CHROME-PLATED BRASS TAILPIECE AND BASKET STRAINER.

GENERAL NOTES (APPLICABLE TO ALL FIXTURES):
1) ALL PUBLIC LAVATORIES AND SINKS SHALL BE PROVIDED WITH ANTI-SCALD ASSE 1070 LISTED VALVE ON HOT WATER SUPPLY.
2) VERIFY PLUMBING MATERIALS AND EQUIPMENT COORDINATE BETWEEN TRADES. VERIFY CABINET SIZES, COUNTERTOP MATERIALS, WALL THICKNESSES, ETC ARE APPROPRIATE FOR SPECIFIED EQUIPMENT PRIOR TO ORDER.



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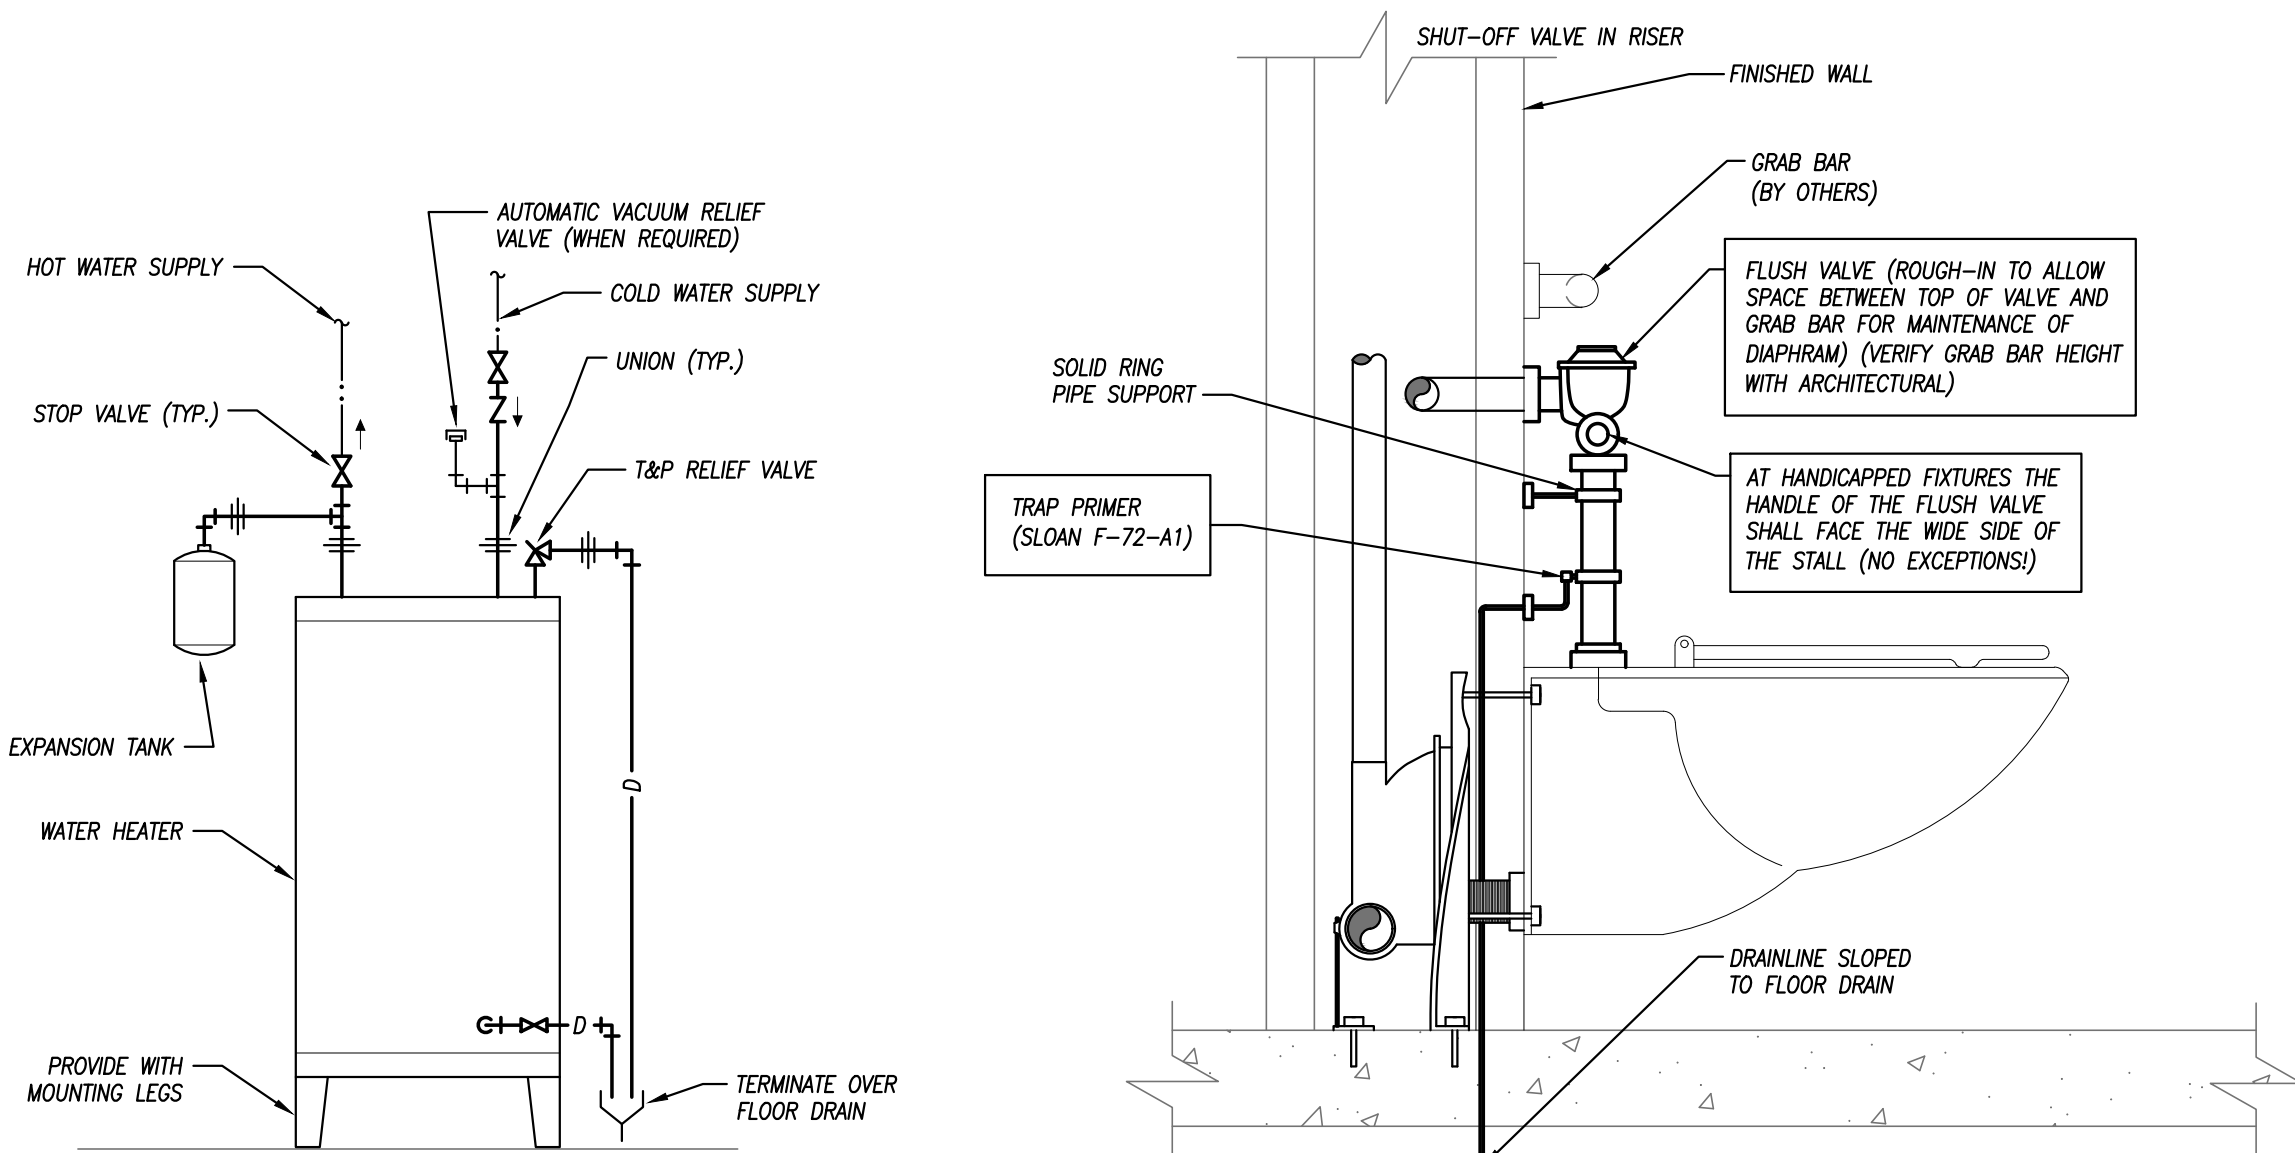
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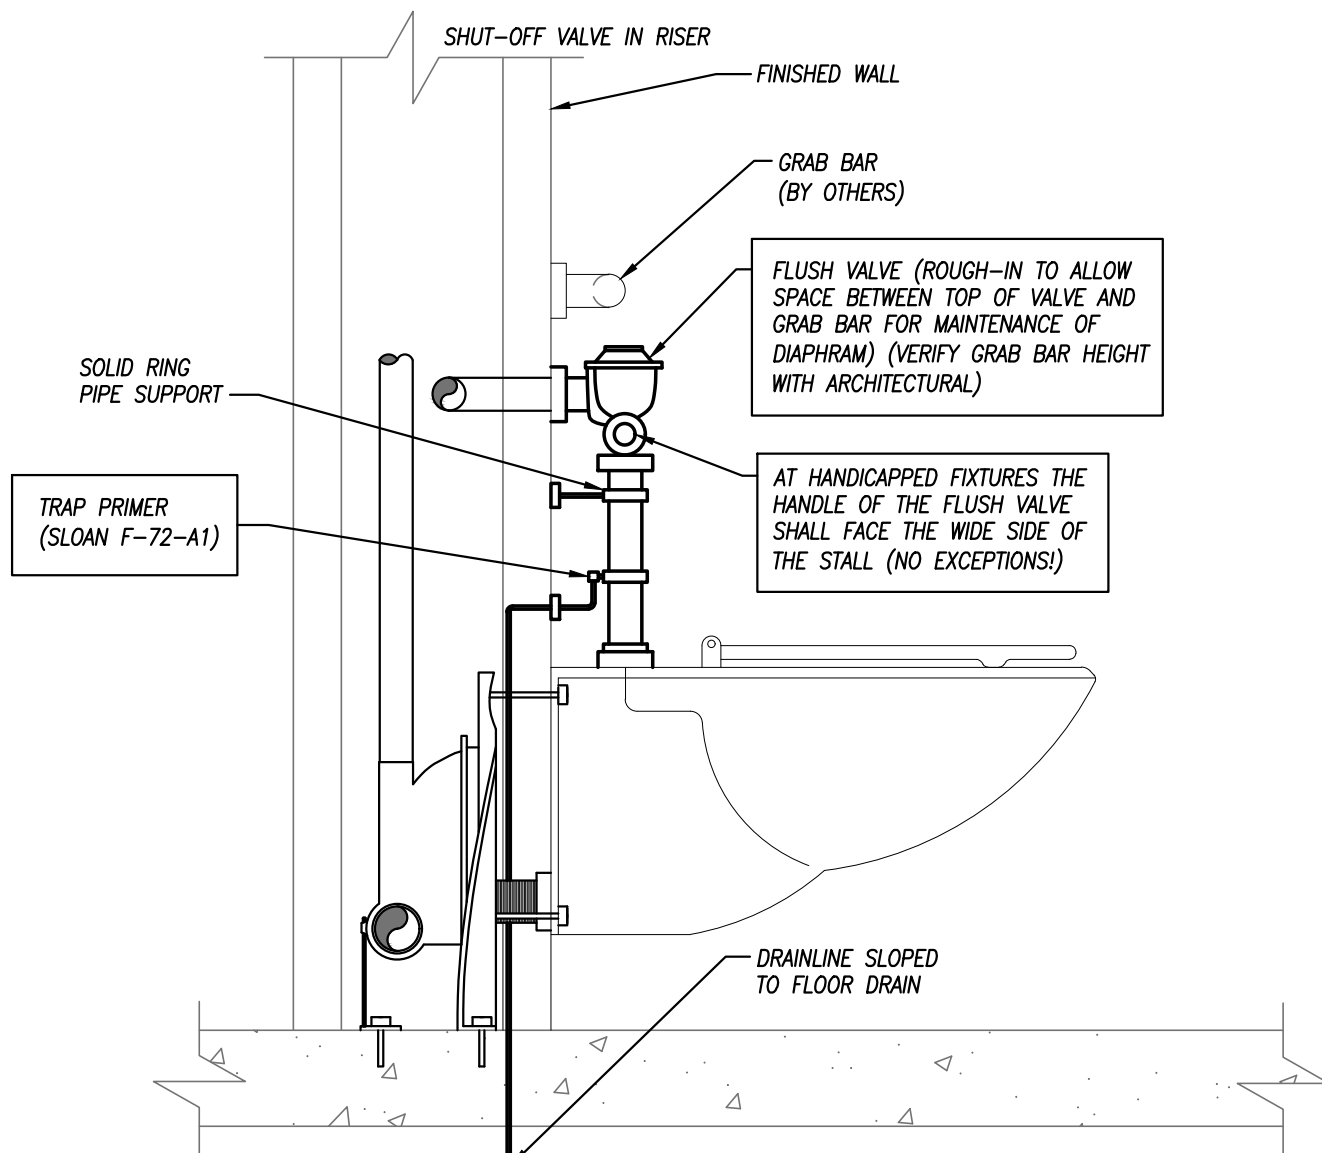
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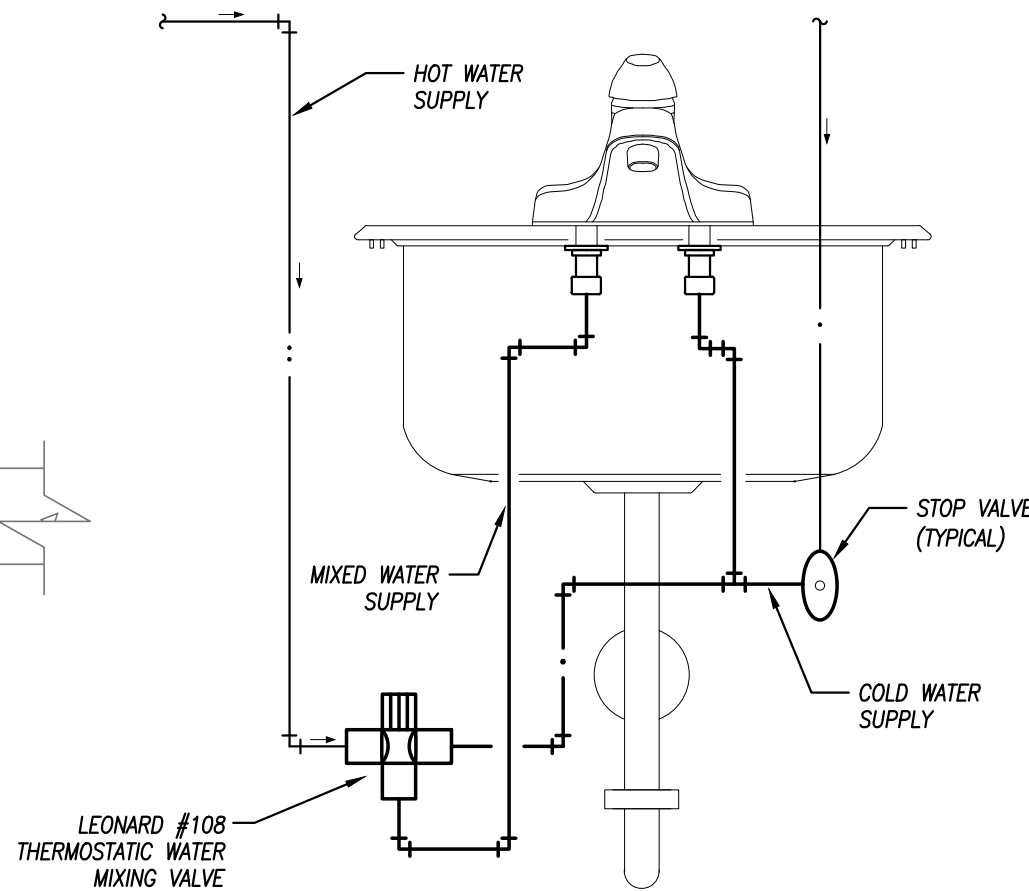
PLUMBING - SCHEDULES




ELECTRIC WATER HEATER
NOT TO SCALE



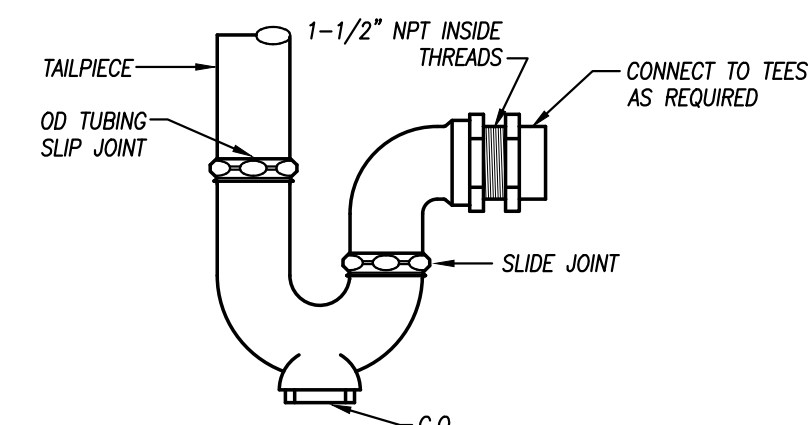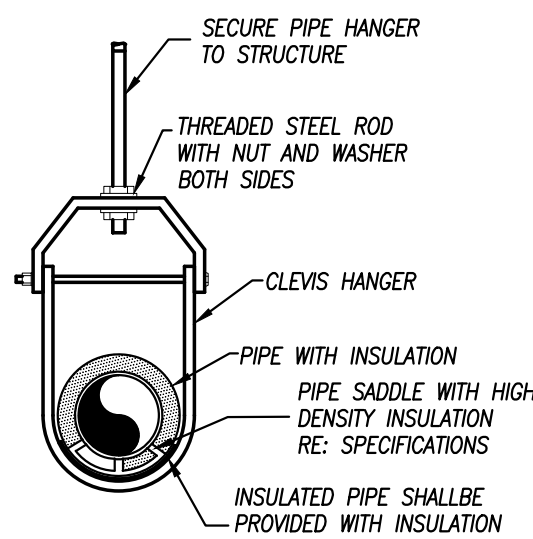
WATER CLOSET INSTALLATION DETAIL
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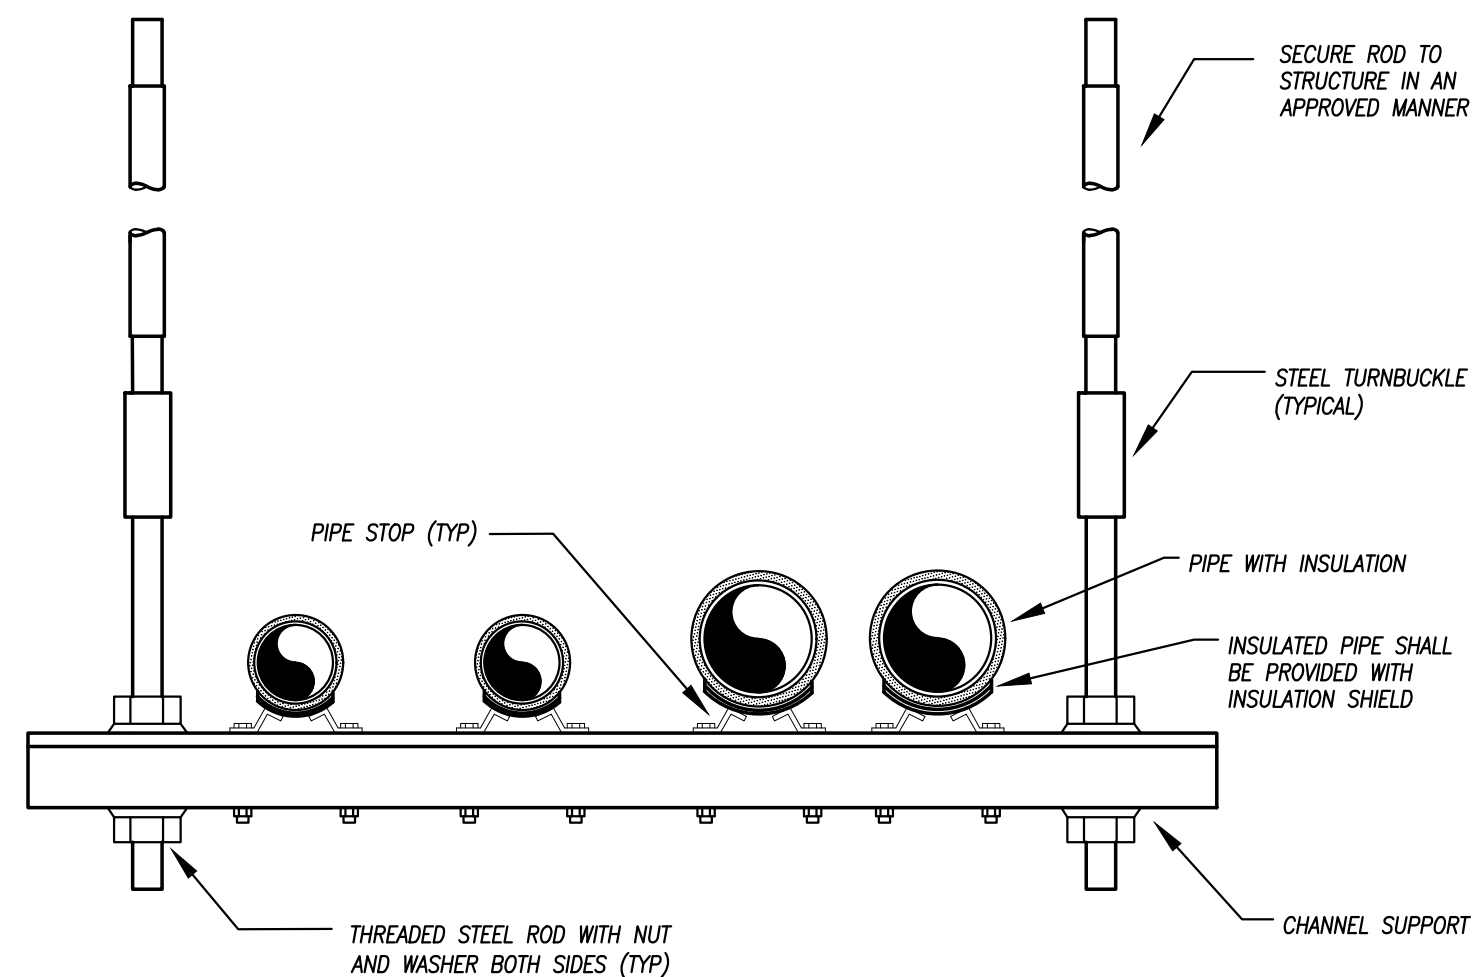
HAND WASHING SINK/LAVATORY TEMPERED WATER SCHEMATIC
NOT TO SCALE



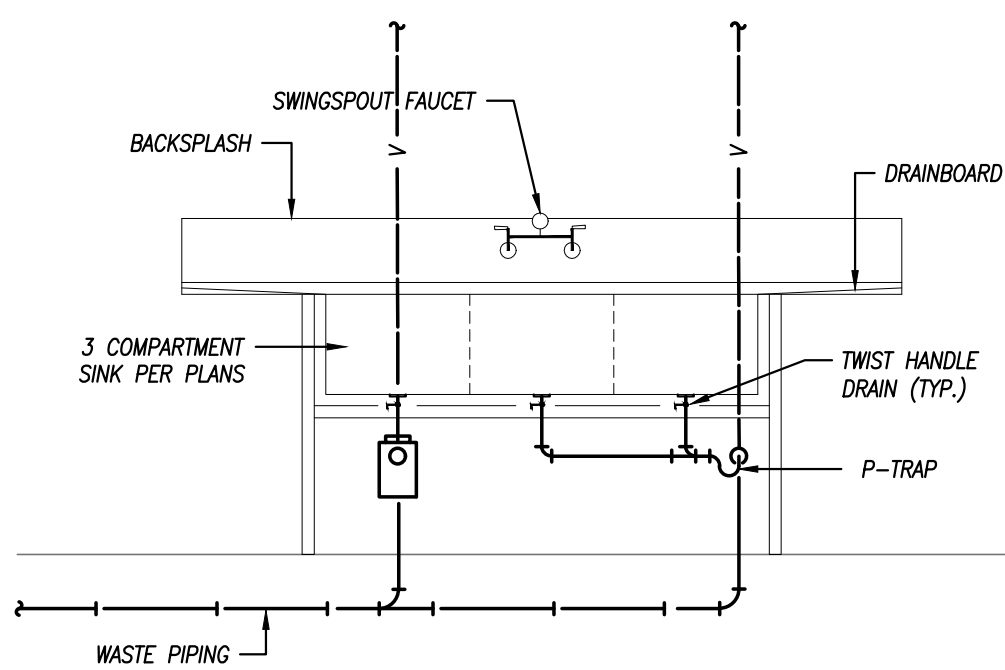
P-TRAP DETAIL
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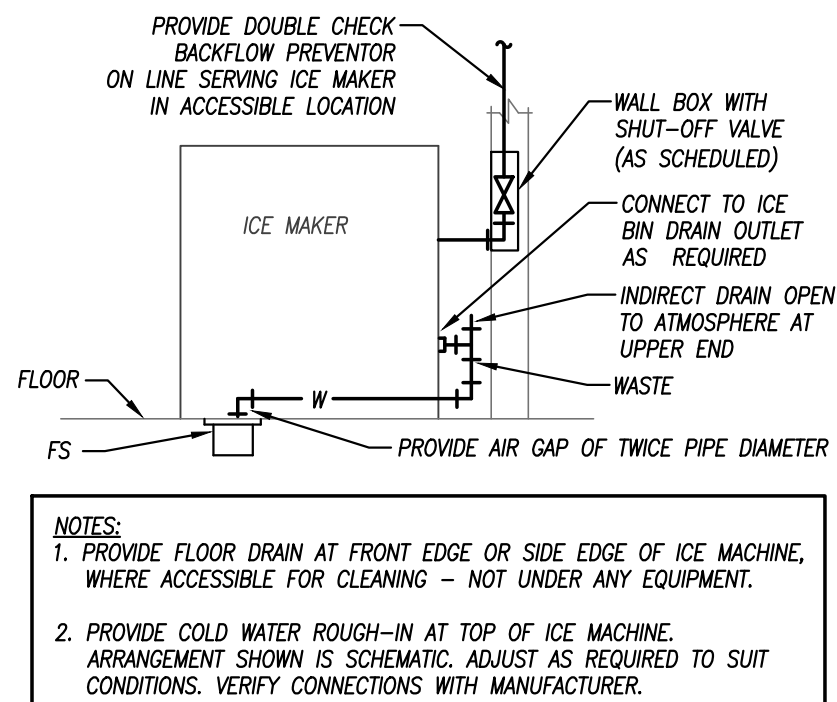
PIPE HANGER DETAIL
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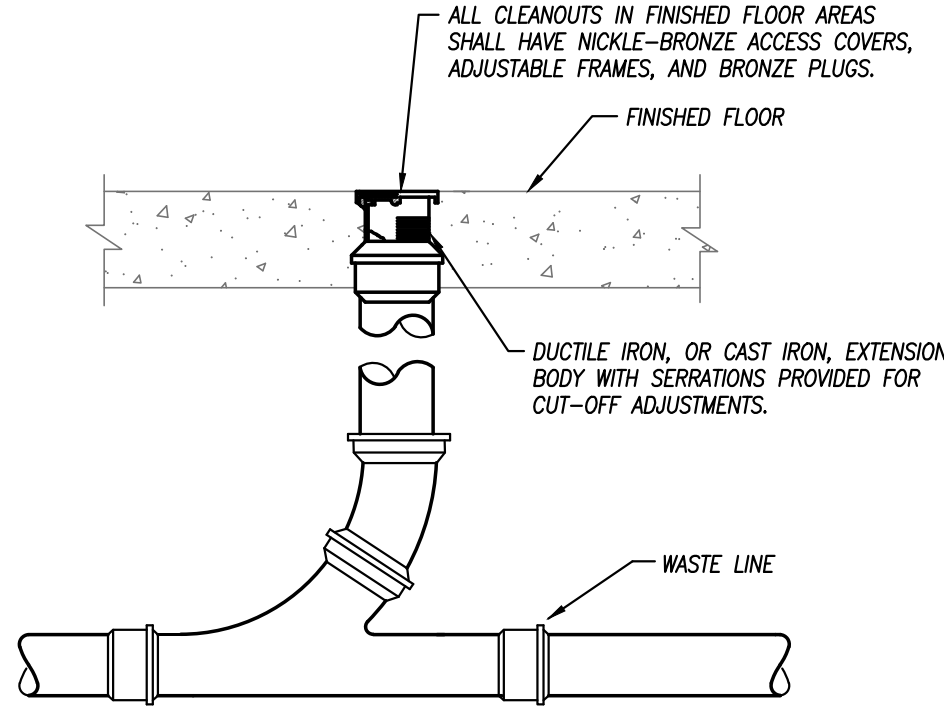
MULTIPLE PIPE TRAPEZE HANGER DETAIL
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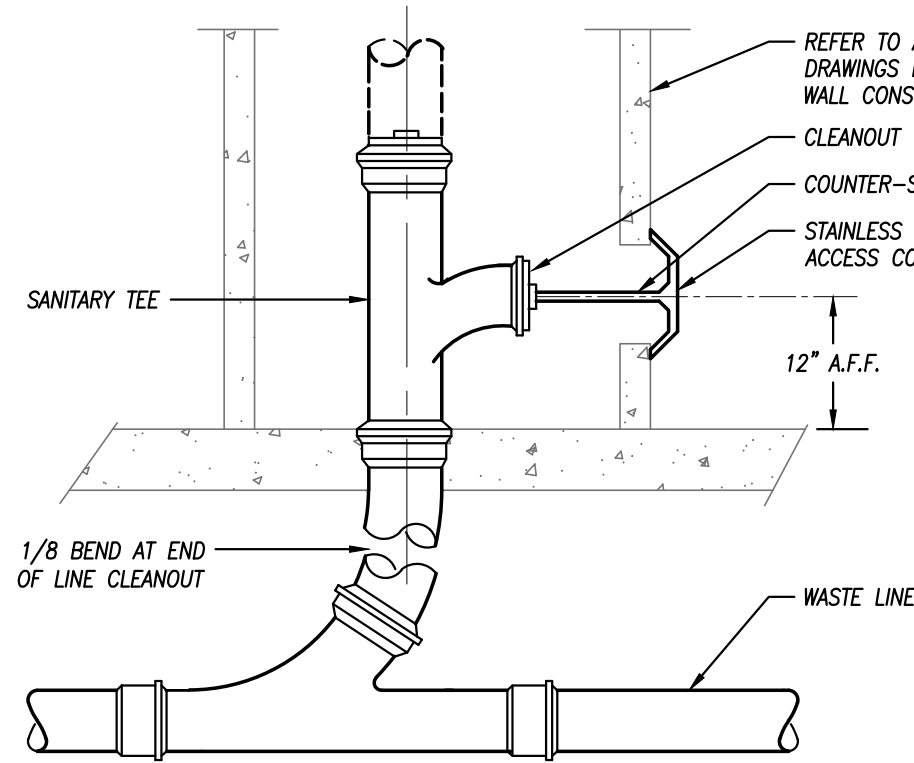
3-COMPARTMENT SINK DETAIL
NOT TO SCALE



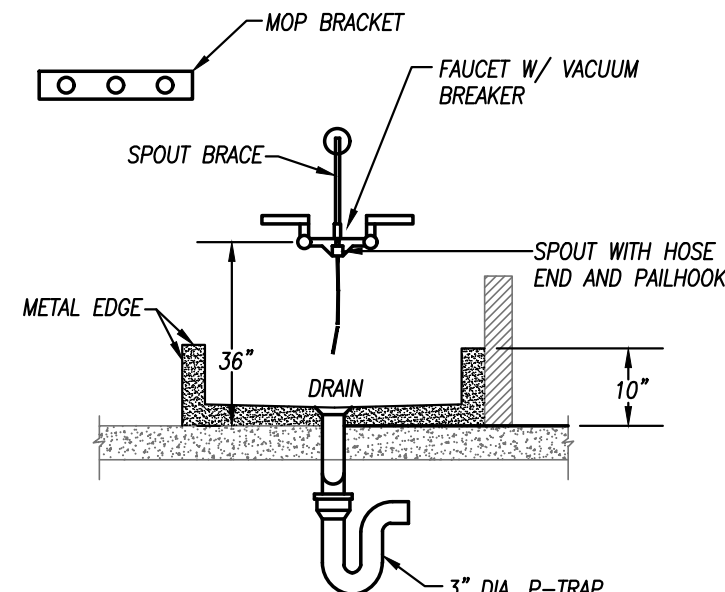
ICE MACHINE CONNECTION DETAIL
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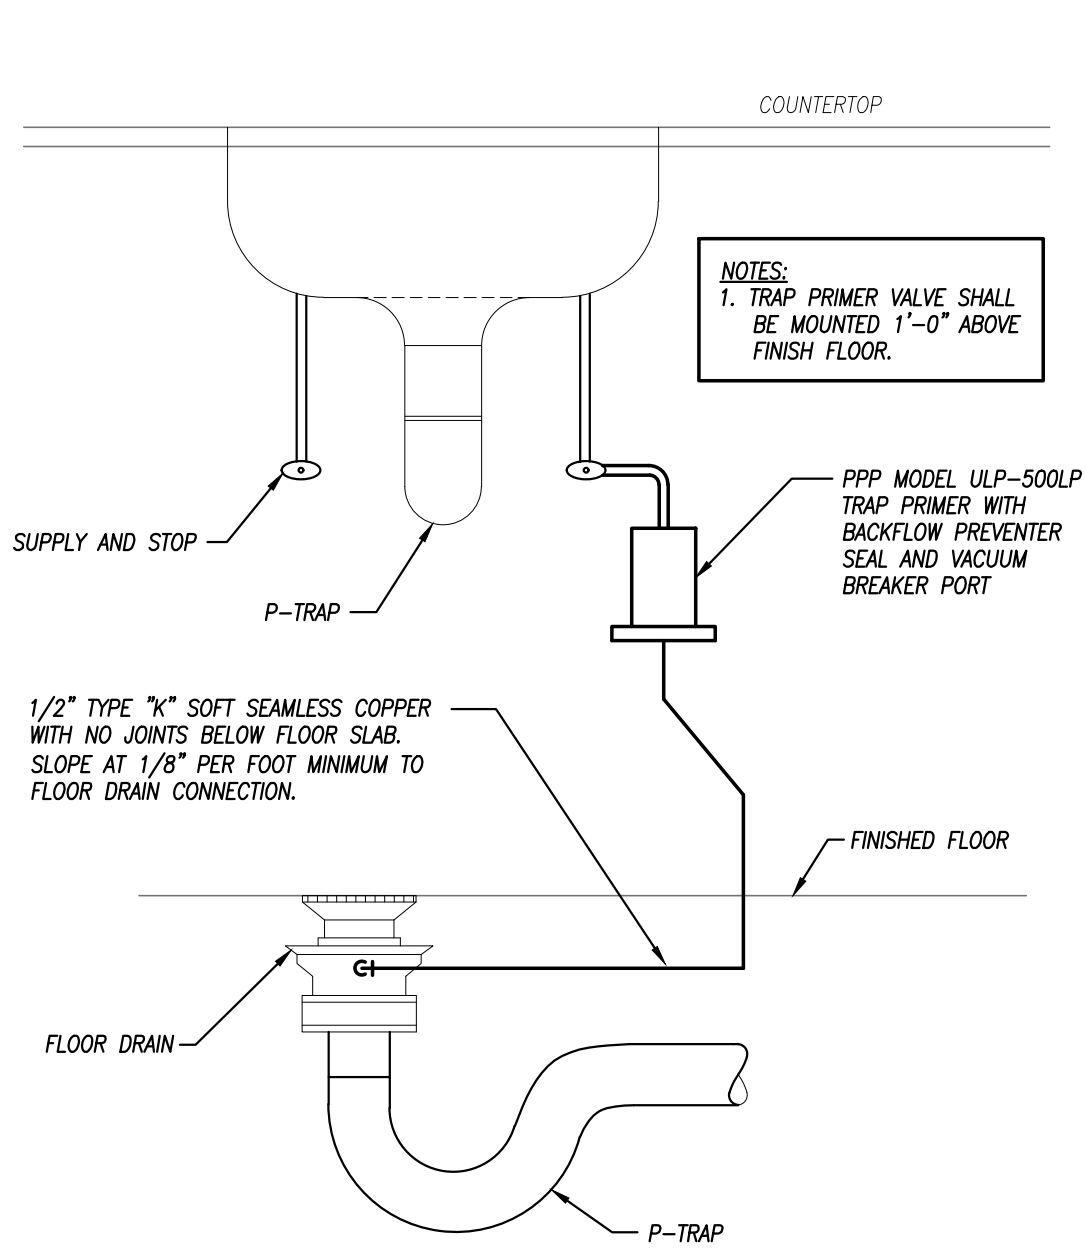
FLOOR CLEANOUT DETAIL
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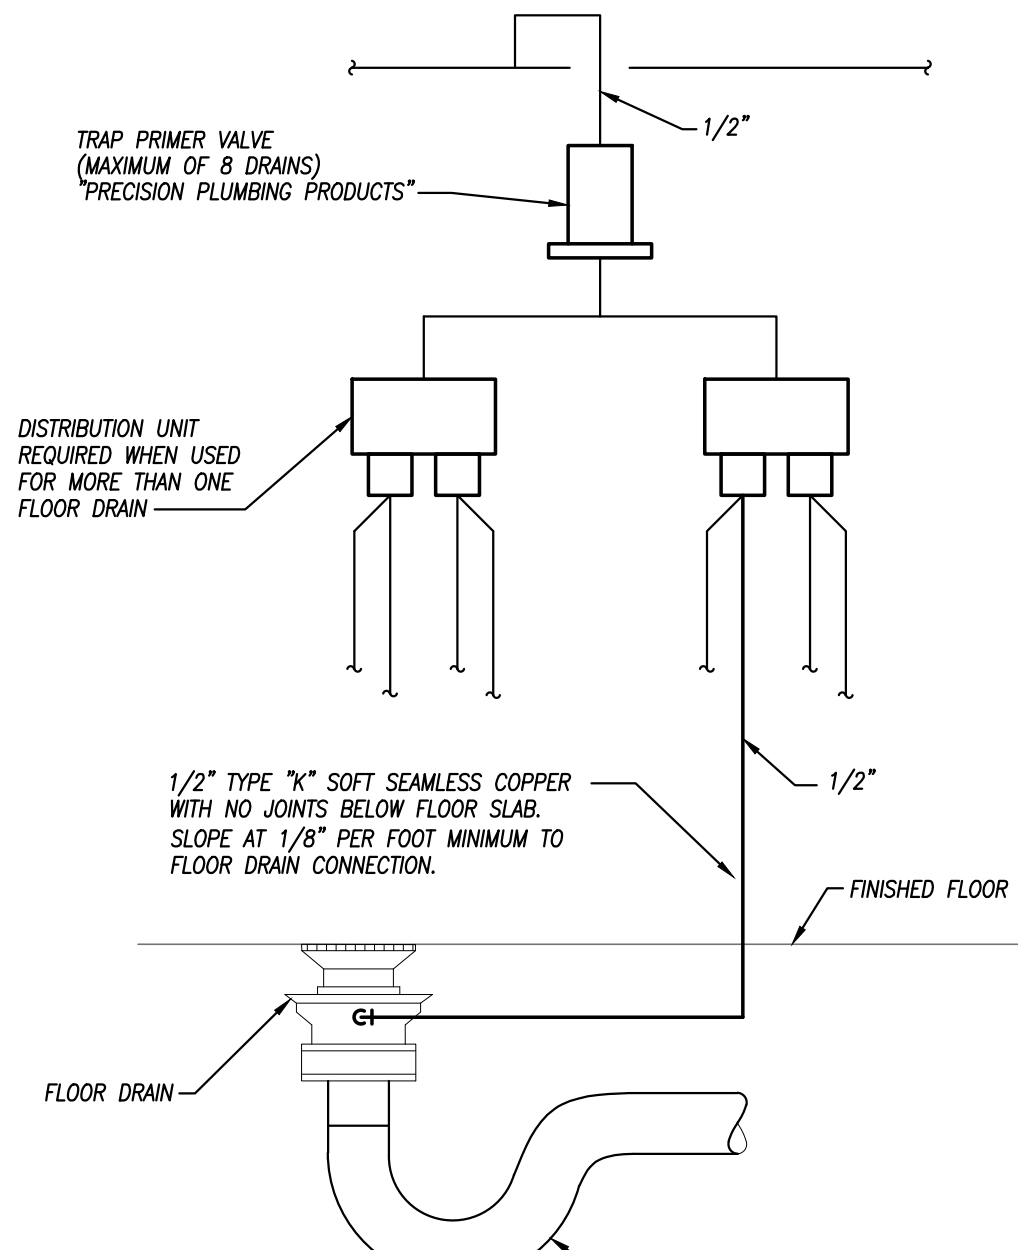
WALL CLEANOUT DETAIL
NOT TO SCALE



MOP SINK DETAIL
NOT TO SCALE

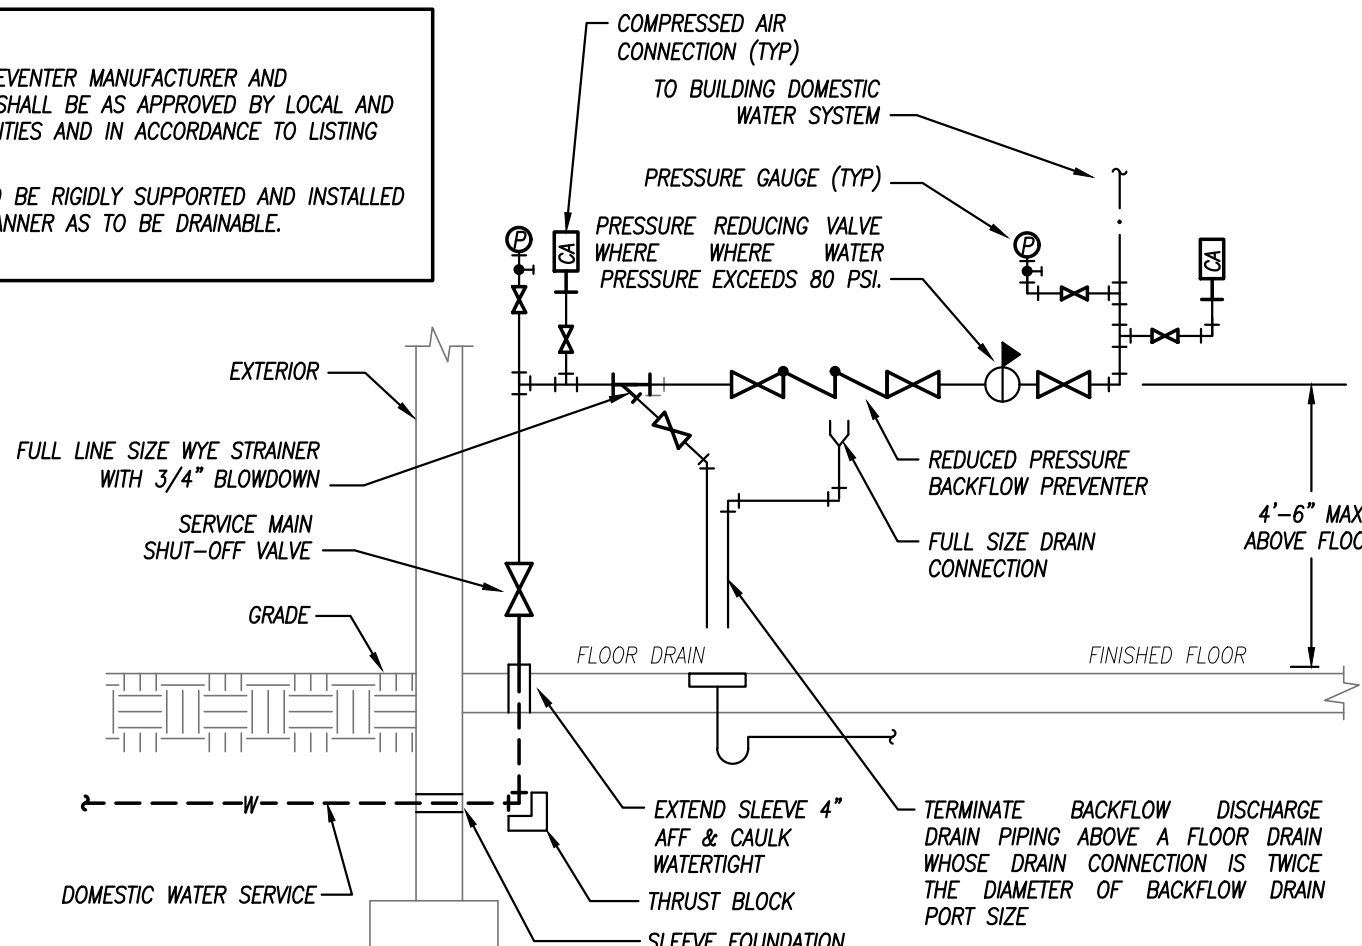


UNDER LAVATORY TRAP PRIMER DETAIL
NOT TO SCALE




AUTOMATIC TRAP PRIMER
NOT TO SCALE

- NOTES:
1. BACKFLOW PREVENTER MANUFACTURER AND INSTALLATION SHALL BE AS APPROVED BY LOCAL AND STATE AUTHORITIES AND IN ACCORDANCE TO LISTING OF DEVICE.
 2. ALL PIPING TO BE RIGIDLY SUPPORTED AND INSTALLED IN SUCH A MANNER AS TO BE DRAINABLE.



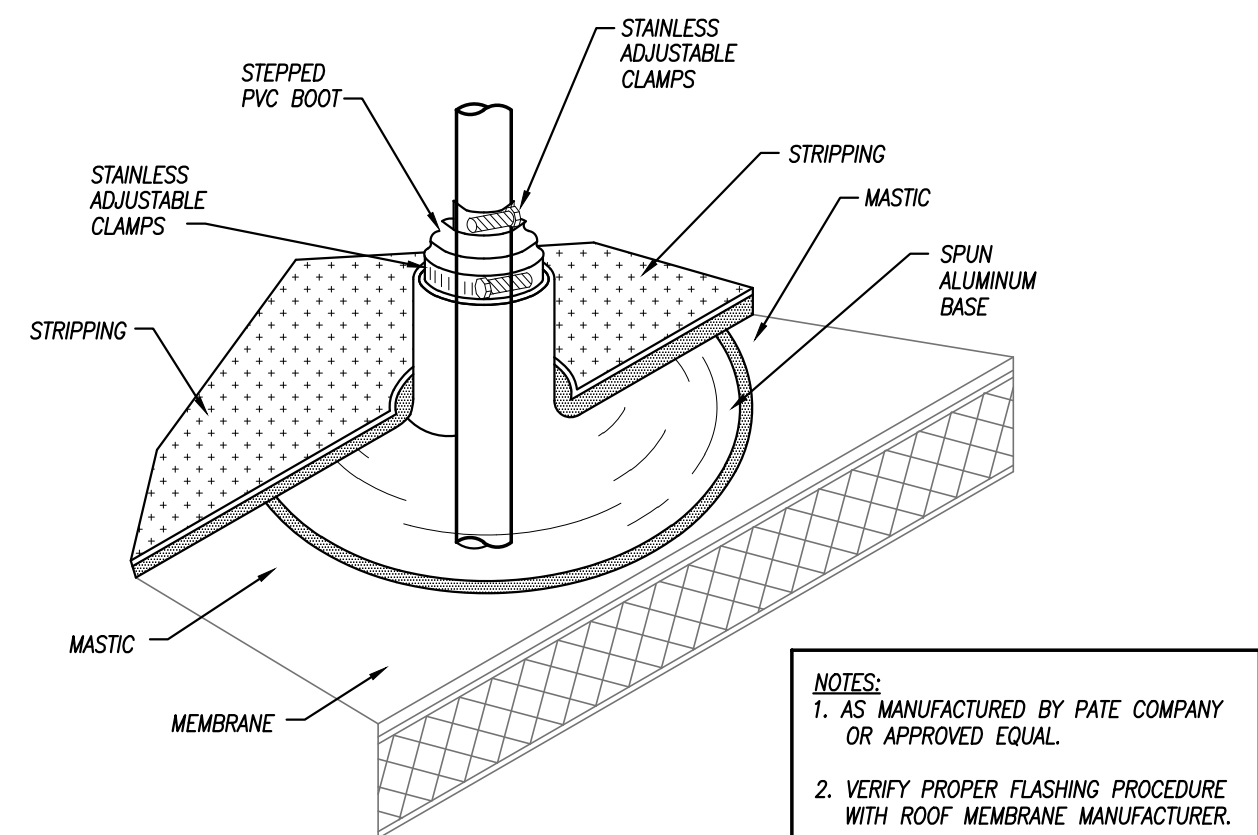WATER SERVICE REDUCED PRESSURE BACKFLOW PREVENTER DETAIL
NOT TO SCALE




ROOF PLUMBING VENT
NOT TO SCALE



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PLUMBING - DETAILS

DRAWING NO.
P3.01

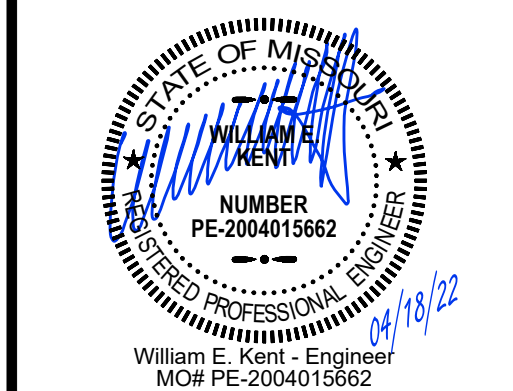Z:\22\22-113\DRAWINGS\22113 - P301.DWG



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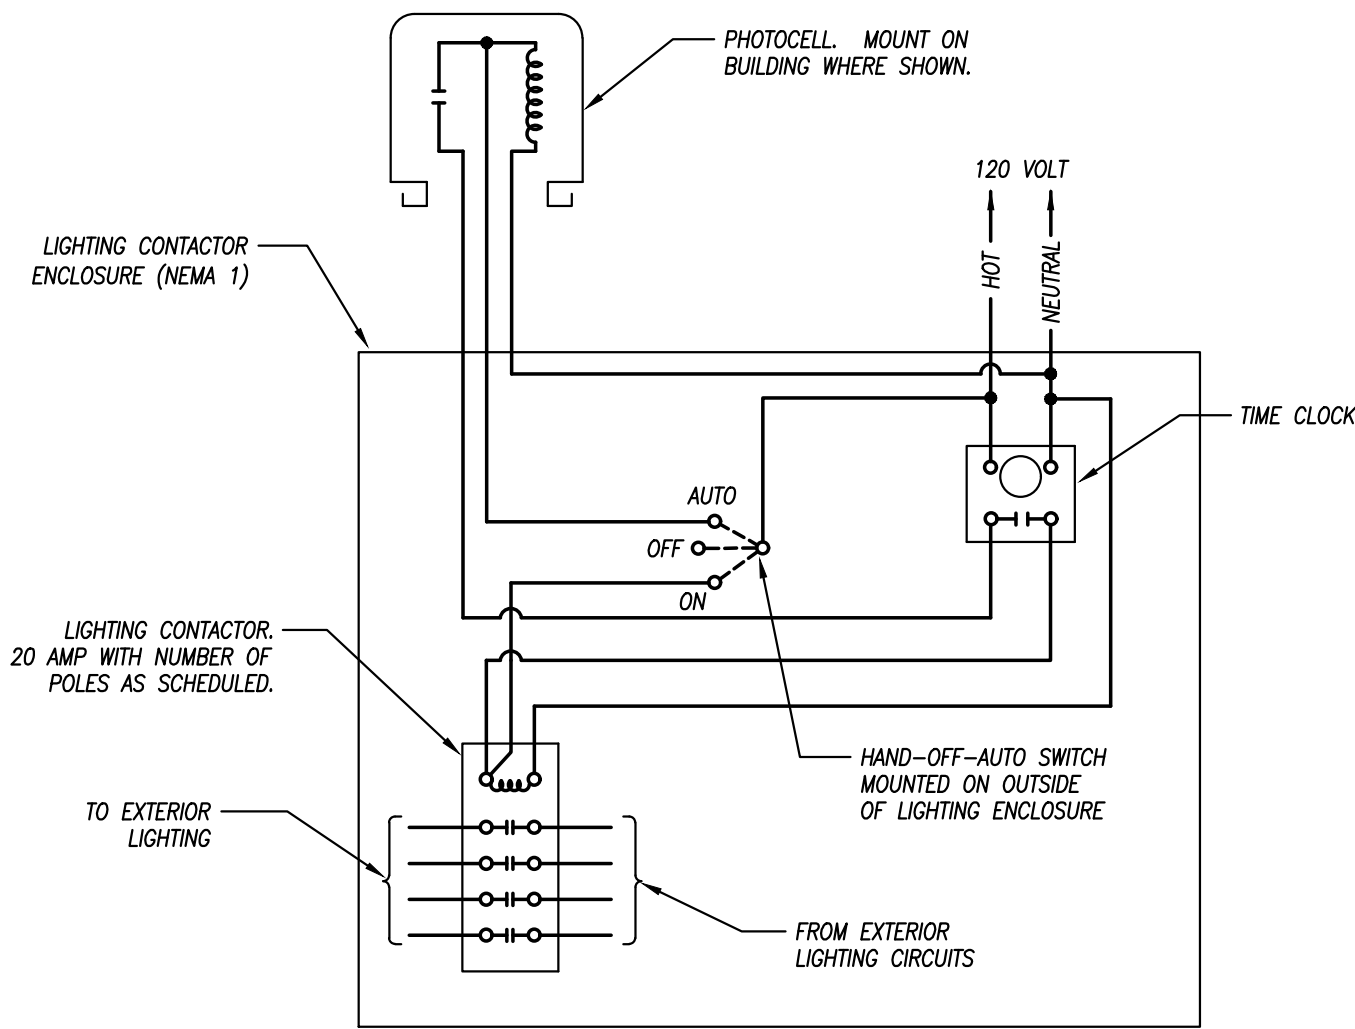
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PLATTE RIDGE PARK
FOOTBALL COMPLEX IMPROVEMENTS
17130 HIGHWAY 371, PLATTE CITY, MO 64079

FLOOR PLAN - LIGHTING

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DRAWING NO.
E1.01



EXTERIOR LIGHTING CONTROL
NOT TO SCALE


LIGHT FIXTURE SCHEDULE											
FIXTURE TYPE	MANUFACTURER	CATALOG NUMBER	DESCRIPTION	LED MODULE / DRIVER							REMARKS
				ID	WATTS	LUMENS	CRI	CCT	DIMMING	VOLTAGE	
A	WILLIAMS	6DR SERIES	6" ROUND RECESSED DOWNLIGHT. DIE-FORMED STEEL PAN WITH FINNED, EXTRUDED ALUMINUM PASSIVE HEAT SINK. SEMI-SPECULAR LOW IRIDESCENT FINISH ALUMINUM REFLECTOR WITH WIDE BEAM ANGLE/DISTRIBUTION AND FLUSH LENS. UL-LISTED WET LOCATION UNDER COVERED CEILING.	L40	36.4	3122	70	3000K	NO	120	1
B	WILLIAMS	AVX	4'-0" LONG x 8-1/2" WIDE x 2-13/16" HIGH ARCHITECTURAL SURFACE-MOUNTED FIXTURE. DIE-FORMED ALUMINUM HOUSING WITH RIBBED, TRANSLUCENT, MATTE WHITE ACRYLIC DIFFUSER AND VANDAL WRAP. WHITE POWDER COAT FINISH. UL LISTED WET LOCATION UNDER COVERED CEILING.	L46	33.9	4600	80	3500K	0-10V	120	1
C	LUMARK	CROSSTOUR XTOR SERIES	LOW-PROFILE EXTERIOR WALL-MOUNTED FIXTURE. ONE-PIECE, DIE-CAST ALUMINUM HOUSING. IMPACT-RESISTANT, TEMPERED GLASS LENS. FORWARD THROW OPTICS. POWDER COAT FINISH DARK BRONZE - COORDINATE WITH ARCHITECT/BUILDING OWNER. UL LISTED WET LOCATION.	3B-Y	26	2,575	70	3000K	NO	120	1
XC	DUAL-LITE	EVC SERIES	COMBINATION EMERGENCY LIGHTING UNIT / EXIT LIGHT. UV-STABLE THERMOPLASTIC HOUSING, FINISH WHITE. ADJUSTABLE EYEBALL STYLE LIGHTING HEADS WITH GLASS LENS FOR EMERGENCY LIGHT. EXIT SIGN TO HAVE RED LETTERS WITH DIRECTIONAL ARROWS AS INDICATED ON THE PLANS. MAINTENANCE-FREE LITHIUM ION PHOSPHATE BATTERY FOR 90 MINUTE OPERATION OF LAMPS AND EXIT SIGN. FULLY AUTOMATIC, SOLID-STATE CHARGER WITH TEST SWITCH AND AC-ON LIGHT.	TOTAL POWER CONSUMPTION = 2.4 WATTS.		-	-	-	-	120	1
				EMERGENCY: TWO (2) HIGH-OUTPUT LEDS.		-	-	-	-		
				EXIT: FOUR (4) HIGH-OUTPUT LEDS.		-	-	-	-		
REMARKS:											
1. FURNISH WITH AND INSTALL ALL NECESSARY HARDWARE AND MOUNTING BRACKETS.											
GENERAL NOTES (APPLICABLE TO ALL FIXTURES):											
1) EQUALS ARE ACCEPTABLE ON ALL LIGHT FIXTURES UNLESS SPECIFICALLY NOTED OTHERWISE. REFER TO SPECIFICATIONS FOR APPROVED EQUAL FIXTURE MANUFACTURERS.											
2) ALL DRIVERS ARE INTEGRAL TO FIXTURE UNLESS NOTED OTHERWISE. REFER TO SPECIFICATIONS FOR ADDITIONAL FIXTURE/DRIVER/BALLAST REQUIREMENTS.											
3) ALL FIXTURES WITH PAINTED METAL PARTS SHALL BE PAINTED AFTER FABRICATION.											
4) LUMENS LISTED FOR LED FIXTURES ARE GENERALLY DELIVERED LUMENS UNLESS NOTED OTHERWISE.											
5) ALL EXTERIOR LED FIXTURES ARE FULL CUTOFF UNLESS NOTED OTHERWISE.											
6) ALL FIXTURES IN FOOD PREPARATION OR SERVING AREAS SHALL BE FURNISHED WITH SHATTER-RESISTANT LAMPS UNLESS LENSED.											

GENERAL LIGHTING NOTES

- REFER TO GENERAL NOTES ON MEP COVER SHEET FOR ADDITIONAL REQUIREMENTS OF WORK.
- LIGHT FIXTURES INDICATED AS EMERGENCY FIXTURES ARE TO FUNCTION AS NIGHT LIGHTS UNLESS SPECIFICALLY SHOWN SWITCHED.
- ALL CIRCUITING SHOWN ON THIS PLAN IS DIAGRAMMATIC.
 - ALL FIXTURES SHALL BE FED FROM JUNCTION BOXES WITH LIGHT FIXTURE WHIPS (<6'). DAISY-CHAINING OF FIXTURES IS NOT ALLOWED.
 - SWITCH BOX LOCATIONS SHALL BE WIRED SO THAT A NEUTRAL WIRE IS AVAILABLE AT THE SWITCH BOX LOCATION, EITHER IN THE BOX OR AVAILABLE TO BE ADDED VIA RACEWAY OR AN ACCESSIBLE WALL CAVITY.
 - WALL SWITCHES FOR SEPARATE LOAD TYPES (EM/NORMAL, 120/277V, ETC.) SHALL NOT BE IN A SINGLE BOX.
 - REFER TO SPECIFICATIONS FOR ADDITIONAL REQUIREMENTS.

LIGHTING PLAN KEYED NOTES

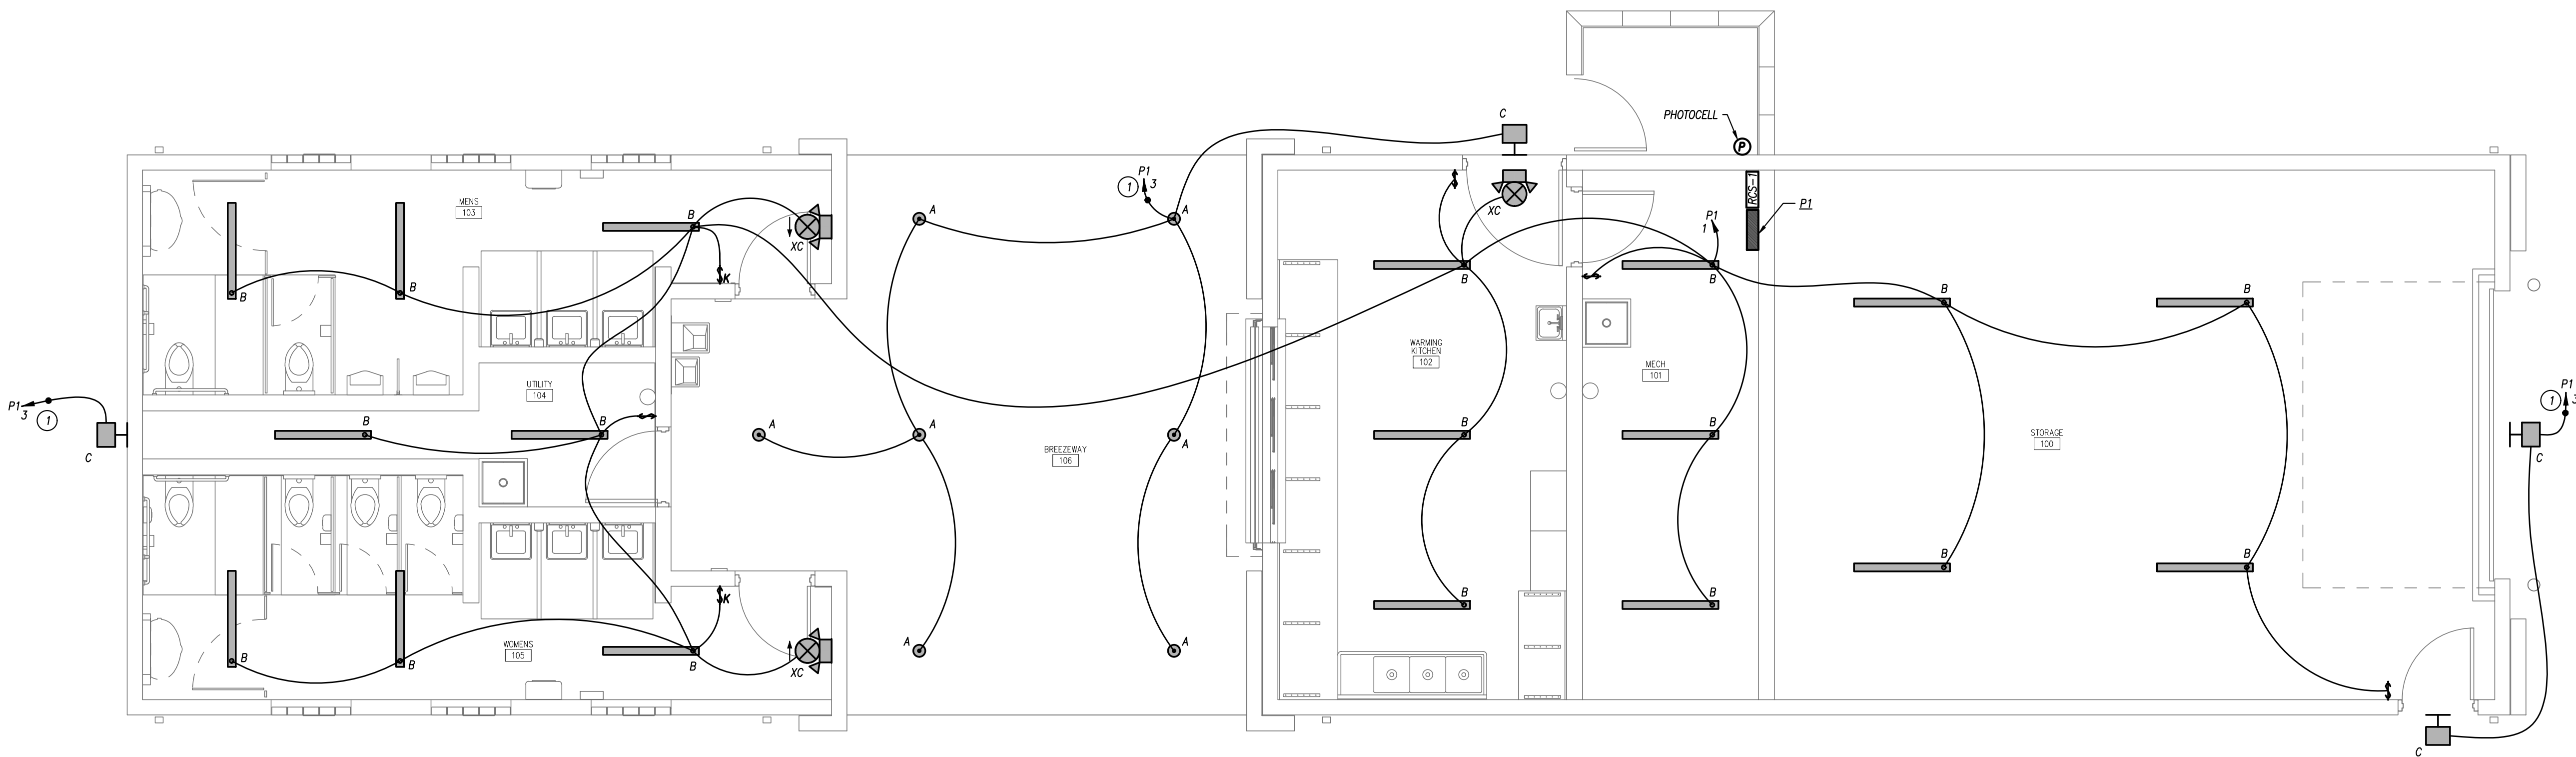- ROUTE THROUGH REMOTE CONTROL SWITCH RCS-1, THEN HOMERUN.



FLOOR PLAN - LIGHTING
1/4" = 1'-0"


SINGLE-SECTION PANELBOARD SCHEDULE

PANEL DESIGNATION: P1							CIRCUIT #	MAIN LUG AMPS: 225 MAIN BREAKER: 225 VOLTAGE: 240/120 PHASE/WIRE: 1Ø, 3W							
MOUNTING: SURFACE LOCATION: MECH 101															
DESCRIPTION	PHASE		TRIP	POLE	C/B			PHASE		DESCRIPTION					
	A	B			TRIP	POLE		A	B						
LTS: INTERIOR	782		20	1	1	2		2	30	1766		CONDENSING UNIT CU-1			
LTS: EXTERIOR		384	20	1	3	4				1766					
SPARE	—		20	1	5	6		2	15	278		AIR HANDLER AH-1			
RECEPT: RESTROOMS, UTILITY		540	20	1	7	8				278					
HAND DRYER	1000		20	1	9	10		2	40	3500		WATER HEATER EWH-1			
HAND DRYER		1000	20	1	11	12				3500					
RECEPT: EXTERIOR	540		20	1	13	14		2	40	3500		WATER HEATER EWH-2			
WATER COOLER		540	20	1	15	16				3500					
RECEPT: N. WARMING KITCHEN	180		20	1	17	18	1	20	900			RECEPT: MECH			
RECEPT: N. WARMING KITCHEN		180	20	1	19	20	1	20		540		RECEPT: STORAGE			
RECEPT: N. WARMING KITCHEN	180		20	1	21	22	1	20	540			RECEPT: OVERHEAD DOOR			
RECEPT: N. WARMING KITCHEN		360	20	1	23	24	1	20		1176		SITE TURBINE PUMP			
GARBAGE DISPOSAL	696		15	1	25	26	1	15	852			SITE BLOWER			
RECEPT: S. WARMING KITCHEN		180	20	1	27	28	1	60		2028		WIRE GUTTER			
RECEPT: S. WARMING KITCHEN	180		20	1	29	30	1	15	528			EXHAUST FAN EF-1			
SPARE		—	20	1	31	32	1	20		—		SPARE			
SPARE		—	20	1	33	34	1	20		—		SPARE			
SPARE		—	20	1	35	36	1	20		—		SPARE			
SPARE		—	20	1	37	38	1	20		—		SPARE			
SPARE		—	20	1	39	40	1	—		—		SPARE			
SPARE		—	20	1	41	42	1	—		—		SPARE			
TOTALS	3558	3184								11864	12788	TOTALS			

PANELBOARD SIZING LOAD			
LOAD DESCRIPTION	CONNECTED	DEMAND	CODE MIN. (VA)
LIGHTS	1,166	1.25	1,458
RECEPTACLES	4,860	10KVA + 50% REST	4,860
MOTORS	3,808	1.25 x LARGEST + SUM OF REST	4,102
AIR CONDITIONING	3,532	1.00	3,532
SPACE HEATING	0	0.00	0
CONTINUOUS	14,000	1.25	17,500
NON-CONTINUOUS	4,028	1.00	4,028
MISC. LOADS 1	0	1.00	0
MISC. LOADS 2	0	1.00	0
SIZING LOAD:			35,480
SIZING LOAD (AMPS):			148

CONNECTED PHASE LOADS		
PHASE	VA	AMPS
A	15,422	128.5
B	15,972	133.1
TOTALS	31,394	130.8

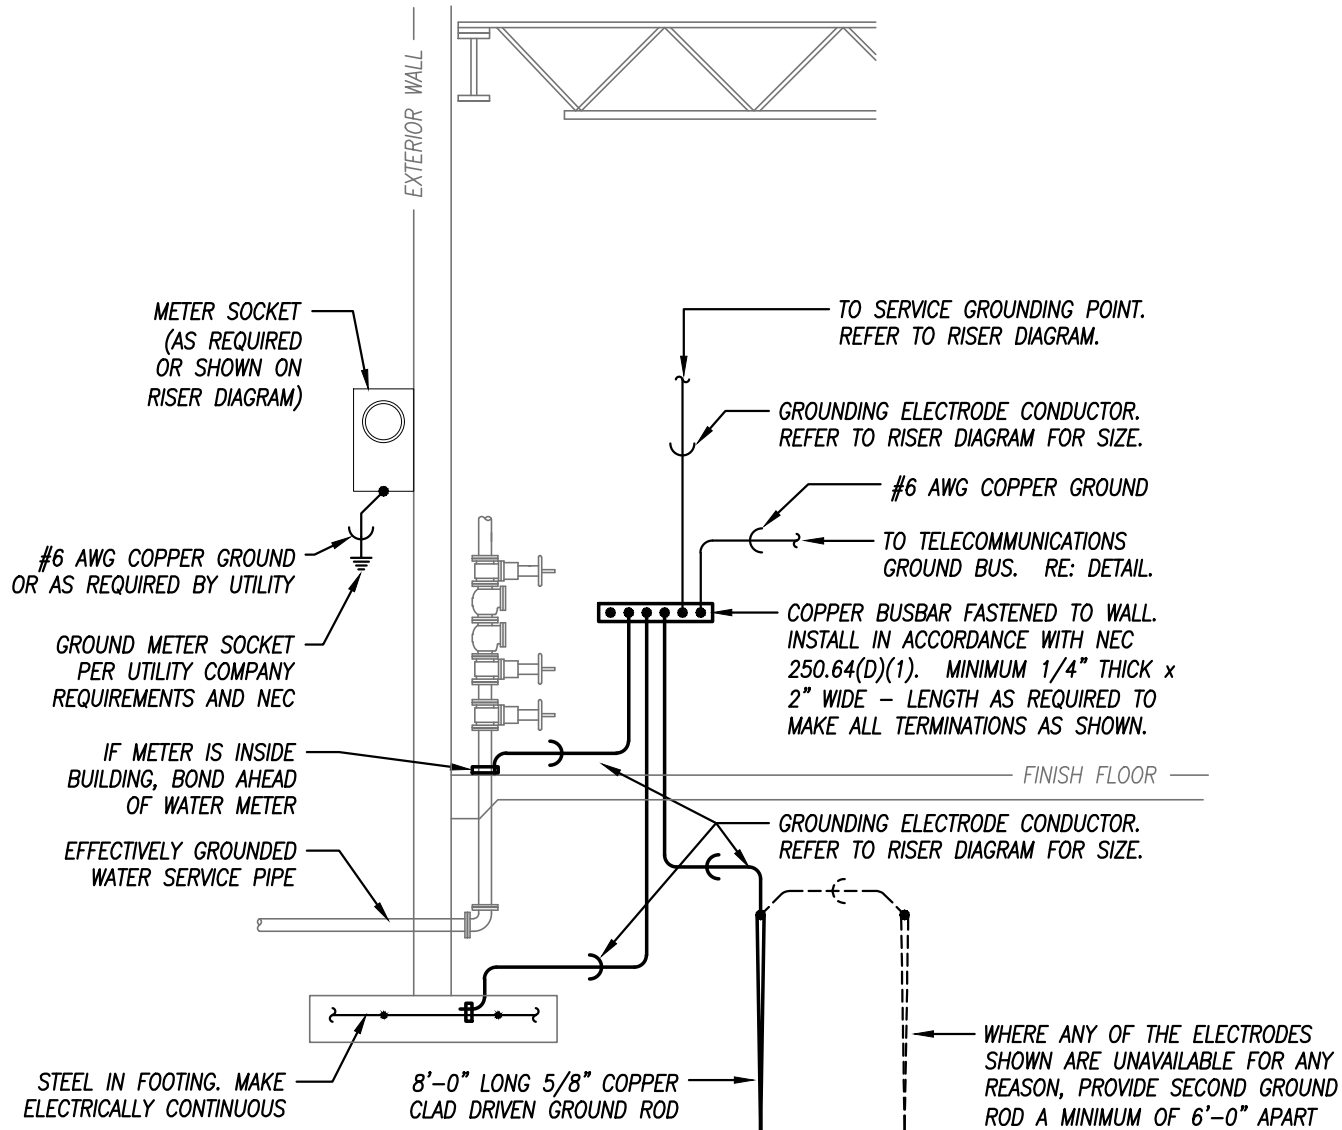REMARKS:
1. SERVICE ENTRANCE RATED.
2. FURNISH GFCI-PROTECTED BREAKER.




ELECTRICAL SERVICE GROUNDING DETAIL

NOT TO SCALE

EQUIPMENT FEEDER SCHEDULE									
FEEDER NO.	EQUIPMENT	LOAD (AMPS)	SETS	# OF WIRES	SIZE	GROUND	MATERIAL	SIZE	TYPE
F1	PANELBOARD P1	147.8	1	3	#4/0	-	COPPER	2"	EMT
F2	WIREWAY	0.0	1	3	#3	#8	COPPER	1-1/4"	EMT
F3	TURBINE PUMP	0.0	1	3	#12	#12	COPPER	1/2"	EMT
F4	SMALL BLOWER	0.0	1	3	#12	#12	COPPER	1/2"	EMT

RISER DIAGRAM KEYED NOTES

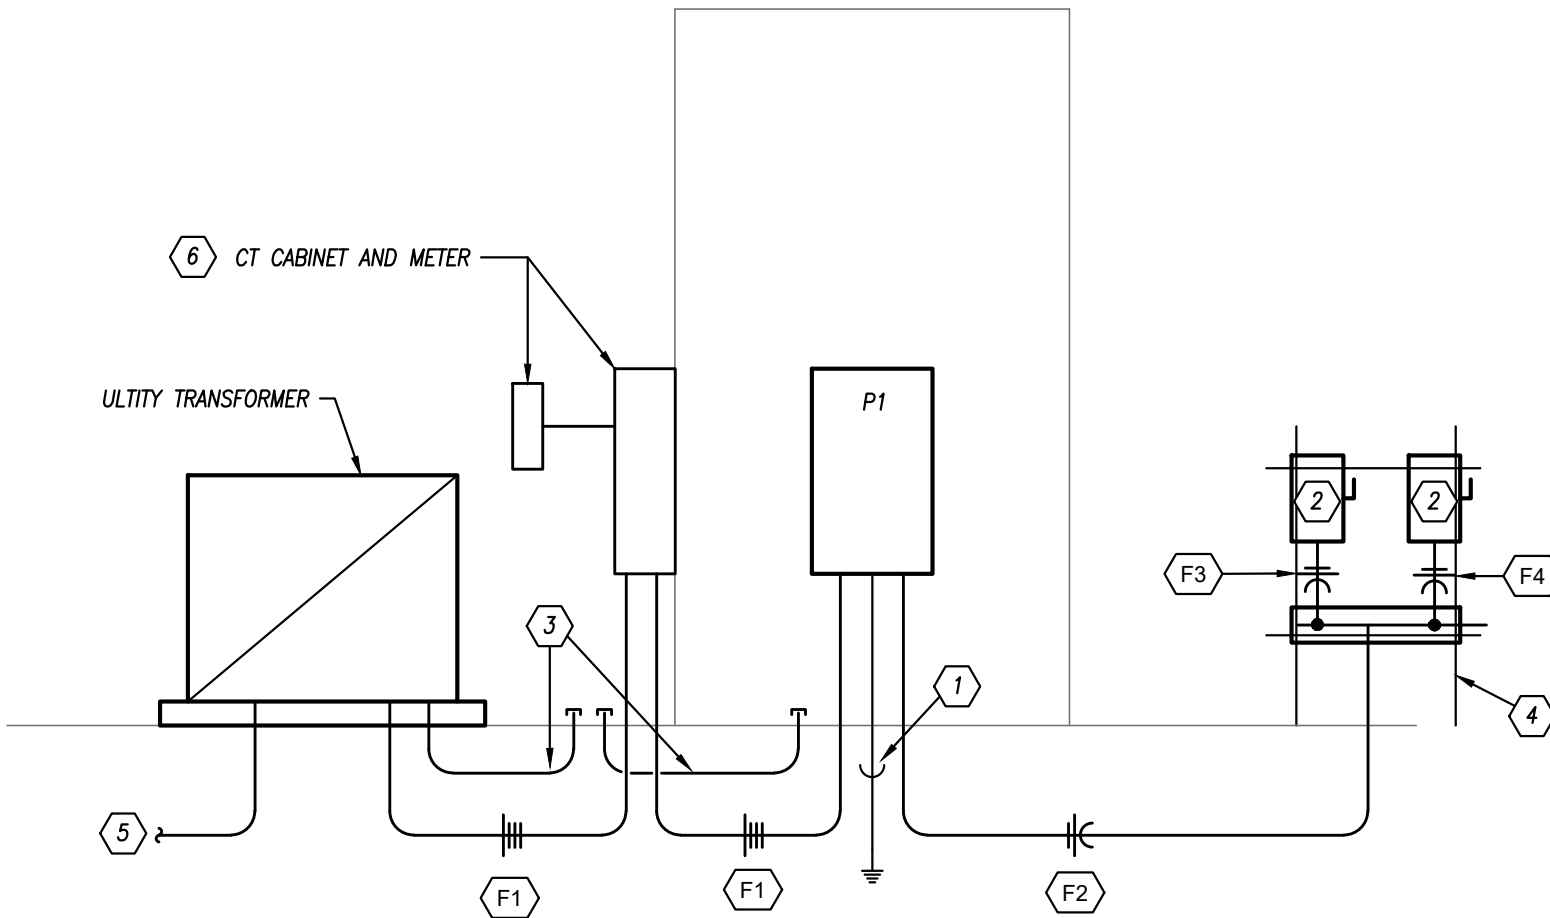- (1) #4 GROUNDING ELECTRODE IN 1/2" CONDUIT.
- (2) 30 AMP, 2-POLE, FUSED, HEAVY DUTY DISCONNECT SWITCH IN NEMA 3R ENCLOSURE. FUSE WITH 20A FUSES. MAINTAIN SERVICE CLEARANCES ABOUT DISCONNECT PER NEC AND MAINTAIN ALL REQUIRED EQUIPMENT CLEARANCES PER MANUFACTURER'S RECOMMENDATIONS.
- (3) PROVIDE TWO (2) SETS OF (2) 4" EMPTY CONDUITS WITH PULL STRINGS FOR FUTURE ELECTRICAL SERVICES. STUB UP AND CAP.
- (4) PROVIDE H-FRAME UNISTRUT FOR WIREWAY AND FUSIBLE DISCONNECT. COORDINATE ALL WORK WITH CIVIL. REFER TO SITE AND CIVIL DRAWING FOR MORE INFORMATION.
- (5) (1) 4" CONDUIT WITH PULL STRING. INSTALL AT 36" BELOW GRADE AND PROVIDE WARNING TAPE AT 18" BELOW GRADE. REFER TO CIVIL PLANS FOR CONTINUATION. COORDINATE ALL WORK WITH UTILITY.
- (6) PROVIDE CT CABINET BASE FOR FUTURE SERVICE. COORDINATE ALL WORK WITH ELECTRICAL UTILITY.



ELECTRICAL RISER DIAGRAM

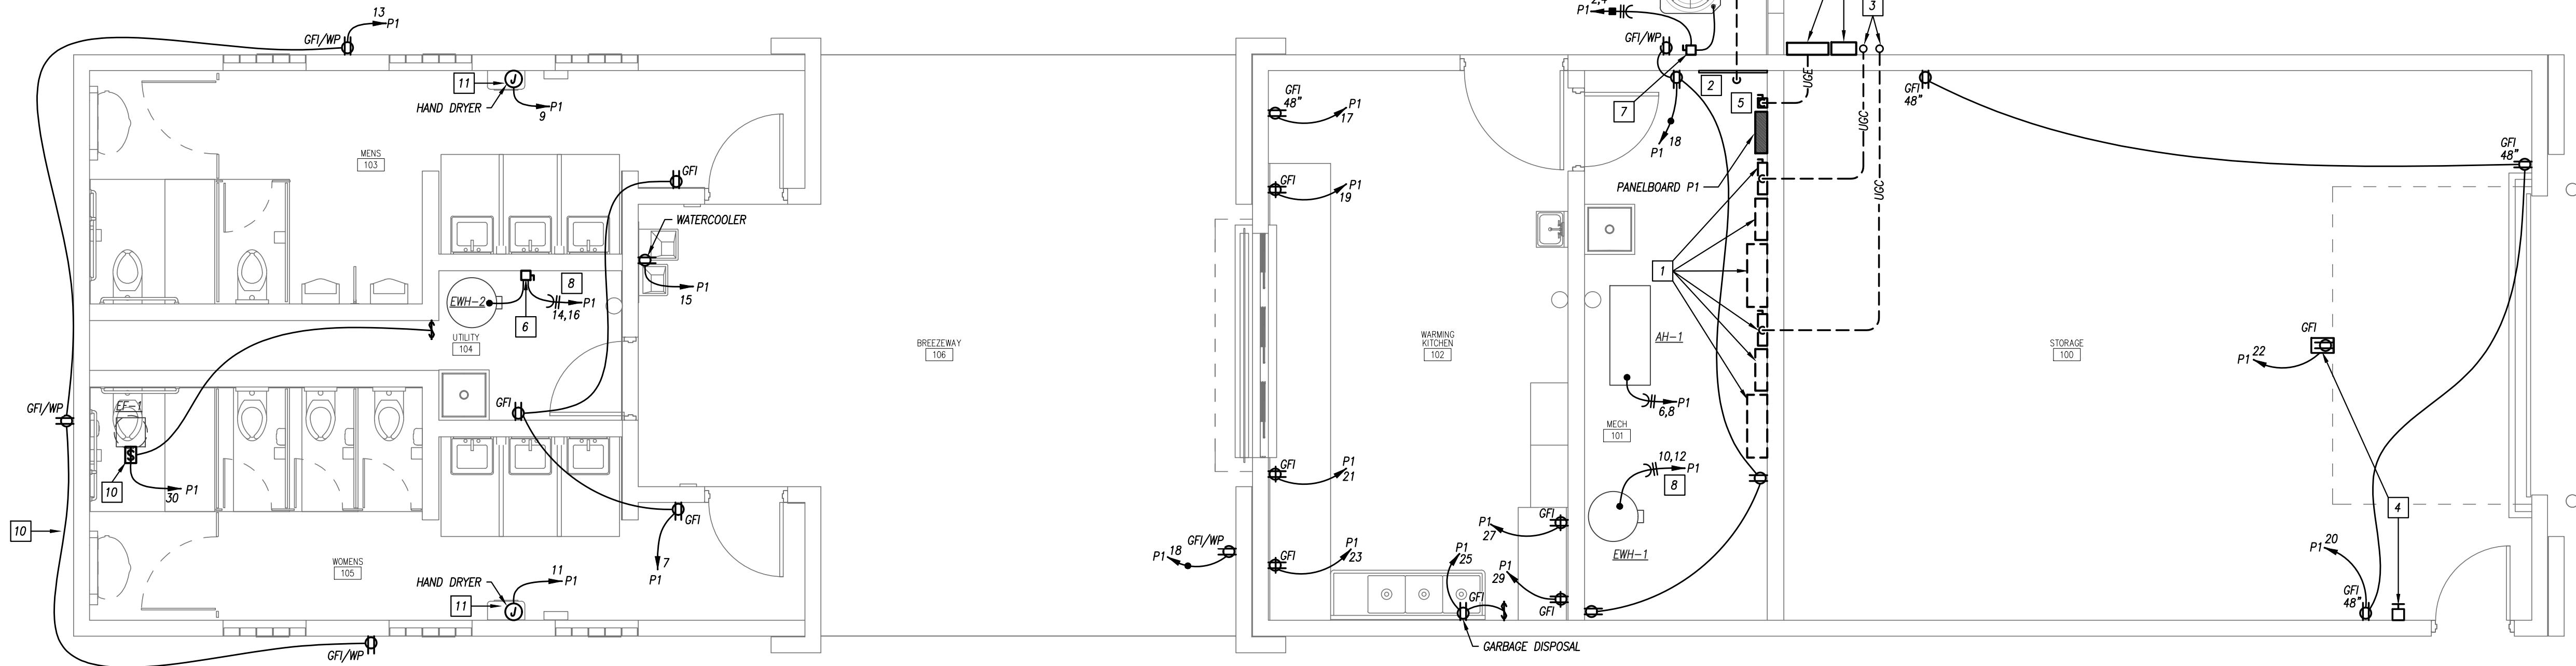
NOT TO SCALE

GENERAL POWER NOTES

1. REFER TO GENERAL NOTES ON MEP COVER SHEET FOR ADDITIONAL REQUIREMENTS OF WORK.
2. COORDINATE EXACT NEMA CONFIGURATIONS OF RECEPTACLES SERVING EQUIPMENT WITH EXACT EQUIPMENT BEING FURNISHED.
3. REFER TO THE SPECIFICATIONS FOR ADDITIONAL LOCATIONS/REQUIREMENTS FOR RECEPTACLES, INCLUDING GFCI, WEATHER-RESISTANT, HOSPITAL-GRADE, AND TAMPER-RESISTANT RECEPTACLES.
4. EXACT MECHANICAL EQUIPMENT LOCATIONS MAY NOT BE SHOWN FOR CLARITY. COORDINATE EXACT LOCATIONS OF ALL MECHANICAL EQUIPMENT, DUCT DETECTORS, ETC. WITH MECHANICAL DRAWINGS AND CONTRACTOR.
5. COORDINATE EXACT LOCATIONS OF SMOKE DETECTORS WITH CEILING FANS, HVAC DIFFUSERS, SPRINKLER HEADS, ETC. PER NFPA REQUIREMENTS.

POWER PLAN KEYED NOTES

- 1 FUTURE EQUIPMENT FOR FUTURE FIELD LIGHTS. PRESERVE WALL SPACE FOR FUTURE FIELD LIGHTING PANELS AND CONTROLS.
- 2 4'-0" x 8'-0" x 3/4" THICK PLYWOOD TELECOMMUNICATIONS BACKBOARD. MOUNT AT 6" A.F.F. PLYWOOD SHALL BE FIRE-TREATED.
- 3 PROVIDE TWO (2) SETS OF (2) 4" EMPTY CONDUITS WITH PULL STRINGS FOR FUTURE ELECTRICAL SERVICES. STUB UP AND CAP.
- 4 POWER FOR DOOR OPERATOR. PROVIDE ALL REQUIRED POWER AND CONTROL WIRING AND ASSOCIATED CONDUIT FOR ACCESSORIES INCLUDING PHOTOELECTRIC EMITTERS AND RECEIVER FOR A COMPLETE SYSTEM. VERIFY DOOR OPERATOR SYSTEM REQUIREMENTS WITH MANUFACTURER PRIOR TO INSTALLATION.
- 5 200 AMP, 3-POLE, HEAVY-DUTY FUSIBLE DISCONNECT SWITCH IN NEMA 3R ENCLOSURE. FUSE WITH 200A FUSES. SWITCH SHALL BE SUITABLE FOR USE AS SERVICE ENTRANCE EQUIPMENT.
- 6 60 AMP, 2-POLE, NON-FUSED, HEAVY DUTY DISCONNECT SWITCH IN NEMA 1 ENCLOSURE. MAINTAIN SERVICE CLEARANCES ABOUT DISCONNECT PER NEC AND MAINTAIN ALL REQUIRED EQUIPMENT CLEARANCES PER MANUFACTURER'S RECOMMENDATIONS.
- 7 30 AMP, 2-POLE, NON-FUSED, HEAVY DUTY DISCONNECT SWITCH IN NEMA 3R ENCLOSURE. MAINTAIN SERVICE CLEARANCES ABOUT DISCONNECT PER NEC AND MAINTAIN ALL REQUIRED EQUIPMENT CLEARANCES PER MANUFACTURER'S RECOMMENDATIONS.
- 8 (2) #8 WIRE AND (1) #12 GROUND IN 3/4" CONDUIT.
- 9 MOUNT TOGGLE DISCONNECT UNDER FAN SHROUD.
- 10 ROUTE CONCEALED (TYPICAL).
- 11 CONDUIT TO HAND DRYER TO BE CONCEALED.





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MISSOURI CERTIFICATE OF AUTHORITY NO. E-2006023253
EXPIRES: DECEMBER 31, 2022



REVISIONS
ISSUE DATE: 4/18/2022

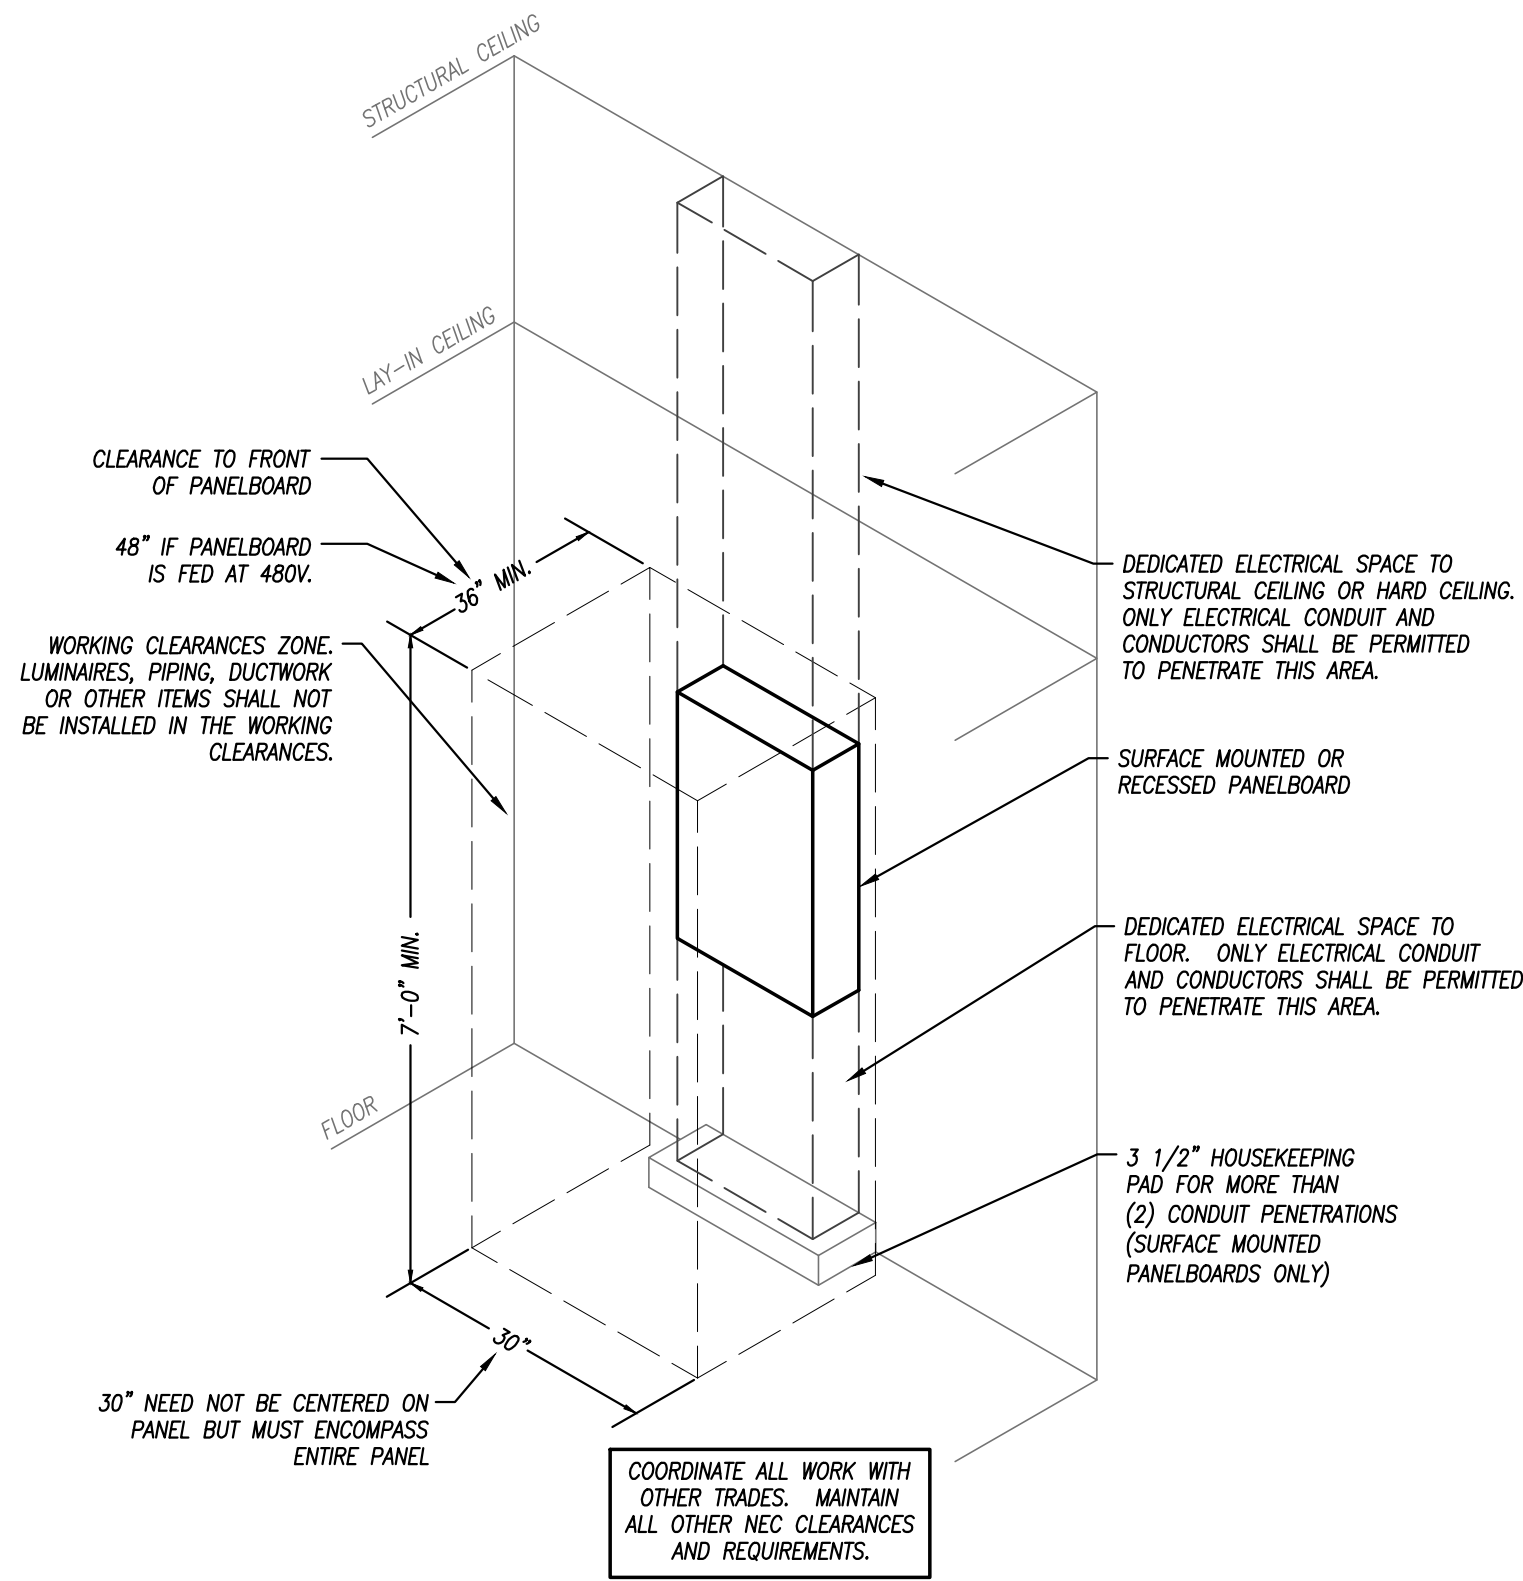
PROJECT INFO
210266-000

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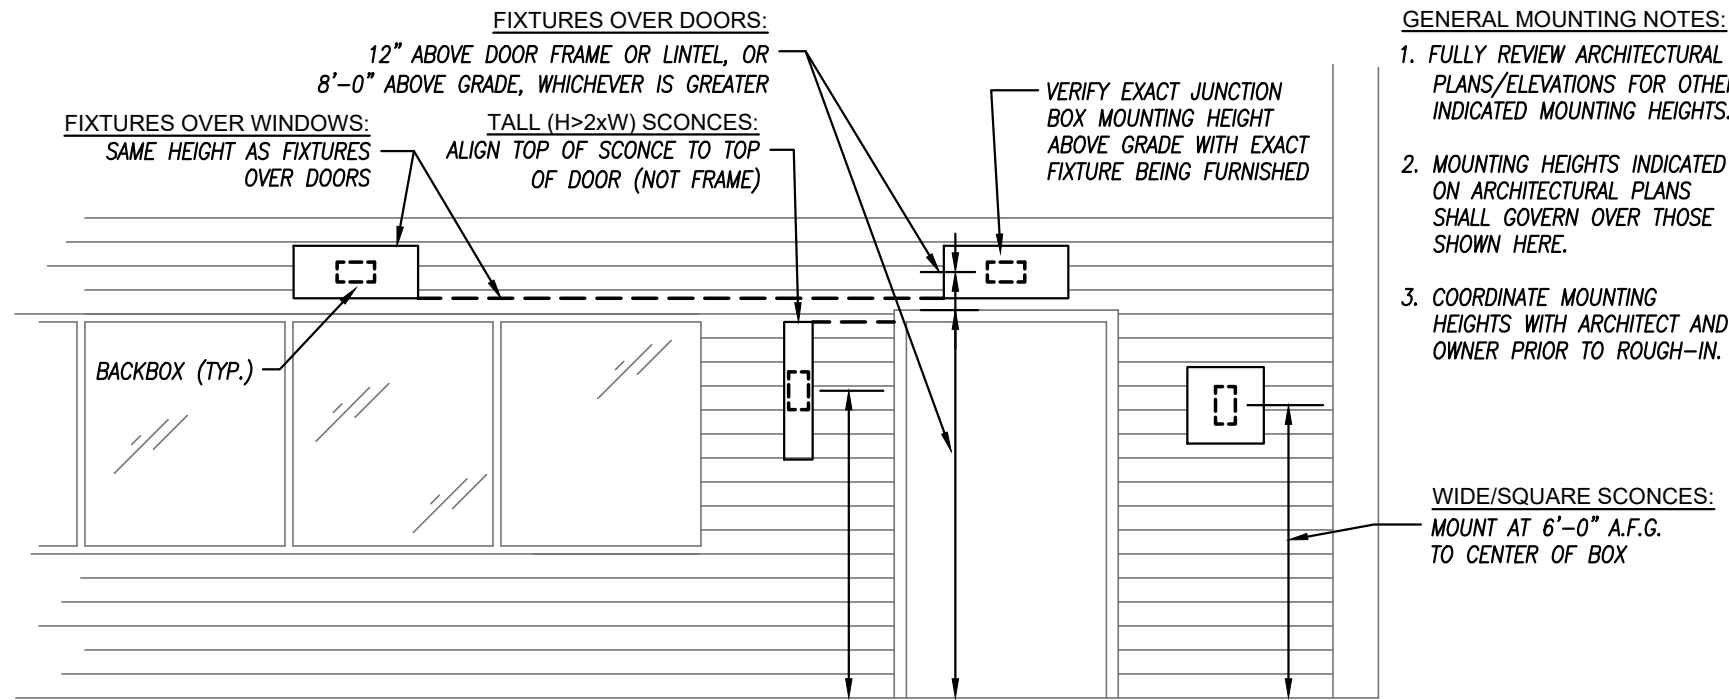
PLATTE RIDGE PARK
FOOTBALL COMPLEX IMPROVEMENTS
17130 HIGHWAY 371, PLATTE CITY, MO 64079

ELECTRICAL - SCHEDULES & DETAILS


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TYPICAL PANELBOARD INSTALLATION DETAIL
NOT TO SCALE



EXTERIOR BUILDING-MOUNTED
LIGHT FIXTURE MOUNTING HEIGHTS DETAIL
NOT TO SCALE



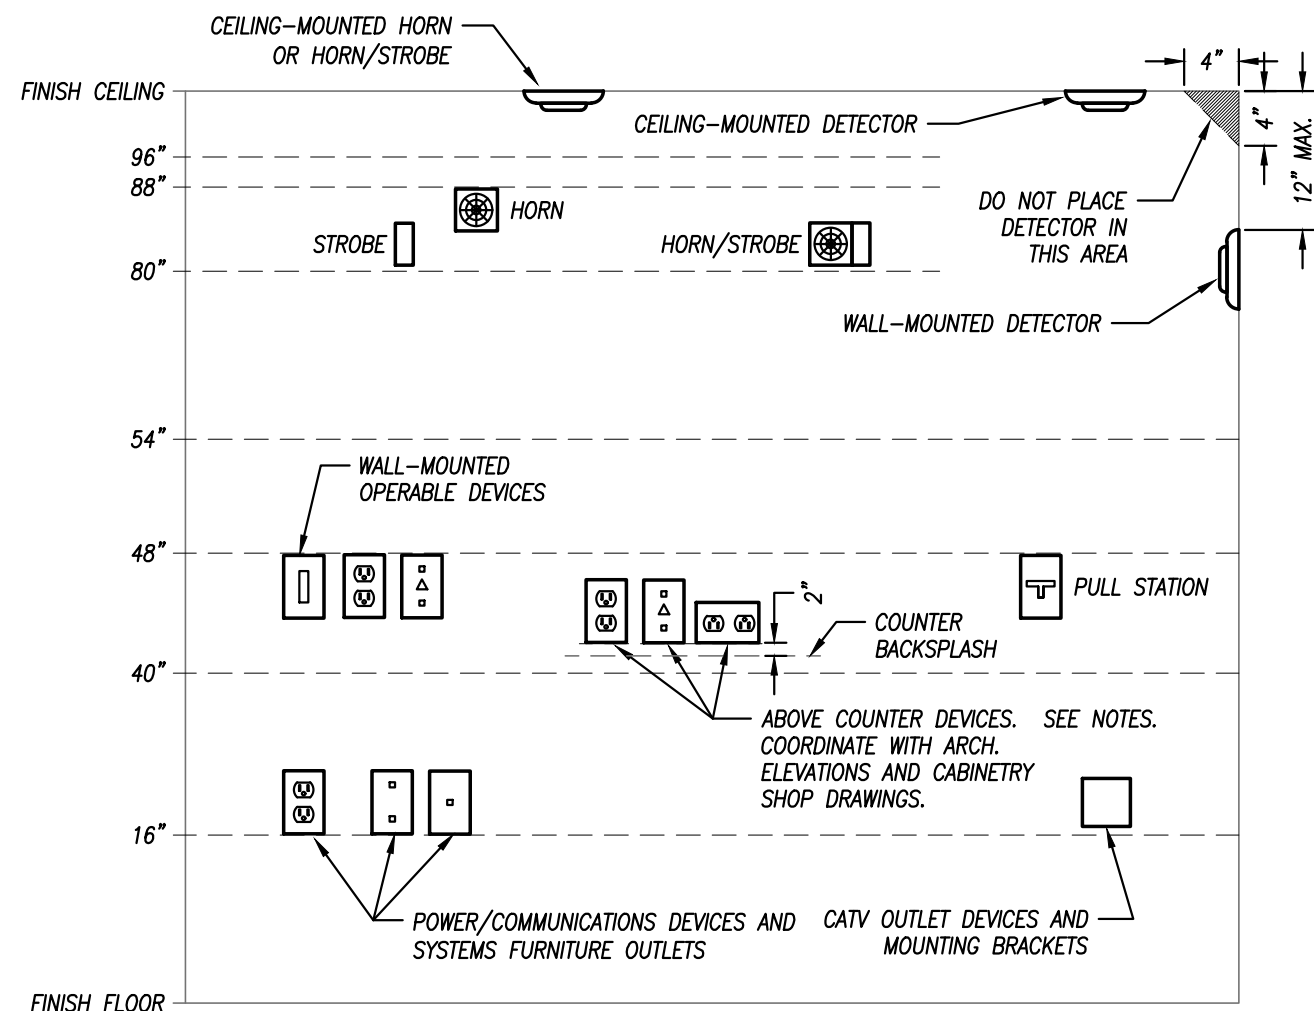GENERAL NOTES:
1. MOUNTING HEIGHTS SHOWN IN THIS DETAIL ARE TYPICAL UNLESS OTHERWISE NOTED ON THE PLANS.
2. SEE ARCHITECTURAL ELEVATIONS FOR SPECIAL CONDITIONS. NOTIFY ARCHITECT IMMEDIATELY OF ANY CONFLICTS.
3. ALL INSTALLATIONS SHALL COMPLY WITH ADA.

VISUAL FIRE ALARM NOTIFICATION DEVICES (STROBE)
LOCATE DEVICE SO THE BOTTOM OF THE DEVICE IS BETWEEN 80" AND 96" A.F.F. (NFPA) OR 6" BELOW CEILING, WHICHEVER IS LOWER (ADA 2010).

AUDIBLE FIRE ALARM NOTIFICATION DEVICES (HORN)
LOCATE DEVICE SO THAT THE TOP OF UNIT IS NOT MORE THAN 90" A.F.F. AND NOT LESS THAN 6" BELOW CEILING (NFPA)

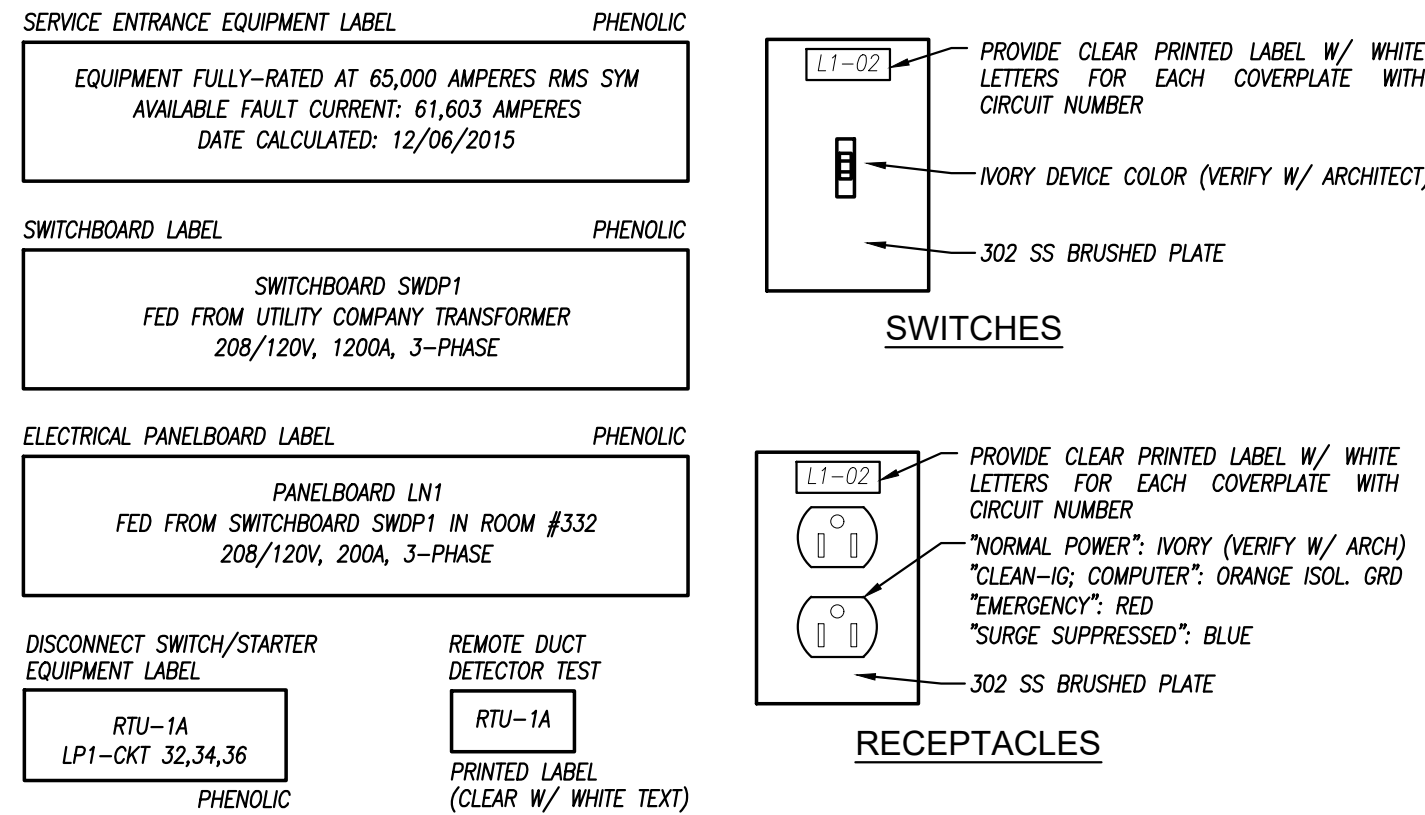
FIRE ALARM ACTIVATION DEVICES (PULL STATION)
LOCATE FRONT-APPROACH DEVICES SO THAT THE HIGHEST OPERABLE PORTION OF THE DEVICE IS NOT MORE THAN 48" A.F.F. (ADA 2010) AND NOT LESS THAN 42" A.F.F. (NFPA).

POWER/COMMUNICATION DEVICES:
OUTLETS SHALL BE LOCATED AT 16" A.F.F. TO THE BOTTOM OF THE BOX. ABOVE COUNTER DEVICES SHALL BE LOCATED AT 2" ABOVE THE BACKSPLASH OF THE COUNTER TO THE BOTTOM OF THE DEVICES. VERIFY WITH ARCHITECTURAL DETAILS.


WALL-MOUNTED OPERABLE DEVICES:
OPERABLE DEVICES SHALL BE LOCATED AT 48" A.F.F. TO THE TOP OF THE OPERABLE PORTION OF THE DEVICE.

WALL-MOUNTED OPERABLE DEVICES INCLUDE, BUT ARE NOT LIMITED TO THE FOLLOWING:
LIGHT SWITCHES, DIMMERS, CONTROLS, ETC.
PUSH BUTTONS
NURSE/PATIENT CALL DEVICES (INCLUDING THOSE FOR STAFF USE)
OTHER CONTROL OR "CALL" DEVICES

MOUNTING HEIGHTS FOR WALL-MOUNTED DEVICES
NOT TO SCALE



LABELING DETAIL
NOT TO SCALE

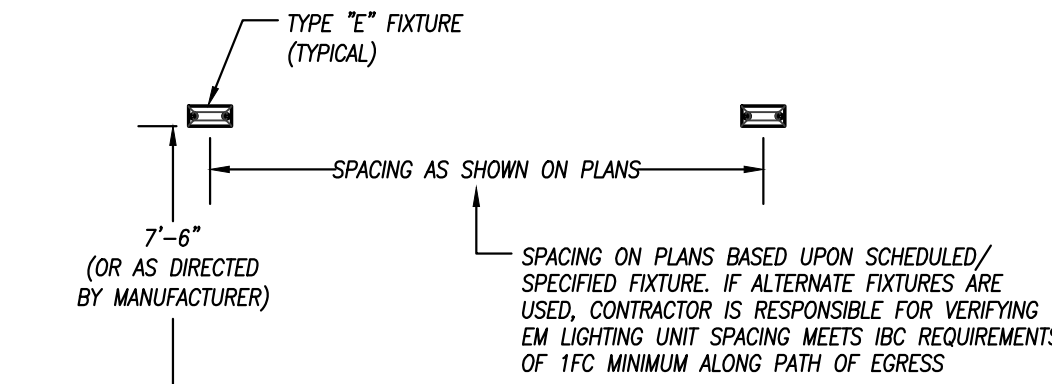

EMERGENCY LIGHTING FIXTURES DETAIL
NOT TO SCALE

1. All construction shall conform to the standards referenced in "Design Criteria".
2. The structural drawings are intended to be utilized in conjunction with other design consultant's drawings (Architectural, Civil, Mechanical, etc.). It is the responsibility of the contractor to coordinate the requirements of the drawings into their shop drawings and construction.
3. See Specifications or Notes on drawings for materials of construction.
4. Contractor shall verify all dimensions and conditions at the job site before commencing work and shall report any discrepancies to the engineer.
5. Omissions or conflicts between various elements of the drawings, notes, and details shall be brought to the attention of the engineer and resolved before proceeding with the work.
6. Do not use scaled dimensions; use written dimensions or, where no dimension is provided, consult the engineer for clarification before proceeding with the work.
7. Details and keynotes shown shall be incorporated into the project at all appropriate locations whether or not the detail is specifically referenced.
8. Refer to architectural, mechanical, electrical, and civil drawings for location and size of block outs, inserts, openings, curbs, bases & pads, and dimensions not shown on the structural drawings.
9. Refer to the architectural drawings for the following: size and location of doors and window openings, dimensions not shown on structural drawings, exterior wall assemblies, and floor, wall, and roof finishes.
10. Construction sequence and methods:
 - A. Construction Loads have not been considered and the contractor must brace all elements of the structure during construction.
 - B. The structural drawings are intended for the structure to act as a whole once construction is complete. It is the responsibility of the contractor to ensure safety and stability during construction as a result of means and sequence by providing shoring, bracing, etc. as required.
 - a. Temporary bracing shall remain until positive connection is made to shear walls (with roof diaphragm). This is a means and methods item.
 - C. The contractor shall consider the effects of thermal movements due to hot or cold weather or extreme temperature variations.
11. Required Submittals:
 - A. Submittals must be returned to contractor marked "Approved" or "Approved as Noted" prior to proceeding with work.
 - B. Allow (3) weeks for review of shop drawings. Time required for more than (2) reviews of a submittal will be billed hourly.
 - C. Shop drawings should be original drawings. Any submission incorporating any portion or reproduction of the contract documents will not be reviewed.
 - D. Submittals/shop drawings are required for the following:
 - a. Concrete
 - b. Concrete Reinforcing
 - c. Concrete Anchor Bolts
 - d. Masonry Wall Materials
 - e. Masonry Reinforcing

1. Design Codes:
 - A. International Building Code: IBC 2018
 - B. Minimum Design Loads for Buildings and Other Structures: ASCE 7-16
2. Design Loads:
 - Dead Loads:
 - Roof Dead Load = 20 psf
 - Live Loads:
 - Slab on Grade = 100 psf (non-reducible)
 - Sidewalks = 250 psf
 - Roof Live Load = 20 psf
 - Roof Snow Load:
 - Ground Snow Load (P_g) = 20 psf
 - Roof Snow Load (P_f) = 20 psf
 - Snow Exposure Factor (C_e) = 1.0
 - Snow Load Importance Factor (I) = 1.0
 - Roof Thermal Factor (C_t) = 1.2
 - Wind Load:
 - Ultimate Wind Speed, V_{ult} = 115 mph
 - Nominal Wind Speed, V = 90 mph
 - Risk Category = II
 - Wind Exposure = C
 - Design Elevation = 950 ft
 - Earthquake Load:
 - Seismic Importance Factor = 1.0
 - Seismic Occupancy Category = II
 - $S_1 = 0.091g$ $S_2 = 0.065g$
 - Soil Site Class: = D
 - $S_{0.5} = 0.097$ $S_{D1} = 0.104$
 - Seismic Design Category = B
3. Soil Properties:

Soil properties are based on Table 1806.2, Presumptive Load-Bearing Values from the 2018 IBC

Allowable Soil Bearing Pressure = 1,500 psf

1. Reinforced concrete shall have the following minimum 28 day compressive strengths:
 - A. Slab on grade, unless noted otherwise (UNO) 4000 psi, Normal Weight
 - B. Foundations and Grade Beams 4000 psi, Normal Weight
2. All concrete exposed to weather shall have 6% (1%) air entrainment.
3. Submit mix designs for all concrete mixes prior to placement. All submittals shall include the following:
 - A. Batch quantities including admixtures dosage rates
 - B. Strength test results for trial mixes
 - C. Cured unit weight results (for Light Weight concrete mixes only)
 - D. Aggregate source(s) and gradation(s)
 - E. Product data for cement, fly ash, and other cementitious materials
 - F. Product data for all admixtures
4. Provide protection for reinforcing bars as follows:
 - A. Cast-in-place concrete:

Concrete cast against and permanently exposed to earth	3"
Concrete exposed to earth and weather (formed)	
#5 and smaller	1-1/2"
#6 and larger	2"
Concrete not exposed to weather and not in contact with ground:	
Slabs and walls	3/4"
Beams and columns	1-1/2"
5. Interface of all slab and beam construction joints shall be roughened with 1/4" amplitude. Surface of construction joints shall be clean and free of laitance. Immediately before new concrete is placed, construction joints shall be wetted and standing water removed.
6. Sleeves and openings in slabs not shown on structural drawing or outside the parameters of typical sleeve details are not permitted, unless approved by the Structural Engineer.
7. Conduit and pipes embedded in slabs, walls, or grade beams shall be no larger in outside dimension than 1/3 the overall member thickness, and shall be placed no closer than 3 diameters or widths on center.
8. Conduits and pipes shall not be permitted in concrete pilasters or columns.
9. Slab on Grade
 - A. Slab shall be constructed as shown on plans
 - B. Slab-on-grade shall be founded on 6" deep 3/4" clean aggregate base.
 - C. Provide joints at 30x "slab thickness" (±) in both directions and located to conform to bay spacing wherever possible (at column centerlines, half bays, third bays, etc.) Submit control joint layout to Architect for any exposed concrete surfaces.
 - D. Saw cut control joints shall be done late enough to prevent raveling of the cut edges and early enough to prevent cracking of the slab ahead of the saw blade.
 - E. Concrete slab to be cured according to ACI Standards. Concrete slab cure to be compatible with any sealer, grout, or adhesive that may be used on the floor later.
 - F. At floor drains, locally slope floor towards drain. See Architectural and Plumbing drawings for drain locations.

General

A. All reinforcing steel to be ASTM A615, Grade 60, deformed bars, unless noted otherwise.

a. Any reinforcing to be welded shall be ASTM A706 and welded with E80 electrodes

b. Alternatively, ASTM A615 reinforcing may be welded with E90 electrodes and proper preheat according to AWS D1.4.

c. E70 electrodes are not permitted for welding rebar.

B. Welded wire fabric shall be ASTM A185. Welded wire fabric shall be in flat sheets.

C. All reinforcing bars to be detailed and placed in accordance with the ACI "Manual of Standard Practice for Detailing Reinforced Concrete Structures" specifications.

D. All reinforcing, including dowels, shall be securely tied and cast with the lower member. Placing reinforcing after concrete has been placed will not be permitted.

E. Field bending of reinforcing partially embedded in concrete will not be allowed unless specifically noted on the drawings or approved by the Structural Engineer.

F. All reinforcing bar shall be contact lap spliced or doweled as follows, unless noted otherwise:

Bar Size	Development		Class "B" Splice		Embed	Standard 90° Hook		Bend Diam.
	Top Bar	Bottom Bar	Top Bar	Bottom Bar		Leg Length		
#3	19	15	24	19	6	6	2-1/4	
#4	25	19	32	25	7	8	3	
#5	31	24	40	31	9	10	3-3/4	

1. Straight development and Class "B" splice lengths shown in above tables are based on uncoated bars assuming center-to-center bar spacing $\geq 2D_b$ without ties or stirrups, or $\geq 2D_b$ with ties or stirrups, and bar clear cover $\geq 1.0D_b$. Normal weight concrete as well as no transverse reinforcing are assumed.

2. Standard 90° hook embedment lengths are based on bar side cover $\geq 2-1/2"$ and bar end cover $\geq 2"$ without ties around hook.

3. For special seismic considerations, refer to ACI 318 Chapter 21.

4. All tension splices shall be Class "B" splices unless noted otherwise on plans.

G. All Welded wire fabric shall be lappe 12" or 48 wire diameters, whichever is greater.

H. Provide (2) #5x6'-0" diagonals at all corners of openings and re-entrant corners, unless noted otherwise.

I. Dowels between foundation and walls shall be installed and shall be the same grade, size, and spacing as the vertical reinforcing, unless noted otherwise.

J. Provide corner bars to match longitudinal reinforcing in all footings. Provide (2) corner bars at tie intersections.

2. Slabs and Slabs-on-grade

A. All slabs on grade to be reinforced with 6x6-W2.1xW2.1 welded wire fabric, unless noted otherwise.

All construction shall comply with applicable provisions of the following latest ACI standards:
 A. ACI 530/ASCE 5/OTMS 402 – Building Code Requirements for Masonry Structures
 B. ACI 530.1ASCE 6/TMS 602– Specifications for Masonry Structures.
 C. IBC Chapter 21 Masonry

2. Concrete block units shall conform to the requirements for Grade N Type 1, load-bearing normal-weight units per ASTM C-90.
 Use Grade S blocks below grade. All below grade block shall be solid grouted.

3. Net area compressive strength of masonry, $f_m = 2,500$ psi
 Standard units shall have nominal face dimensions of 16 x 8 inches high. The minimum compressive strength of the masonry units shall be as follows:

Net Area Compressive Strength of Masonry (f_m)	Net Area Compressive Strength of Concrete Masonry Units (psi)	
	Type M or S mortar	Type N mortar
2,500	3,250	4,350

5. Mortar for unit masonry shall be proportioned per ASTM C270. The minimum mortar compressive strength is as follows:
 A. Type N: 750 psi
 B. Type S: 1,800 psi
 C. Type M: 2,500 psi

6. Grout for unit masonry shall be proportioned per ASTM C476. The minimum grout compressive strength is the larger of 2,000 psi or f_m . Maximum coarse aggregate size is 3/8".

7. Reinforce all CMU walls with vertical rebar full height, centered in cell as shown on the drawings. Grout reinforced cells solid.

8. All vertical cells to be filled shall have vertical alignment to maintain an unobstructed cell area not less than 2 in. x 3 in.

9. All bond beams shall be grouted solid and reinforced.
 A. Provide bond dowels and all wall intersections – one per bond beam at corners, and two at tee intersections. Provide bond beams at all walls supporting roof and floor slabs.

10. Grout three courses of CMU supporting steel. Top course shall be a bond beam.

11. Grout solid under all beams and lintels for full height of wall.

12. All masonry walls shall have ladder type horizontal joint reinforcement with 2 nine gauge wires spaced at 16" o.c. vertically, unless noted otherwise.
 A. All wall intersections shall be reinforced with prefabricated tee or corner units.

14. Use low lift method of grouting. Max grout lift = 5'-0". Alternate methods of grouting may be acceptable. Submit method for approval 2 weeks in advance.

15. Masonry reinforcing lap lengths shall be as follows:

Masonry Strength, f_m (psi)	
Bar Size	2,500
#3	12"
#4	16"
#5	24"
#6	46"

B. Submit tracing plan for review.

17. When grouting is stopped for more than one (1) hour, horizontal construction joints shall be formed by stopping the pour of grout 1'-1/2" below the top of the uppermost course.

18. Conduit pipes and sleeves in masonry shall not displace more than 2 percent of the net cross sectional area, and shall be placed no closer than 3 diameters or widths on center.

19. Vertical control joints in masonry shall be 3/8" wide, full height of wall at locations shown on the architectural drawings. Joints shall be spaced at a maximum of 25 ft. apart and coordinated with the architect. All horizontal joint reinforcing shall be discontinuous through the joint.

20. All doors and windows shall have headers installed per the standard masonry details on sheet S201.

a. **Sawn lumber**

1. Sawn lumber shall be grade stamped and visually graded with maximum 19% moisture content
2. All members shall be strength requirements in NDS "National Design Specification for Wood Construction".
3. Joists, rafters, and nailers with nominal depth 8" or less shall be Southern Pine (SP) or Douglas Fir-Larch (DFL), No. 2 or better.
4. Joists, rafters, and nailers with nominal depth greater than 8" shall be Southern Pine (SP) or Douglas Fir-Larch (DFL), No. 1 or better.

b. **Structural Composite Lumber**

1. SCL shall meet material specifications in ASTM D5456
2. SCL shall include laminated veneer lumber (LVL), laminated strand lumber (LSL), oriented strand lumber (OSL) and parallel strand lumber (PSL)
3. All LVL shall be stress class 2.0E-2600Fb
4. Other SCL materials shall be graded as indicated on the plans.

c. **Structural Panels**

1. All plywood or oriented strand board (OSB) panels shall meet the strength requirements in Department of Commerce (DOC) PS 1 and PS 2 or ANSI/APA PRP 210.
2. All structural panels (walls, floor and roof) shall meet the Structural 1 grading standard

d. **Connectors and Fasteners**

1. Metal connectors and associated fasteners used for the applications indicated shall meet the following minimum standards:
 - a. **Untreated Lumber**
 - a. Connectors ASTM A653 G90
 - b. Bolts and Anchor Rods ASTM F1554 G36
 - c. Nails and Staples ASTM F1667
 2. **Sodium Borate (SBX) Pressure Treated Lumber**
 - a. Connectors ASTM A653 G90
 - b. Bolts ASTM A307
 - c. Anchor Rods ASTM F1554 Gr 55
 - d. Nails and Staples ASTM F1667 with A153 Hot Dipped Galvanized
 3. **All Other Pressure Treated Lumber** (e.g. ACQ-C, ACQ-D, CA-B, CBA-A, ACZA)
 - a. Connectors AISI SS Type 304 or 316
 - b. Bolts ASTM A193, GrB7
 - c. Anchor Rods ASTM A193, GrB7
 - d. Nails and Staples ASTM F1667 using AISI Type 304-D, 316 Stainless Steel
2. Fasteners utilizing dissimilar materials are prohibited.
3. Power driven fasteners shall comply with NES ENR 272.
4. Fastener installation whether power driven or otherwise shall be in accordance with the Building Code and the manufacturer's recommendations. In general fastener heads shall be installed nominally flush with the outer ply of the connection. Sheathing and support framing damaged by overdriven fasteners shall be removed and replaced.
5. Aluminum fasteners and flashing shall not be in contact with pressure treated lumber.

3. **General**

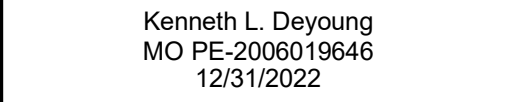
- a. All light framed wood construction shall be constructed as indicated on the plans.
- b. All framing in direct contact with water, soil, concrete, masonry, or permanently exposed to weather shall be preservative treated lumber in accordance with the AWPA Standard U1 and M4
- c. All wood shall be stored on site and protected from the elements to prevent warping, cupping, bowing, crooking and twisting. Use any material that is straight. All stored wood shall be held off the ground with sacrificial damage blocks.
- d. All multi-ply beams, joists and headers shall be fastened together.
 1. Fasten sawn lumber members per schedule below.
 2. Fasten structural composite lumber per manufacturer's literature.
- e. Standard cut washers shall be used under bolt heads and nuts bearing against wood, unless noted otherwise per shear wall anchorage details.
- f. Wood fasteners shall bear on the full width of supporting members (stud walls, beams, nailers, etc.) unless noted otherwise.
- g. Subject to compliance with the project requirements, wood connectors, joist hangers, post caps and bases, holdowns, and related hardware shall be manufactured by Simpson Strong-Tie Company, Inc. San Leandro, CA.
- h. Contractor shall follow the manufacturer's latest recommendations for installation of connectors.
- i. Other manufacturers may be acceptable. Submit substitution request demonstrating that the proposed hardware has the same or greater capacity for each connection. Allow two weeks for review.

4. **Wood Roof Trusses**

- a. Provide wood trusses capable of withstanding the design loads within the limits and under the conditions indicated. Truss design shall be in accordance with the Building Code and TPI-1 Nation Design Standard for Metal Plate Connected Wood Truss Construction.
- b. Wood trusses shall be of sawn lumber with 2x nominal thickness.
- c. In addition to the loads indicated, wood trusses shall be designed for all applicable wind, seismic, and snow (including drift) loads required by Building Code and noted in plan. Truss design and shop drawing preparation shall be supervised by a registered professional engineer licensed in the state where the project is located.
- d. Truss members shall be signed and sealed and include comprehensive truss layout plans, design calculations that indicate species and grades of lumber, design stresses, size and type of connector plates used.
- e. Fabrication and detailing of trusses shall be brought to the immediate attention of the Structural Engineer and truss supplier. Bearing points shall coincide with intersections of diagonals and chords.
- f. Truss member design shall consider unbalanced snow load with full dead load, as well as, full dead and snow load.
- g. Roof trusses shall be designed for the following:
 1. Dead load = 20 psf (10 psf top chord, 10 psf bottom chord)
 2. Roof Live load = 20 psf, on the top chord (horizontal projection)
 3. Roof Snow Load Balanced = 17 psf
 4. Roof Snow Load Unbalanced = 5 psf windward, 32 psf leeward from ridge to 5'-0", 17 psf leeward from 5'-0" to eave
 5. Wind uplift = -21 psf (normal to roof slope)
 6. End / Gable Wind Load = 5 psf
- h. The maximum allowable deflection shall be:
 1. Roof Trusses: Total Load / L/240, Roof Live or Snow Load / L/360
- i. The manufacturer shall provide all open web trusses and accessories as shown on the structural and architectural drawings and as required for a complete project.
- j. All truss to truss connections and truss to supporting member connections shall be designed and detailed by the truss supplier and the size and type of connectors included in the shop drawing submittal. Coordinate size, species and grade of supporting chord and web members with the truss supplier.
- k. All temporary and permanent bracing shall be in accordance with the TPI standards for bracing. The bracing shall be furnished and installed by the Contractor. Do not use ceilings as uplift bracing at truss bottom chord.
- l. Girder trusses shown on drawings shall be designed to carry concentrated reactions from supported members.
- m. Wood trusses shall be handled and erected in accordance with TPI H18-91. Trusses shall be unloaded and stored in bundles in an upright position out of contact with the ground until ready for installation.
- n. Any damage to the trusses shall be brought to the immediate attention of the Structural Engineer and truss supplier. Field repair and modification of trusses shall not be made with prior written approval from the supplier, except for nominal trimming to correct length where such trimming will not impair the load carrying capacity of the truss.



MISSOURI CERTIFICATE OF AUTHORITY
NO. E-2006023253
EXPIRES: DECEMBER 31, 2022

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PROJECT NUMBER		SET ISSUE DATE
2022000005		4/18/2022
ENGINEER	DRAWN BY	CHECKED BY
JAV	JAV	KLD

PLATTE RIDGE PARK
FOOTBALL COMPLEX IMPROVEMENTS
17130 HIGHWAY 371, PLATTE CITY, MO 64079

GENERAL NOTES

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DRAWING NO.
S001



PEARSON KENT MCKINLEY RAAF ENGINEERS LLC
1330 W 9TH STREET LENEXA, KS 66151
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MO State Certificate of Authority #E-2002020886



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EXPIRES: DECEMBER 31, 2022



Kenneth L. Deyoung
MO PE-2006019646
12/31/2022

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No.	Description	Date
	Issued For Permit	04/18/2022


PROJECT NUMBER 2022000005	SET/ISSUE DATE 4/18/2022
ENGINEER JAV	DRAWN BY JAV
CHECKED BY KLD	
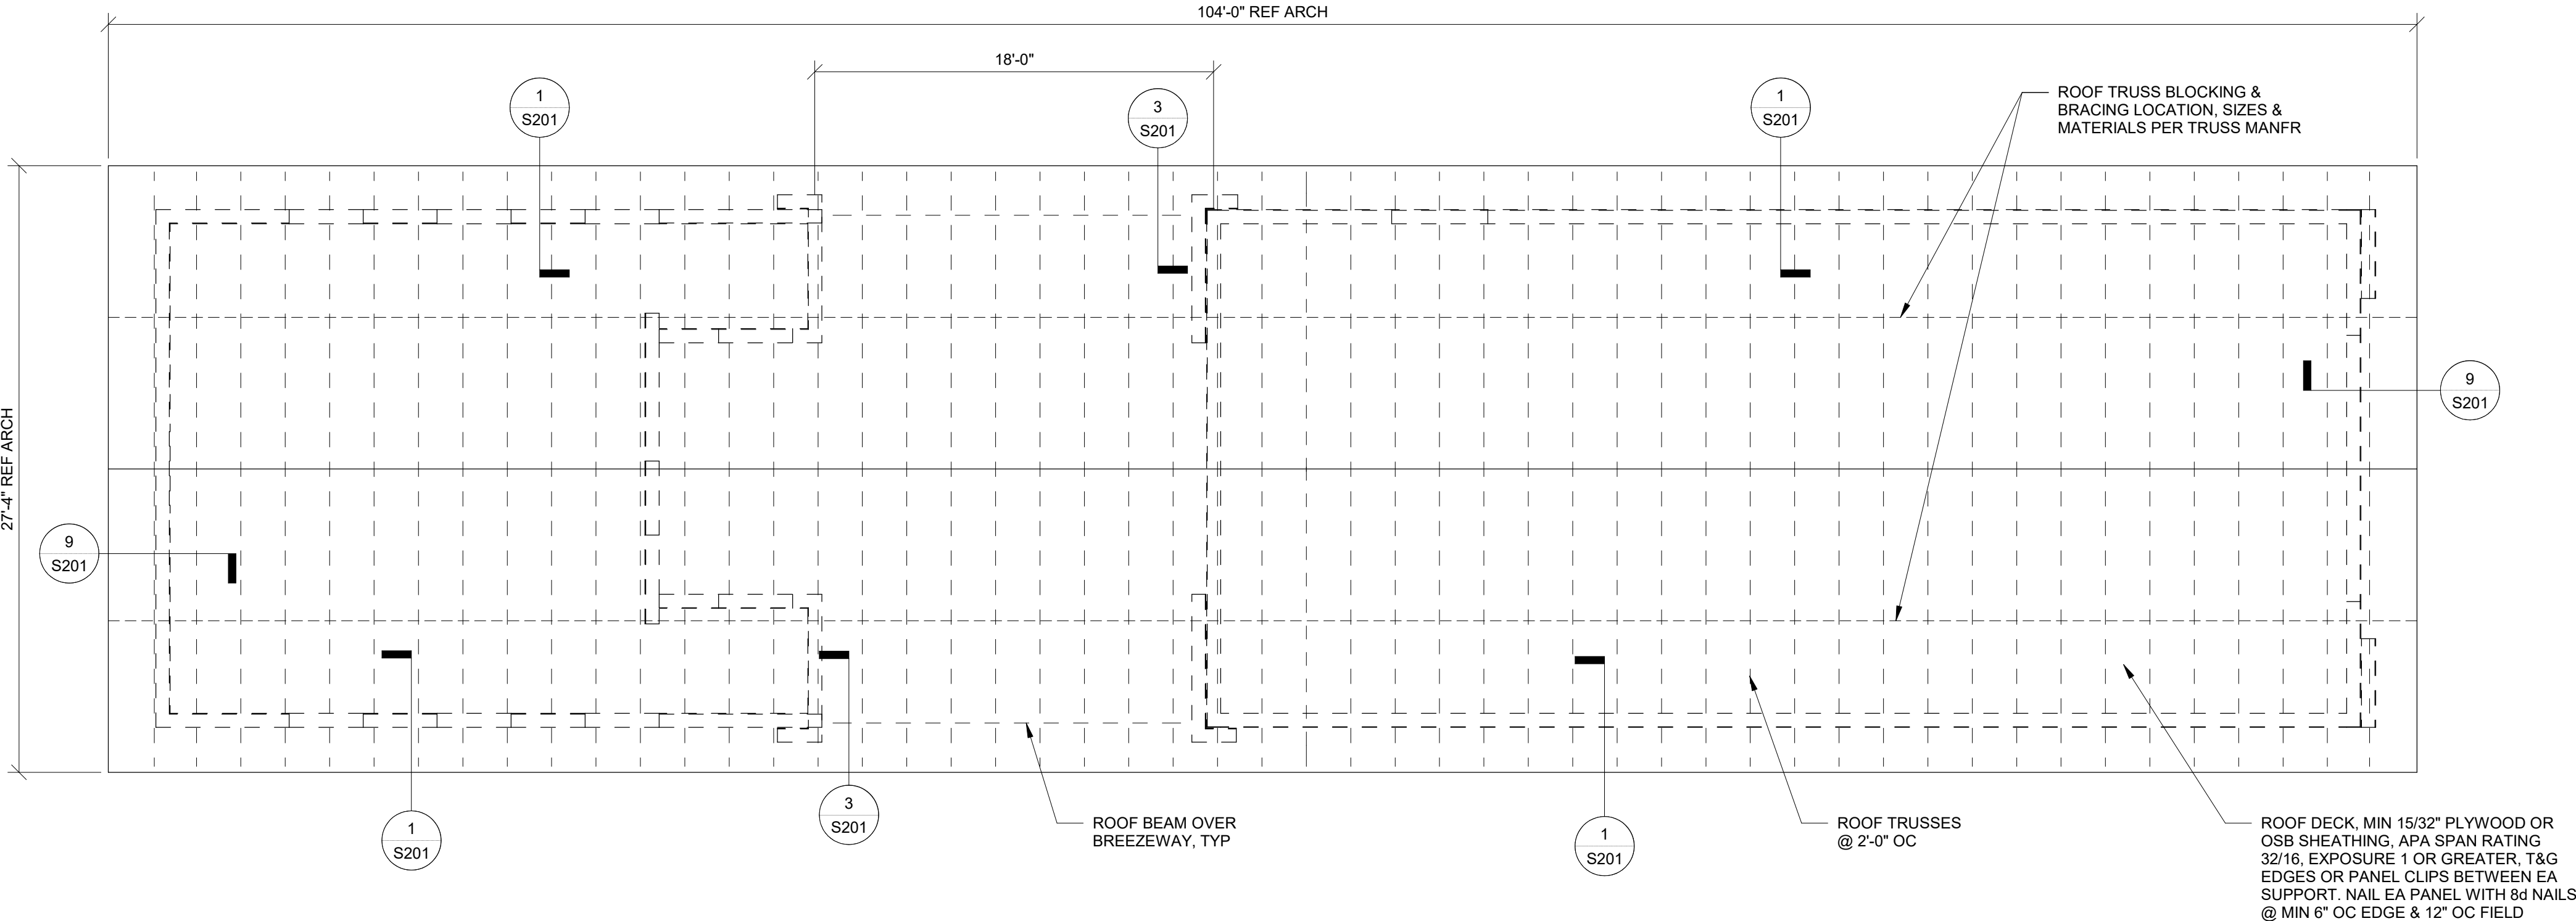
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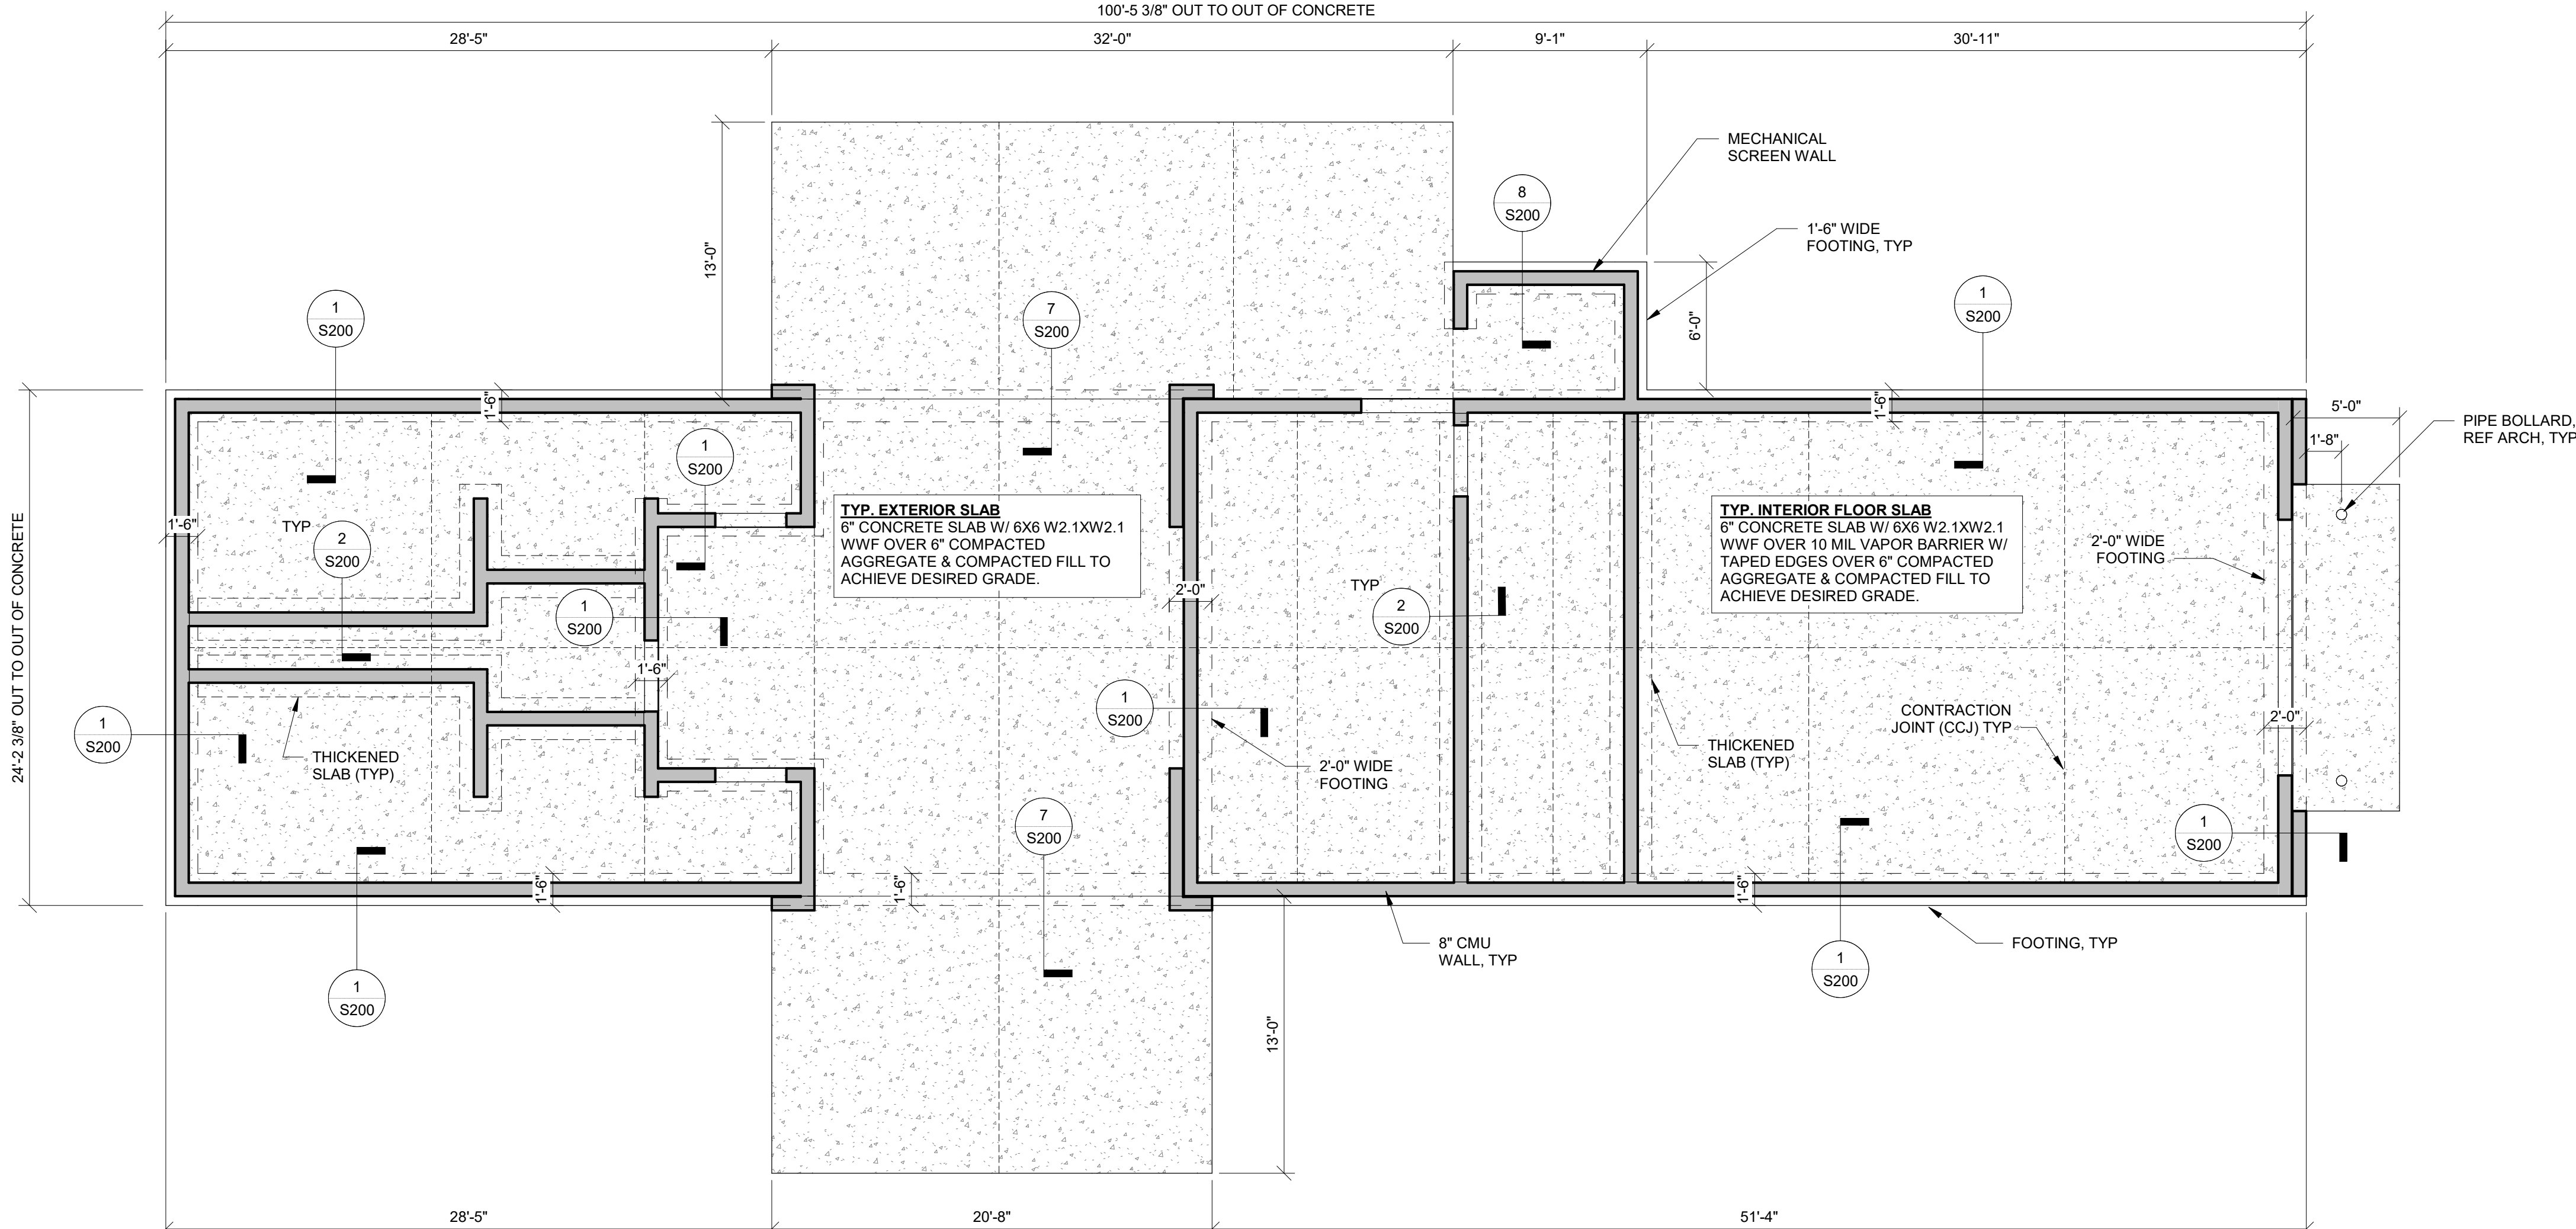
FOUNDATION AND ROOF FRAMING PLANS

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DRAWING NO.
S100



2 ROOF FRAMING PLAN
3/16" = 1'-0"



1 FOUNDATION PLAN
3/16" = 1'-0"



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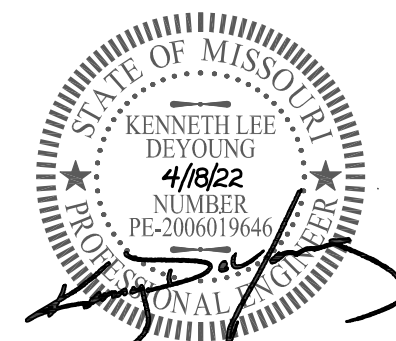
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ENGINEER JAV	DRAWN BY JAV
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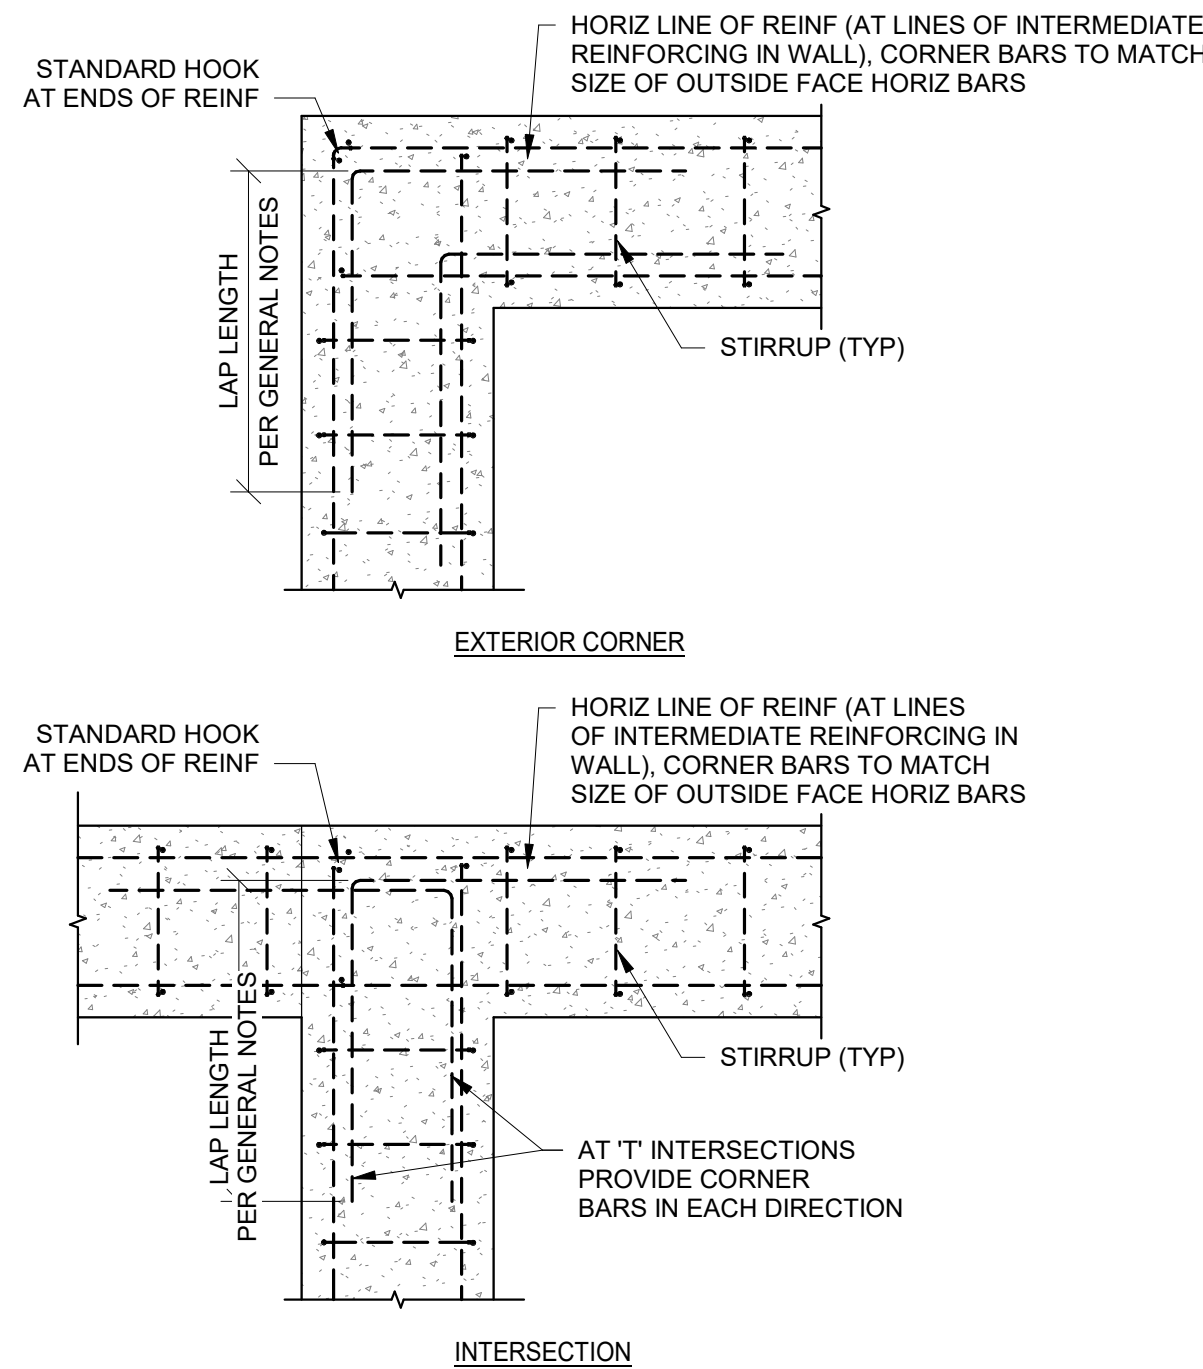
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FOUNDATION SECTIONS AND DETAILS

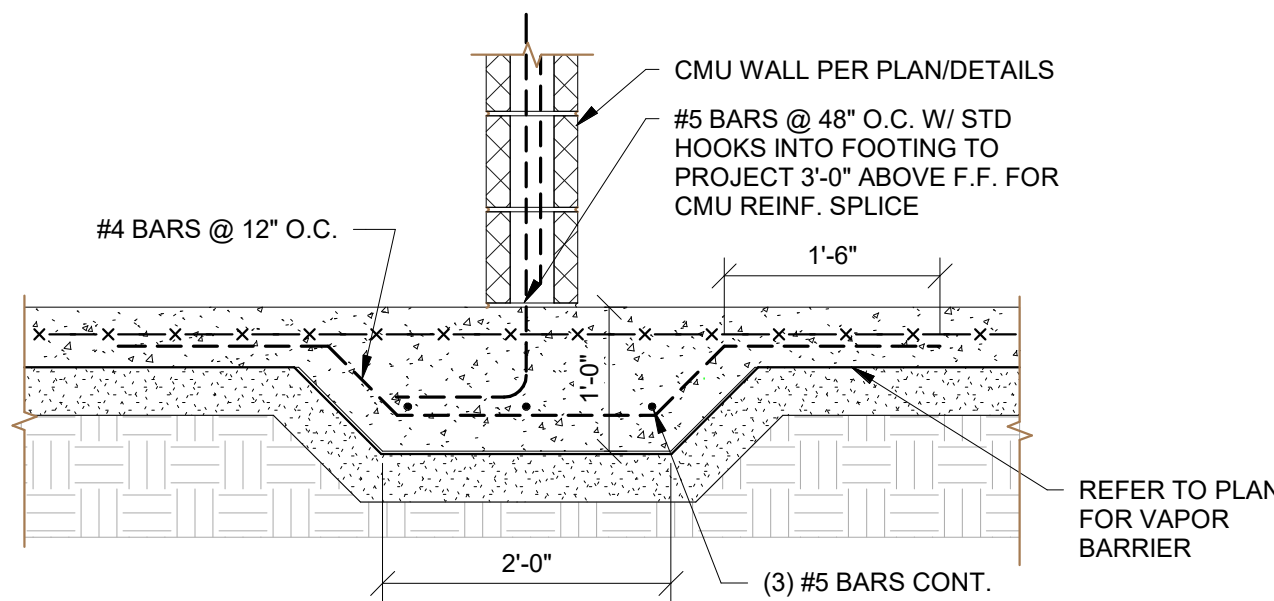
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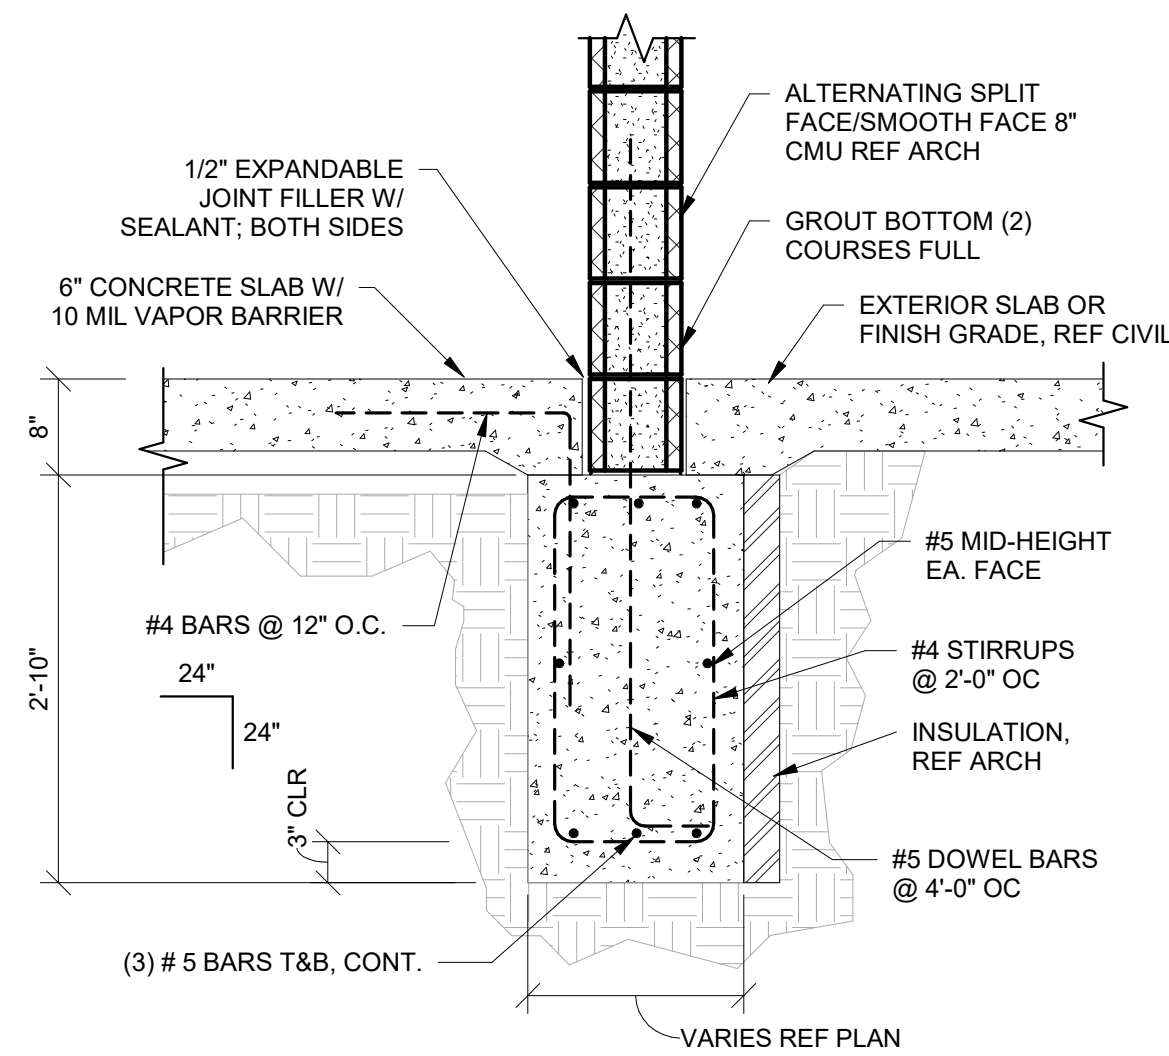
S200




30 GRADE BEAM INTERSECTION
S200 1/2" = 1'-0"




2 THICKENED SLAB
S200 3/4" = 1'-0"



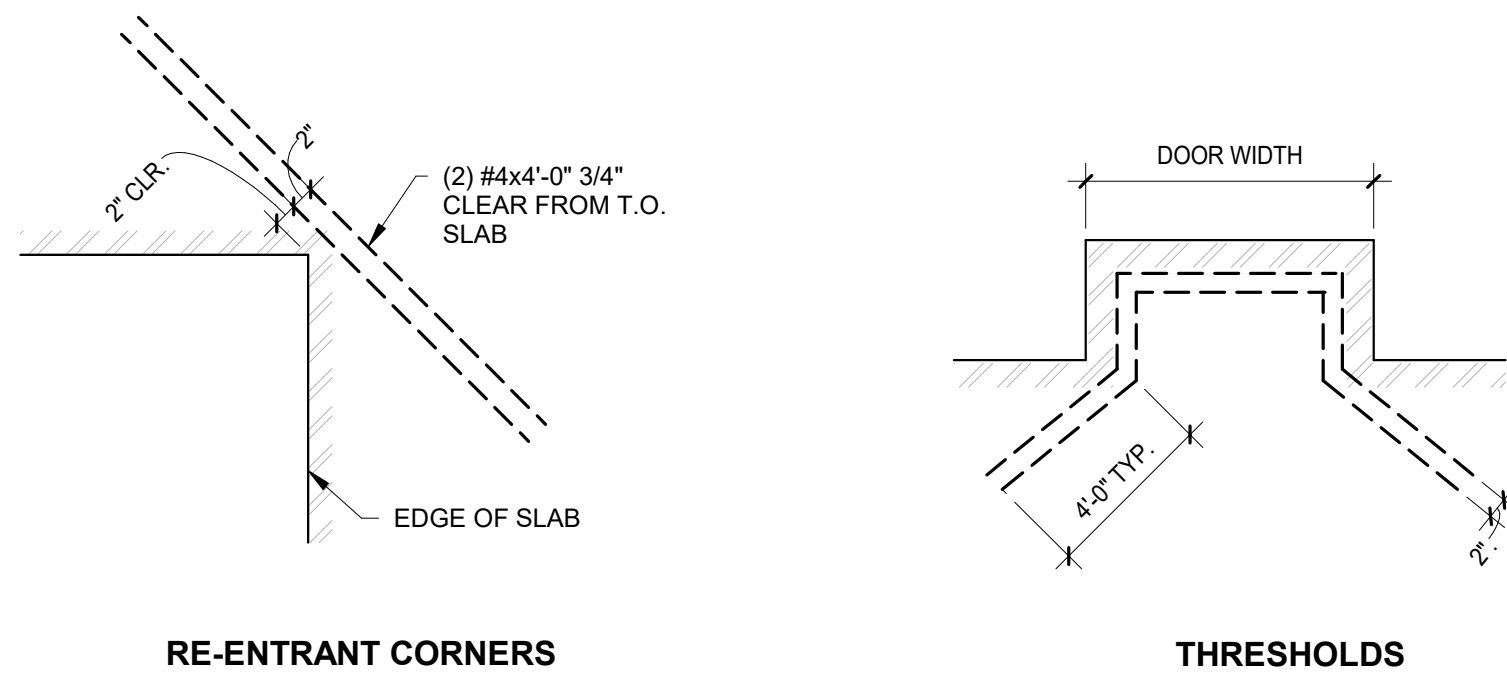1 TYPICAL FOUNDATION SECTION
S200 3/4" = 1'-0"




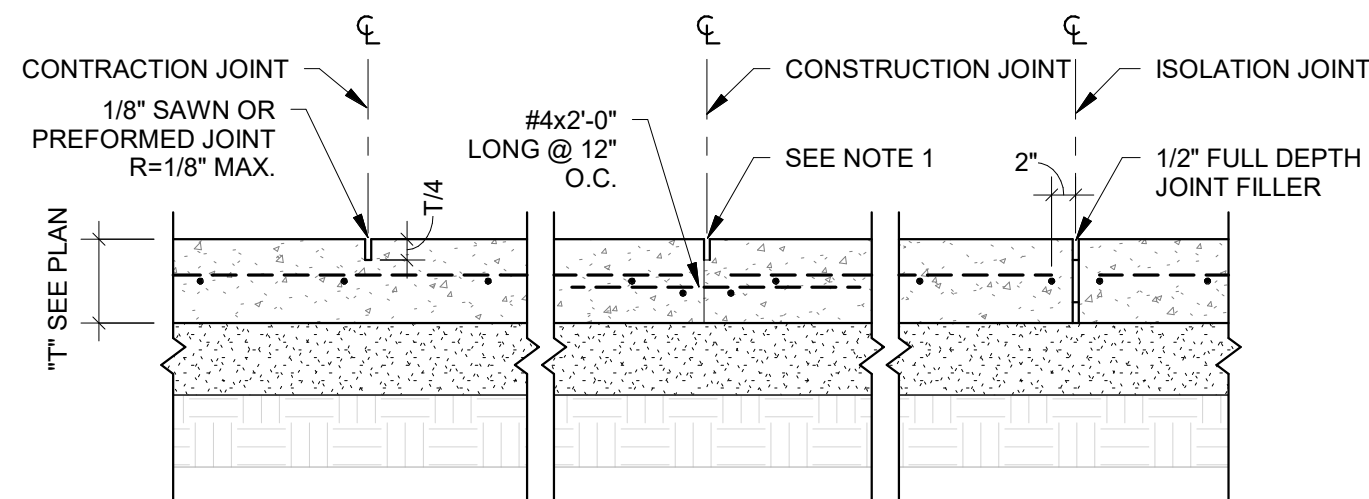6 ADDITIONAL REINFORCING IN SLABS
S200 3/4" = 1'-0"




NOTES:
1. LOCATE CONSTRUCTION JOINTS AT SAW JOINT LOCATIONS IF SHOWN ON PLAN. LOCATE AT WALLS AND COLUMN LINES WHERE POSSIBLE.
2. MAXIMUM SPACING BETWEEN SAW JOINTS = 15'-0" FOR 6" SLABS & 10'-0" FOR 4" SLABS.
3. CONTINUE SLAB ON GRADE REINFORCING, UNO, PROVIDE TENSION LAP SPLICE PER NOTES.
4. DO NOT PLACE DOWELS WITH IN 12" OF A SLAB CORNER.

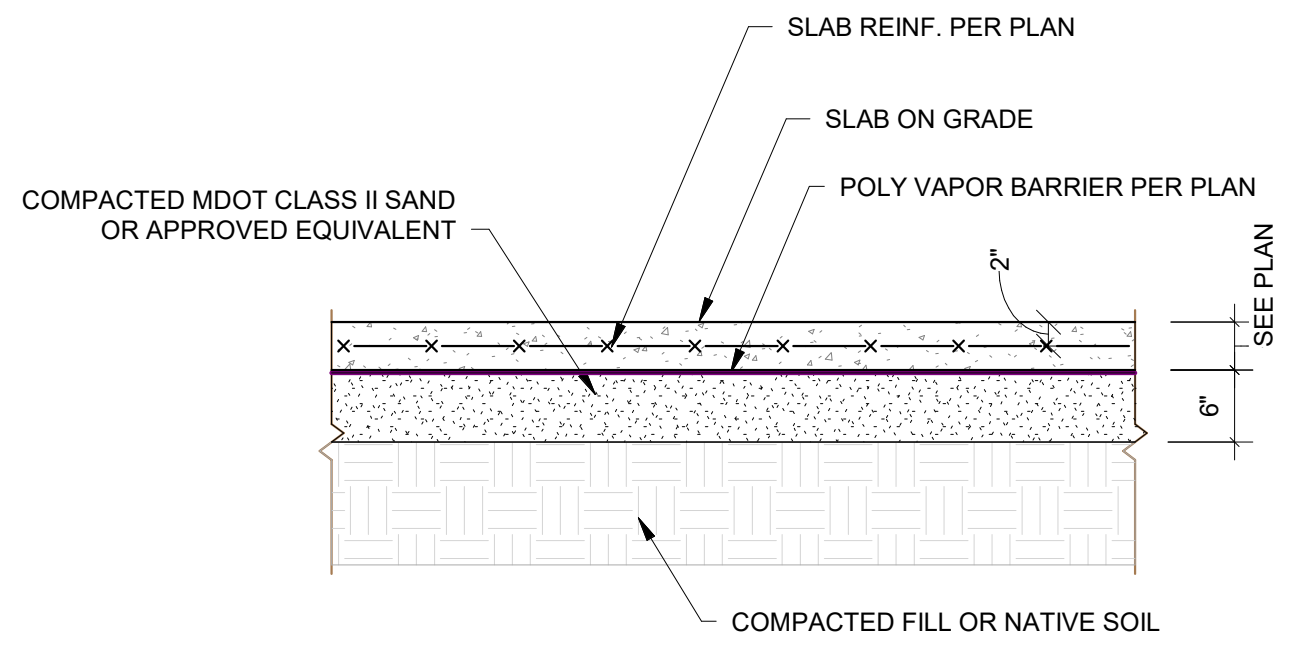5 SLAB JOINTS
S200 3/4" = 1'-0"




NOTES:
1. PROVIDE CONTINUOUS PROTECTION AGAINST WATER INFILTRATION PRIOR TO INSTALLATION OF VAPOR BARRIER & POROUS SUB BASE. MAINTAIN VAPOR BARRIER & SUB BASE IN DRY CONDITION UNTIL BUILDING IS OCCUPIED.




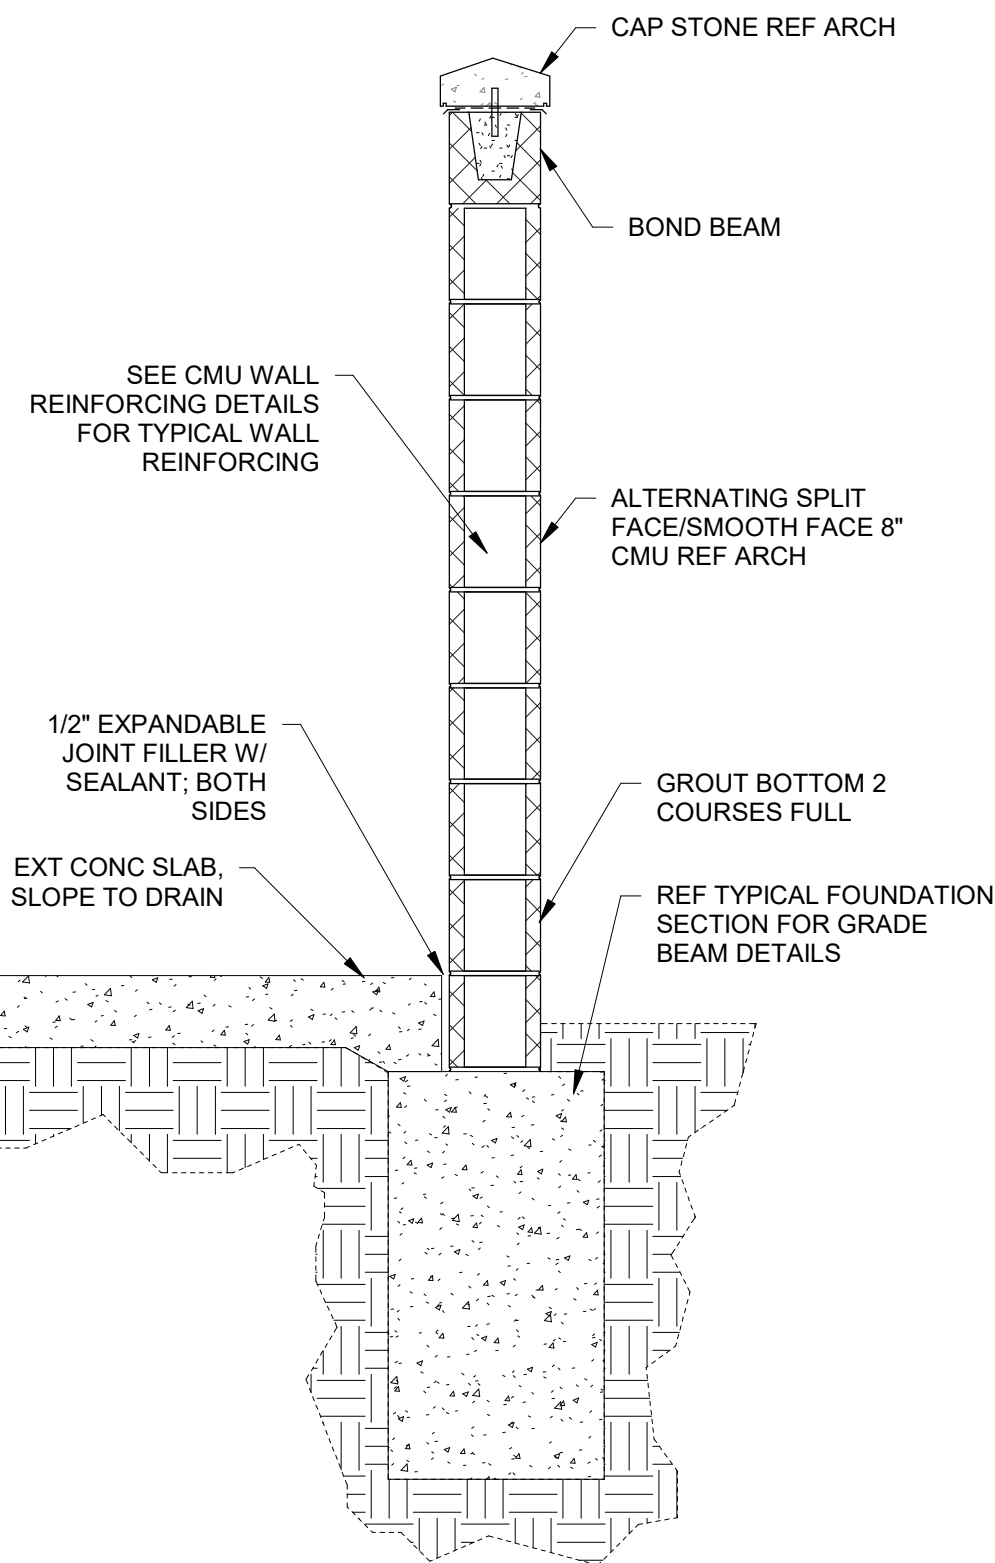
4 TYPICAL SLAB DETAIL
S200 3/4" = 1'-0"



8 SCREEN WALL SECTION
S200 3/4" = 1'-0"

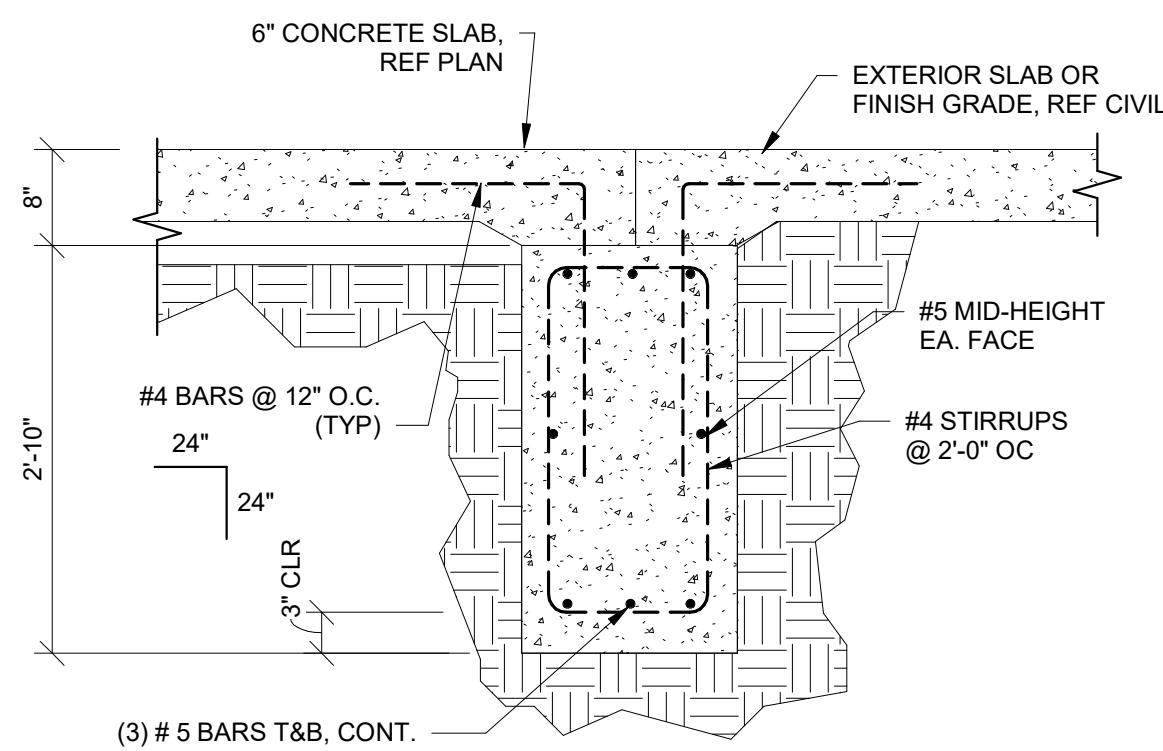

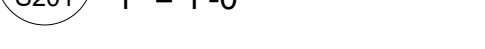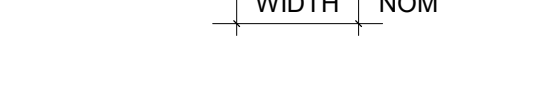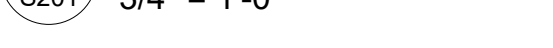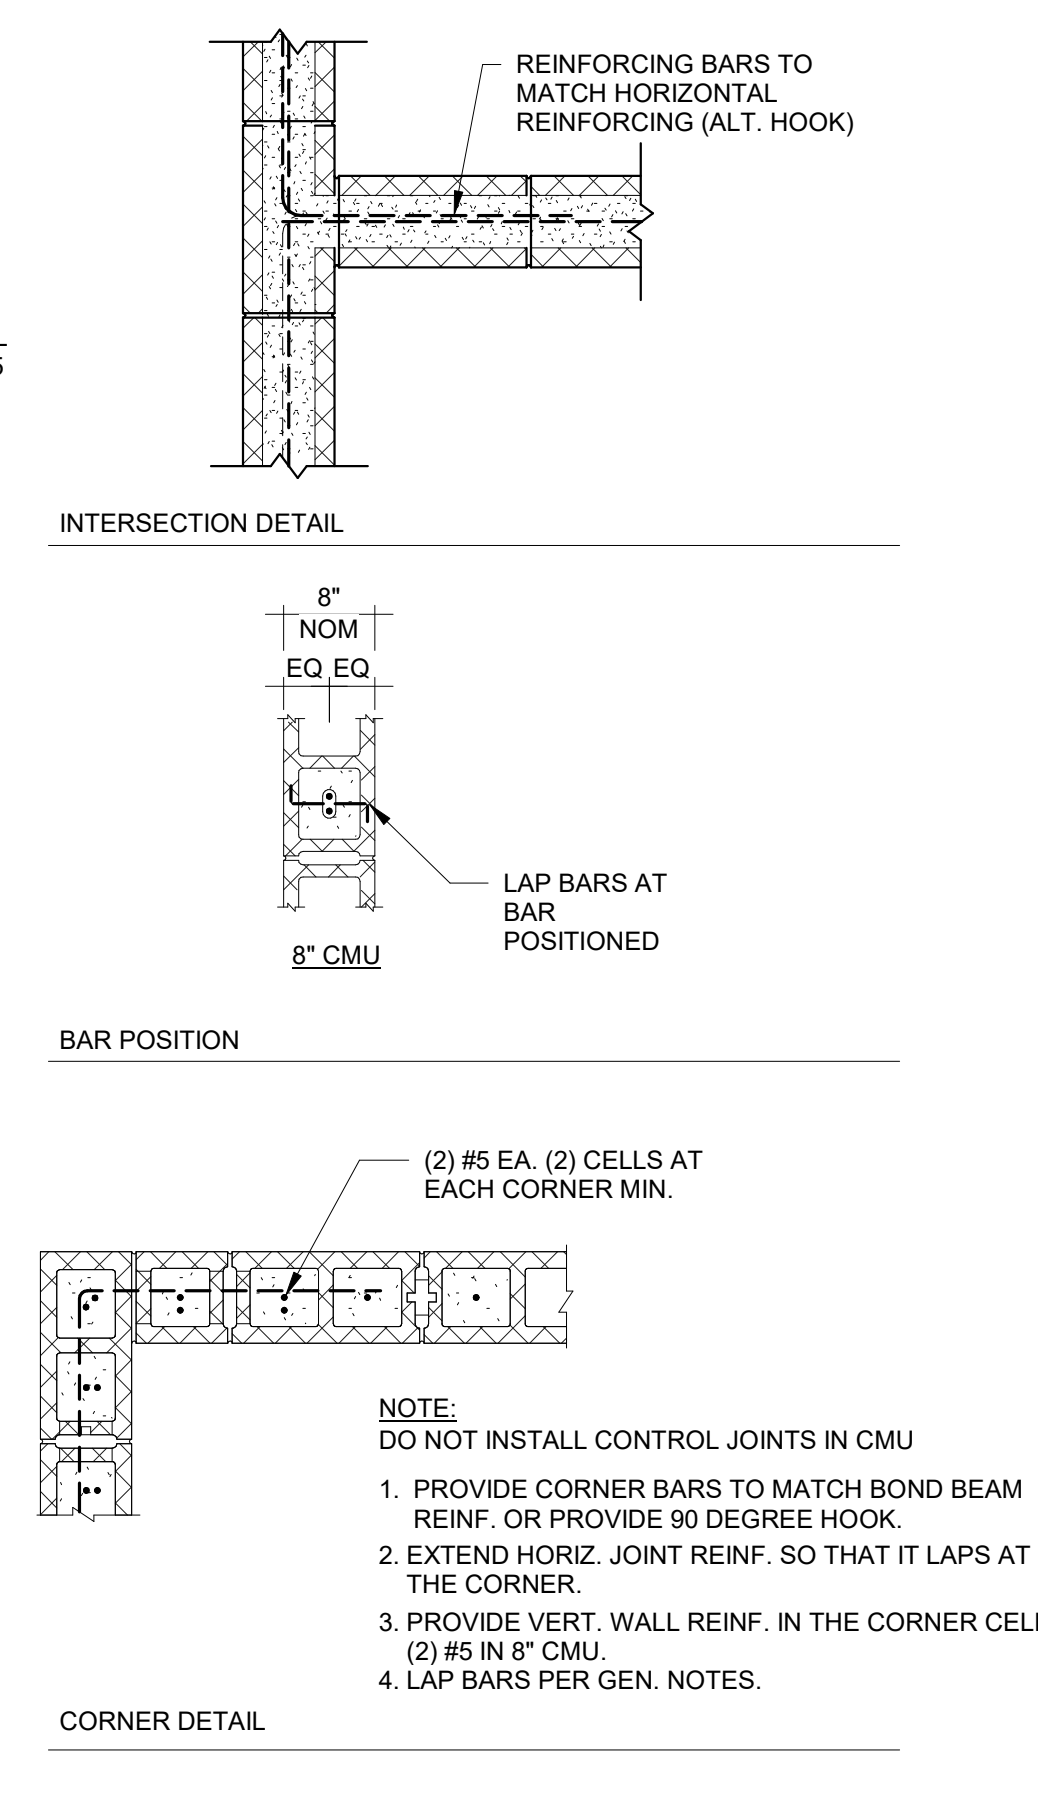7 FOUNDATION SECTION @ BREEZEWAY
S200 3/4" = 1'-0"



- CMU JAMB DETAIL
- NOTES:
1. SPLICES IN VERT REINF. SEE GENERAL NOTES
 2. BOND BEAM, SEE CMU GENERAL NOTES
 3. EXTEND GROUDED LINTEL A MINIMUM OF 2'-0" BEYOND FACE OF OPENING EACH SIDE FOR STRAIGHT LINTEL REINF AND 1'-4" FOR LINTEL REINF WITH STANDARD ACI HOOK.
 4. USE LINTEL BLOCKS ONLY FOR BOTTOM COURSE OF LINTEL BEAMS OVER OPENING.
 5. CONTINUE VERT WALL REINF OVER OPENING, ANCHOR VERT REINF INTO LINTEL BEAM WITH STANDARD ACI HOOK.
 6. ALL VERT BARS AT CMU JAMB TO EXTEND FULL HEIGHT OF WALL EACH LEVEL.
 7. WHERE HORIZONTAL REINFORCING IS TERMINATED BY OPENING OR CONTROL JOINT, PROVIDE STANDARD ACI HOOK WITH VERTICAL WALL REINFORCING IN THE END CELL.
 8. PROVIDE 2-#5 AT BOTTOM OF ALL OPENINGS ABOVE FINISH FLOOR. EXTEND MINIMUM OF 2'-0" BEYOND FACE OF OPENING EACH SIDE FOR STRAIGHT REINFORCEMENT AND 1'-4" FOR HOOKED REINFORCEMENT WITH STANDARD ACI HOOK.
 9. PROVIDE (2) #5 BAR IN BOND BEAM AT SILL LOCATIONS.
 10. ALL LINTELS 16" DEEP W/ (2) #5 BARS U.N.O.



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NO. E-2006023253
EXPIRES: DECEMBER 31, 2008



I HEREBY CERTIFY THAT THIS
ENGINEERING DOCUMENT WAS
PREPARED BY ME OR UNDER MY
DIRECT PERSONAL SUPERVISION AND
THAT I AM A DULY
LICENSED PROFESSIONAL ENGINEER
UNDER THE LAWS OF THE STATE OF
MISSOURI.

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PROJECT NUMBER		SET ISSUE DATE
2022000005		4/18/2022
ENGINEER	DRAWN BY	CHECKED BY
JAY	JAY	K.D.

PLATTE RIDGE PARK
FOOTBALL COMPLEX IMPROVEMENTS
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SECTIONS AND DETAILS

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S201